
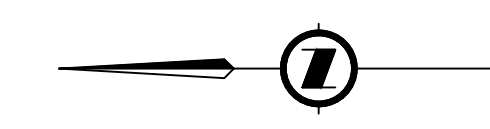


FILE: Z:\SPECIALTY CONTRACT_SEED_DIRECTORIES\CONSTRUCTION DRAFTING STANDARDS AND TEMPLATES\DEV\SMPL-EXP-UPRODUCT\12345678C-101.DWG | DATE: Monday, November 21, 2022 1:22:33 PM

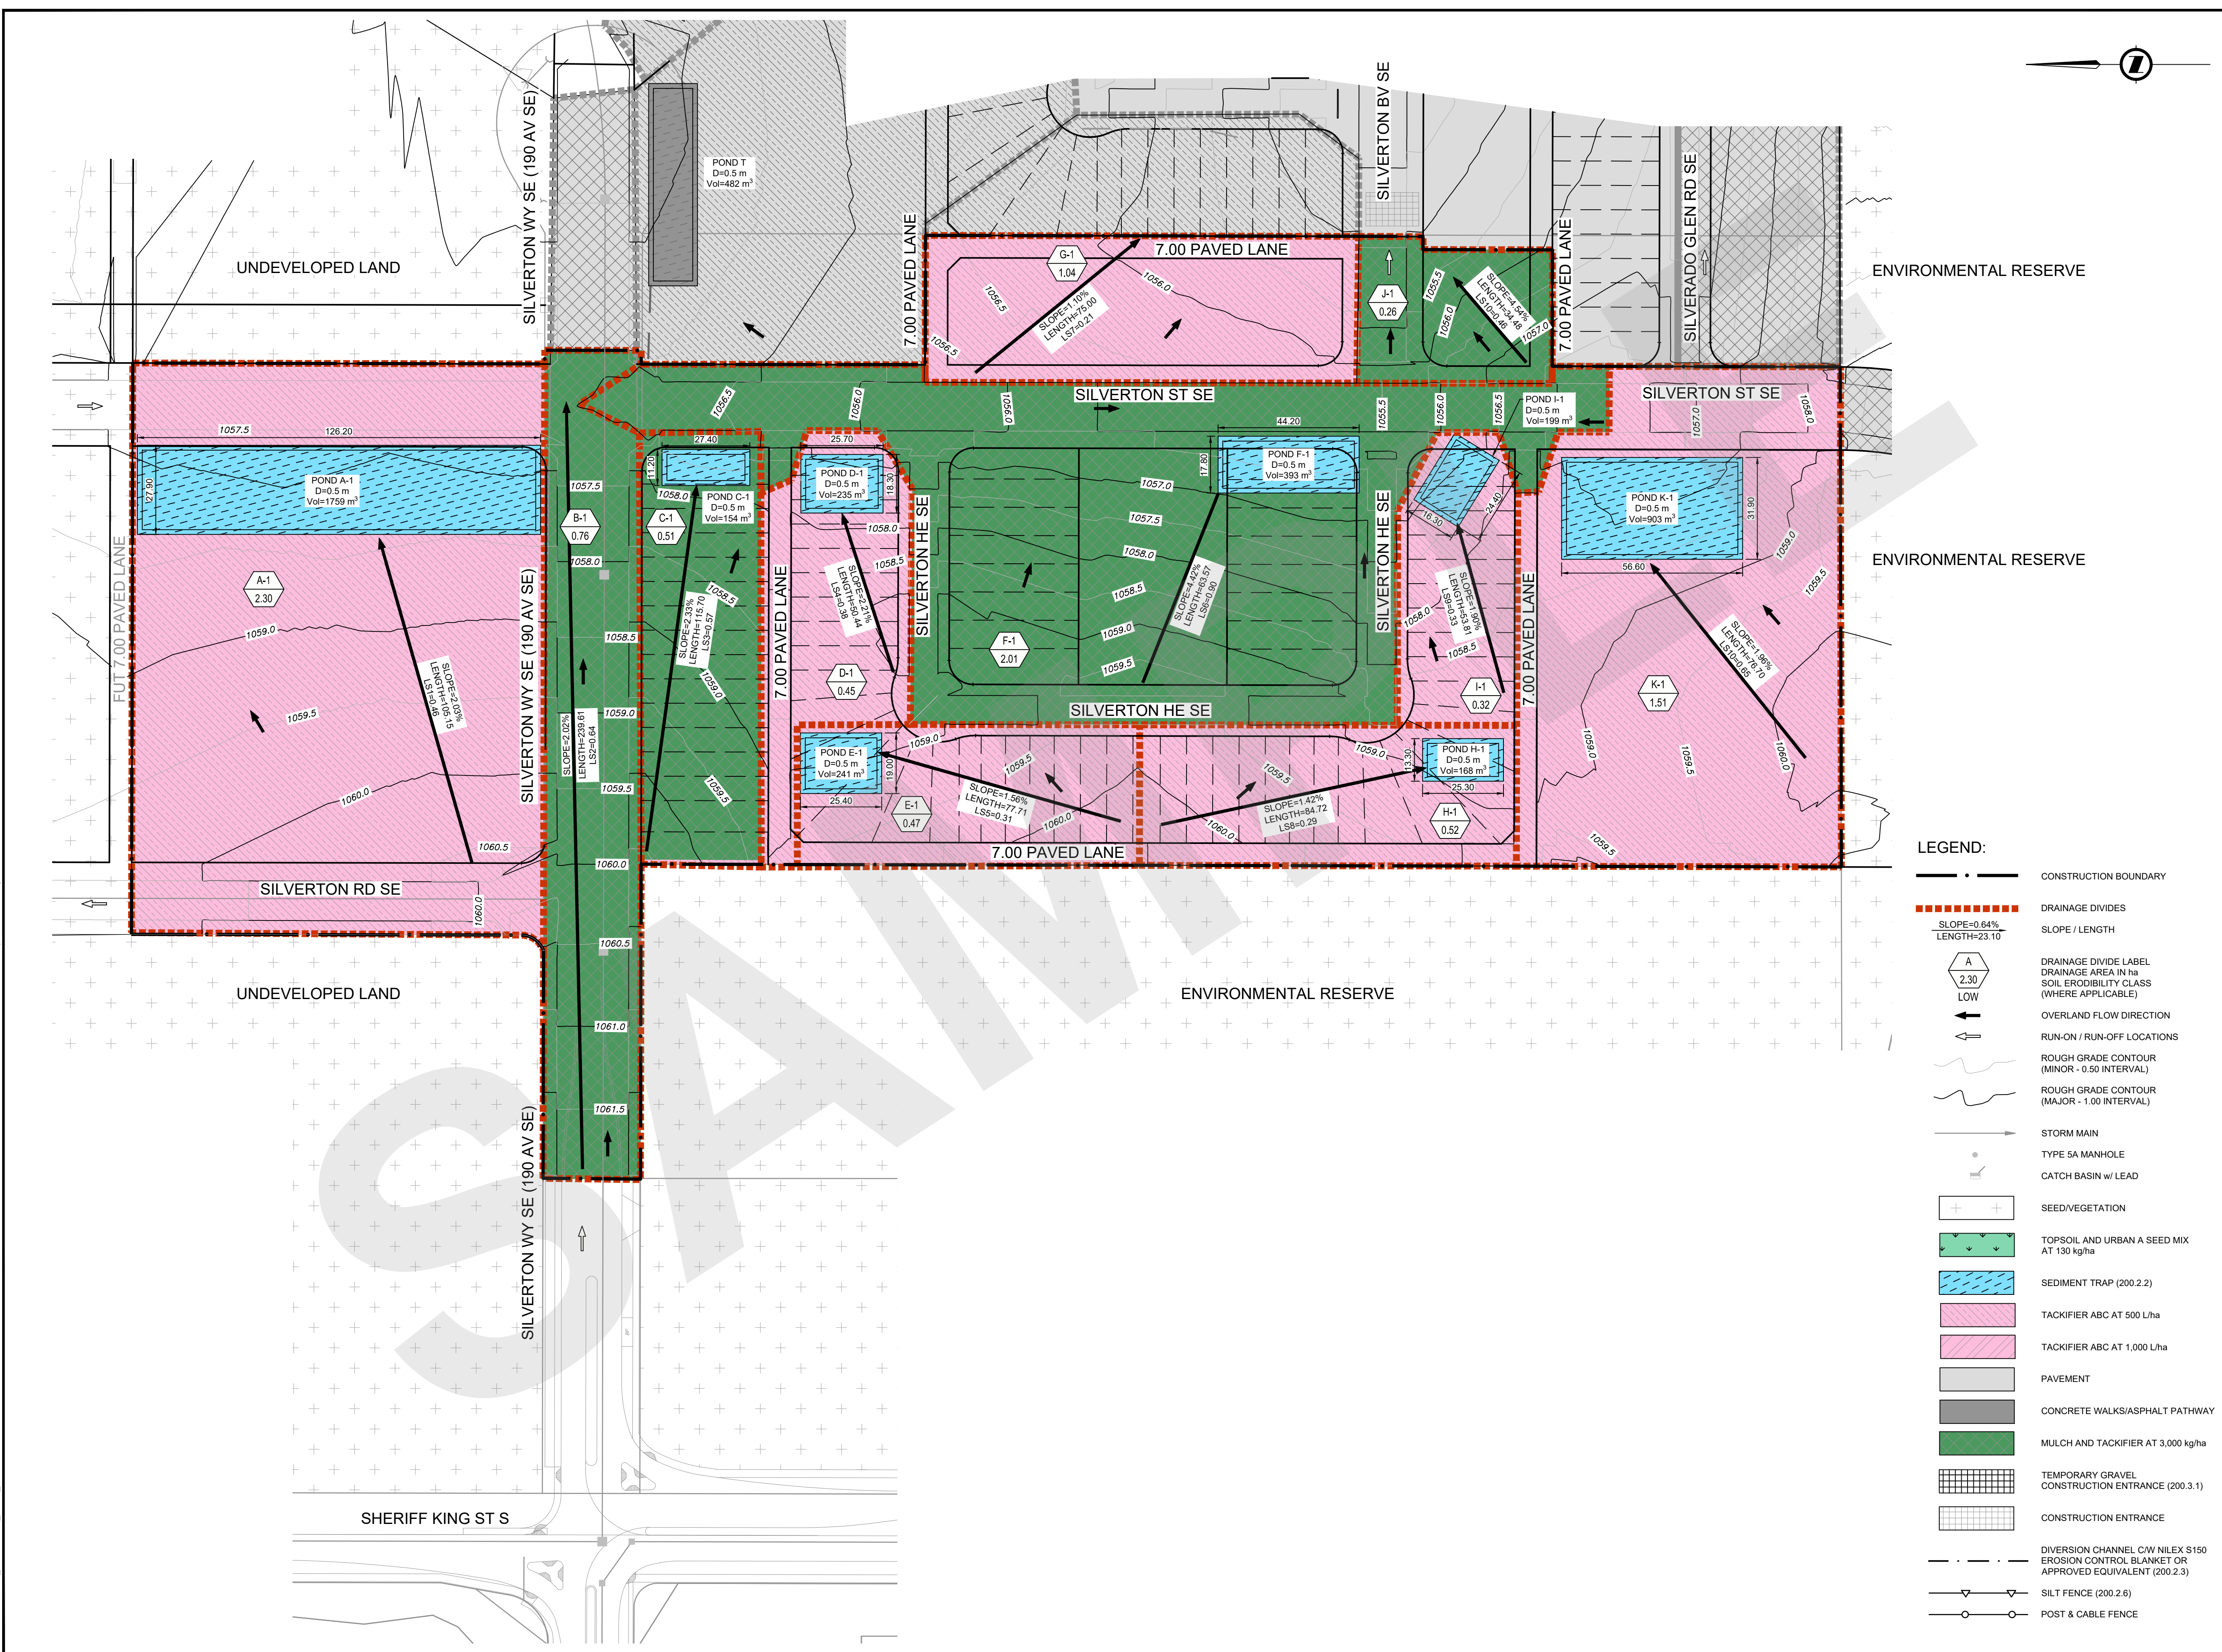

NOTES

1. ALL PIPE SIZES ARE IN MILLIMETRES AND ALL DIMENSIONS ARE IN METRES UNLESS OTHERWISE NOTED.
2. ALL COORDINATES AND DISTANCES ARE BASED ON 3TM COORDINATE SYSTEM (NAD 83).

CITY OF CALGARY OFFICE USE



NAD 83
COORDINATES

ESC REVISION TABLE

NO.	DESCRIPTION	DATE (YYYY-MM-DD)	BY	APPD
0	ISSUED FOR ESC REPORT APPROVAL	2018-11-30	RCM	RG

LEGEND:

- CONSTRUCTION BOUNDARY
- DRAINAGE DIVIDES
- SLOPE / LENGTH
- DRAINAGE DIVIDE LABEL
- OVERLAND FLOW DIRECTION
- RUN-ON / RUN-OFF LOCATIONS
- ROUGH GRADE CONTOUR (MINOR - 0.50 INTERVAL)
- ROUGH GRADE CONTOUR (MAJOR - 1.00 INTERVAL)
- STORM MAIN
- TYPE 5A MANHOLE
- CATCH BASIN w/ LEAD
- SEED/VEGETATION
- TOPSOIL AND URBAN A SEED MIX AT 130 kg/ha
- SEDIMENT TRAP (200.2.2)
- TACKIFIER ABC AT 500 L/ha
- TACKIFIER ABC AT 1,000 L/ha
- PAVEMENT
- CONCRETE WALKS/ASPHALT PATHWAY
- MULCH AND TACKIFIER AT 3,000 kg/ha
- TEMPORARY GRAVEL CONSTRUCTION ENTRANCE (200.3.1)
- CONSTRUCTION ENTRANCE
- DIVERSION CHANNEL C/W NILEX S150 EROSION CONTROL BLANKET OR APPROVED EQUIVALENT (200.2.3)
- SILT FENCE (200.2.6)
- POST & CABLE FENCE

DESIGNED	BY	DATE (YYYY-MM-DD)
	RCM	2018-07-09
DRAWN	BY	DATE (YYYY-MM-DD)
	LH	2018-07-09
CHECKED	BY	DATE (YYYY-MM-DD)
	RG	2018-09-01

SCALE 1:1000



PROJECT
**THE CITY OF CALGARY
CONSTRUCTION DRAFTING STANDARDS
AND TEMPLATES
DP2020-1234**
SEC: 22 - TWP: 22 - RGE: 01 - W 5th M

SHEET TITLE
**SUBDIVISION
ESC5, EROSION & SEDIMENT CONTROL
SAMPLE SHEET**

FILE NO. 12345678C-101.dwg	ENG DWG NO.
SHEET ID. C-101	SHEET NO. 001
BY	DATE (YYYY-MM-DD)
DRAWN	PROFILE NO.

THIS DRAWING SAMPLE IS INTENDED TO ILLUSTRATE THE NEW CAD STANDARDS AND ARE FOR REFERENCE PURPOSES ONLY. PLEASE CONFIRM WITH YOUR APPROPRIATE CITY OF CALGARY CONTACT FOR SPECIFIC CONTENT REQUIREMENTS.