

STANDARD
SPECIFICATIONS
STREET LIGHTING CONSTRUCTION

2006

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THE LATEST VERSION OF THE 2006 STANDARD SPECIFICATIONS FOR STREET LIGHTING CONSTRUCTION CAN BE FOUND AT <a href="http://www.calgary.ca/roads">http://www.calgary.ca/roads</a> UNDER THE CONTRACTORS AND CONSULTANTS PAGE.

## **UTILITY AND PIPELINE LOCATION NUMBERS**

Prior to commencement of any work the Contractor shall contact the appropriate agencies listed below to locate the existing underground utilities and pipelines in or adjacent to the construction work site. The utility or pipeline agencies shall be contacted two working days prior to commencement of work.

## **FIELD LOCATION SERVICE CALLS:**

ATCO)	
ENMAX POWER CORPORATION)	ALBERTA 1st CALL
TELUS	
CALGARY WATERWORKS	
CALGARY WASTEWATER & DRAINAGE	
PETROGAS PROCESSING LIMITED	
HOME OIL COMPANY LTD	
PETRO-CANADA (ALBERTA PRODUCTS PIPELINE))	

#### SHAW CABLE 250-8989

PETRO-CANADA (VALLEY PIPELINE) ... 933-4711

## **EXCAVATION PERMITS:**

Excavation Permits shall be obtained from The City of Calgary Land Use & Mobility, 2<sup>nd</sup> Floor of the Calgary Roads Maintenance & Plants Building at 651 – 25 Ave. S.E., prior to excavation in public right of ways.

## **ELECTRICAL PERMITS:**

Electrical Permits shall be obtained from The City of Calgary Building Regulations, 3<sup>rd</sup> Floor Municipal Building 800 MacLeod Trail SE (fax 268-3624) prior to the start of any electrical contract work.

## **EMERGENCY SERVICE:**

If you accidentally damage the coating, scrape, sever or rupture any underground line please call the appropriate emergency number immediately.

Watch for above ground structures such as utility pedestals, power lines and hydrants that are located in roadways, lanes and private property. If they are damaged please report the incident immediately.

## **EMERGENCY CALLS - 24 HRS SERVICE:**

ATCO GAS	245-7222
ENMAX TROUBLE LINE	514-6100
CALGARY WASTEWATER & DRAINAGE, WATERWORKS	DIAL 311
CALGARY ROADS TROUBLE LINE	DIAL 311
TELUS	DIAL 611
SHAW CABLE	250-8989
PETRO-CANADA (ALTA. PRODUCTS PIPELINE EDMONTON	1-800-661-5642
(VALLEY PIPELINE STETTLER)	1-800-661-5642
HOME OIL CO. LTD.	232-5000
PETROGAS PROCESSING	266-0023

## **STREET LIGHTING POWER SUPPLY:**

ENMAX (EPC) – Henry	/ Bandura 514-3700
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# THE CITY OF CALGARY PLANNING & BUILDING DEPARTMENT

# PERMIT FEE SCHEDULE (Building, Electrical, HVAC, and Plumbing & Gas) (Effective 1999 May 07)

Job cost (labour and materials) up to and including \$1,000.

\$35 minimum fee Plus SCC\*

Job cost over \$1,000.

\$35 minimum fee Plus \$6 per \$1,000 Plus SCC\*

To calculate fees, use the following formula (rounding up to the next hundred):

Job Cost\*\* ÷\$1,000 x \$6 + \$35 + SCC\* = Permit Fee

EXAMPLE - Job Cost is \$2,050.00

\$2,100 ÷ \$1,000 x \$6 + \$35 = \$47 + SCC\* = Permit Fee

# \*SCC (Safety Codes Council) surcharge:

Electrical, Plumbing, and Gas permits are subject to a \$3 surcharge. Building and HVAC permits are subject to a \$5 surcharge.

## \*\*Job Cost:

This total includes labour and all materials (customer or contractor supplied).

## 350.00.00 GENERAL

## 350.01.00 SCOPE

This Section covers the requirements for street lighting construction works. Not withstanding any other specification, any deviation from these standards shall constitute non-compliance and may result in the rejection of the work.

The following most current City of Calgary standard documents shall form part of, and shall be read in conjunction with The Specifications:

- Standard General Conditions
- Standard Specifications Roads Construction
- Force Account Rates
- Worksite Temporary Traffic Control Manual
- Contractor Safety Manual
- Development Guidelines and Standard Specifications Landscape Construction
- Design Guidelines for Subdivision Servicing
- Traffic Control Policy Manual

## 350.02.00 WORK REGULATIONS

All electrical work shall comply with the latest edition of the Canadian Electrical Code - Part 1. In addition, any applicable Standata as published by Alberta Municipal Affairs, Electrical Safety Codes, shall apply.

The Contractor shall also conform to all applicable regulations of Alberta Human Resources and Employment (AHRE), Occupational Health and Safety Act (OHSA).

The Contractor shall ensure compliance with OHSA General Safety Regulation 26 (1) – Overhead Power Lines.

## 350.02.01 PREQUALIFIED STREETLIGHT CONTRACTORS

The City of Calgary has pre-qualified electrical contractors to construct or maintain streetlighting within the City of Calgary. Only pre-qualified contractors are permitted to work on streetlighting systems that will be maintained and operated by the City. For the current list of prequalified streetlight contractors, contact Finance – Supply at 268-1843.

## 350.03.00 PERMITS & INSPECTIONS

A Registered Electrical Contractor under the provisions of the Electrical Safety Codes Act shall perform all electrical work. The Registered Electrical Contractor shall be licensed in The City of Calgary and shall appoint at least one Registered Representative whose qualifications shall comply with the provisions of the Electrical Safety Codes Act. The Registered Representative must have a current Master Electrician certification. The Contractor shall provide the Engineer with the name and phone number of the Registered Representative prior to starting construction.

Prior to construction the Contractor shall obtain and pay for all permits required under the provisions of the Electrical Safety Codes Act. The Contractor shall submit a copy of all permits to the Engineer prior to starting construction.

Refer to The City of Calgary, Building Regulations – Permit Fee Schedule to determine the cost of the electrical permit. The work to be included under the electrical permit shall include, but not necessarily be limited to:

- Supply and installation of luminaires, lamps and associated materials and wiring;
- Supply and installation of underground conduit, wiring and associated materials;
- Supply and installation of all service and control equipment and associated materials;
- All costs and fees related to the supply of electrical service from Enmax Power Corporation (EPC).

The Contractor shall obtain an Excavation Permit in accordance with Chapter 300 – General.

An Excavation Permit <u>will not be required</u> for installations in new URD subdivisions and for joint trench installations done under the 4-Party Agreement.

The designated City of Calgary, Roads, Street Lighting Inspector will inspect the installation on a regular basis during the course of the project in conjunction with the Engineer.

The City will not accept the installation until all work has been approved by the City of Calgary Electrical Safety Codes Inspector, by the Electrical Safety Branch and by the Engineer.

"Engineer" means:

- (a) the Manager, Office for Corporate Engineering, his representative or appointee, or
- (b) the Consulting Engineer or Architect engaged by the City to supervise the work, or
- (c) the Project Manager designated in the notice.

#### 350.04.00 BASIS FOR PAYMENT

Payment for work carried out under these Specifications shall be under either:

- a) Lump Sum no specific unit of payment for work in this category.
- b) Unit Rate work paid for by unit, such as tonne each, square metre each, etc.

Payment under either mode of payment shall be considered full compensation for all labour, materials and equipment necessary to complete the work.

c) Force Account - When directed by the Engineer, additional work not covered by either Lump Sum or Unit Rate shall be paid for under the Schedule of Force Account Rates.

#### 350.05.00 ELECTRICAL ENERGY SUPPLY

The electrical energy will be supplied from the EPC secondary distribution system unless otherwise noted on the plans.

The Contractor shall advise EPC when power connection is required. The procedure for arranging for power connection can be found in Appendix F to this document. The Contractor will pay all utility connection costs.

Should the disconnection of existing power service(s) be required, the Contractor shall undertake notification to and coordination with EPC. The procedure for arranging for disconnection of existing service(s) can be found in Appendix F to this document. The Contractor shall pay all costs for the disconnection of existing service(s).

## 350.06.00 MATERIALS

The City at a pre-determined cost will provide those materials listed in the Special Provisions Materials Schedule to the Contractor. The Contractor shall supply all other materials necessary for the satisfactory completion of the project.

All electrical equipment and materials shall be approved in accordance with the requirements defined in the Alberta Safety Codes Council Standata, Electrical Safety Information Bulletin LEG-ECR (current revision), and shall meet the approval of the Electrical Safety Codes Inspector.

All materials shall be new and conform to the requirements of the Plans, Drawings, other Subsections of the Specifications and the Standard Specifications for Street Lighting Materials.

A copy of the Standard Specifications for Street Lighting Materials may be purchased from:

The City of Calgary
Engineering Services, Building Grades Counter,
6<sup>th</sup> Floor, Municipal Building
800 MacLeod Trail SE
Calgary, Alberta T2P 2M5
Phone (403) 268-5703

All materials contained in the Standard Specifications for Street Lighting Materials, and as listed in Appendix A to this document, shall be provided by The City at the Contractor's cost.

Where applicable, the materials specified in the Plans and Special Provisions shall be supplied in accordance with the City's "Approved Supplier and Product List." This list identifies the manufacturer, the approved product, the product model number and the product approval date, and can be found in Appendix B to this document.

Where the City provides materials, the Contractor shall assume all responsibility for:

- Correctness of type and quantity of product;
- Protection and storage of materials;
- Insurance for the full replacement value of all City supplied materials.

Where alternate materials are permitted, approval must be received from the Engineer prior to their use. The "Alternate Materials Approval" process can be found in Appendix C to this document.

## 350.07.00 UTILITIES

Existing utilities are generally not shown on the street lighting electrical Plans. Where utilities are shown on the Plans, their locations are approximate.

The Contractor shall ensure that all existing utilities such as power lines, fibre optic cables, telephone lines, gas and oil pipelines, sewers, water works, etc. are located and protected. The Contractor shall at all times conduct its operations in accordance with the requirements of the utility authorities having jurisdiction. In the event of any damage to utilities, the Contractor shall be held responsible for the cost of all repairs and restoration to the satisfaction of the Engineer and the Utility Authority.

All costs for locating and protection of utilities shall be considered incidental to the work.

## 350.08.00 EXISTING STREET LIGHTING SYSTEMS

Existing street lighting systems, which are not compliant with the Standard Specifications Street Lighting Construction 2001, are considered "grandfathered" to the City.

Where street light luminaires are installed on utility infrastructure, they shall be considered "joint use" street lighting installations. Existing and future "joint use" installations shall be owned by the City, and maintained by EPC, its designated maintenance contractor, or a pre-qualified streetlight contractor who in addition meets the following:

- a) Employs ONLY Power Linemen or Power System Electricians as defined under applicable Alberta legislation, in performing streetlight works.
- b) All workers are "Utility Employees" as defined under the AECUC, Safety Codes Act.
- c) Regardless of any designation, all workers will adhere to the limits of approach of a "Utility Employee" as defined or set out in the AECUC.
- d) All workers are "Competent" as defined under the Alberta Occupational Health and Safety Code.

#### 350.09.00 CONSTRUCTION COMPLETION CERTIFICATE

The Engineer shall issue a Construction Completion Certificate in accordance with The City of Calgary Design Guidelines for Subdivision Servicing and The City of Calgary Design Guidelines for Streetlighting when the work has been completed.

## 350.10.00 MAINTENANCE PERIOD

After the issuance of the Construction Completion Certificate the Contractor shall be responsible for all works installed by it. If during the construction and maintenance period any defects become apparent in any of the utilities or improvements installed or constructed by the Contractor, the Engineer will request the Contractor to perform the repairs or replacement. If in the opinion of the Engineer, the Contractor fails to make the required repairs and replacement in a timely manner, the City may do the repairs or replacements and recover the full costs from the Contractor.

The maintenance period for streetlight installations is generally two years from the date of the Construction Completion Certificate for streetlighting, but will end only with the issuance of Final Acceptance Certificate for streetlighting.

## 350.11.00 FINAL ACCEPTANCE CERTIFICATE

After two years from the issuance of the Construction Completion Certificate, and after having remedied all the deficiencies, the Contractor can apply for a final inspection of the work and issuance of the Final Acceptance Certificate.

## 351.00.00 UNDERGROUND

#### 351.01.00 CONCRETE BASES

#### 351.01.01 General

The use of the term "concrete bases" in Chapter 351.01 shall also mean "concrete spread footings" where applicable.

The Drawings make reference to concrete bases that are poured in place or precast. The City shall be the nominated supplier of all precast concrete bases at the applicable unit cost per each.

The Contractor shall supply and install all poured in place concrete bases in accordance with the latest issue of the Construction Standards. Poured-in-place concrete bases shall be constructed in the excavation and shall be in accordance with:

- Drawings 454.2002.001, 454.2002.002 and 454.2002.003;
- Drawings 454.2003.001, 454.2003.002 and 454.2003.003;
- Drawings 454.2004.001, 454.2004.002 and 454.2004.003.

Supply and installation of concrete bases shall include the following as applicable:

- Excavation, backfill and compaction;
- Supply and installation of concrete and formwork;
- Supply and installation of reinforcing steel;
- Supply and installation of conduit;
- Installation of City supplied anchor bolts and/ or rebar cages;
- Installation of City supplied precast concrete bases.

The Contractor shall check for conflicts with overhead lines prior to excavating for the placement of concrete bases. If it appears there may be an overhead conflict, as per Drawing 454.2081.001, the Contractor shall contact the Engineer for further instructions. If the Contractor installs a concrete base in a location where the pole conflicts with overhead power lines, the Contractor shall remove the pole (if it has been erected) and relocate the concrete base to a location approved by the Engineer. The Contractor shall pay all costs related to the base relocation, including costs for the removal and re-erection of the pole.

#### 351.01.02 Excavation and Backfill for Concrete Bases

Excavations for concrete bases shall meet the requirements, but not the Quantities and Payment provisions of Chapter 304 – Utility Trench Backfill Regulations.

All excavation work shall be carried out as required to suit the specific type of concrete base being installed. Where directed by the Engineer, excavations shall be shored to avoid the cutting of pavement, sidewalks, and curb and gutter.

Base excavations shall be backfilled using suitable excavated material. Where the Engineer rules excavated material unacceptable, base excavations shall be backfilled with 25 mm Crushed Gravel as specified in Chapter 303 – Granular Material. Unacceptable materials shall be disposed of as specified in Chapter 302 - Earthwork.

Bedding and backfill material shall be placed in layers not exceeding 300mm compacted thickness and shall be compacted using a pneumatic or vibrating compactor to 97% Standard Proctor maximum density as per ASTM D-698. Layer thickness shall be reduced and moisture content of the material adjusted as required to achieve compaction. Care shall be taken not to damage conduits entering bases.

During the winter months the backfill material shall be free of snow, topsoil, frozen lumps and other deleterious materials.

All excavated and backfilled areas shall be restored to their original condition.

Asphalt restoration shall be performed in accordance with Chapter 304 – Utility Trench Backfill Regulations.

This clause <u>shall not apply</u> to URD shallow utilities in new subdivisions where agreements are in place for work to be done by others.

Concrete curb and gutter restoration shall be performed in accordance with Chapter 311 – Concrete Sidewalk, Curb and Gutter.

This clause shall not apply to URD shallow utilities in new subdivisions where agreements are in place for work to be done by others.

## 351.01.03 Concrete and Formwork for Concrete Bases

Concrete construction, including formwork, shall meet the requirements of Chapter 310 - Portland Cement Concrete and Chapter 311 - Concrete Sidewalk, Curb and Gutter.

Proportioning of the concrete mixes shall be the responsibility of the Contractor. The Contractor shall notify the Engineer 48 hours prior to pouring concrete for poured-in-place bases.

The concrete mix design shall meet the specifications in Chapter 310 – Portland Cement Concrete for Type 50 cement. Minimum requirements shall be as listed in Table 351-1.

Minimum compressive strength at 28 days	35 MPa
Maximum nominal aggregate size	28 mm
Maximum Water/Cement ratio by mass	0.4
Minimum Air Content	5%
Maximum Slump (prior to addition of superplasticizer)	65mm

**TABLE 351-1 CONCRETE MIX** 

When supplying poured-in-place concrete bases, the Contractor shall have the concrete strength verified, using concrete test cylinders, prior to installing the pole structure onto the base.

The minimum number of concrete strength tests shall be one complete set per day. The Contractor shall take concrete test cylinders at the location of the pour and perform tests in accordance with Chapter 310 - Portland Cement Concrete. The Contractor must provide written confirmation of concrete test cylinder results prior to installing any pole structure on the bases. The City may perform additional tests at its own cost.

Where installations are of a fast-track nature, the Contractor may use a highearly strength concrete mix that will give the equivalent 28 day strength in seven days.

The top finished surface of a concrete base shall not vary by more than 3 mm in depth as measured across the widest surface. If this variation exceeds 3 mm, the base shall be repaired or replaced as directed by the Engineer.

The contractor shall prevent any materials or debris from entering the storm water system.

## 351.01.04 Reinforcing Steel for Concrete Bases

Reinforcing steel shall meet the requirements but not the payment provisions of Chapter 300 - General.

All reinforcing steel shall conform to CAN/CSA-G30.18-M400R.

The Contractor shall adjust the spacing of reinforcing steel to suit anchor bolts and conduit.

## 351.01.05 Anchor Bolts and Conduit for Concrete Bases

Anchor bolts and conduits shall be cast into the concrete bases.

Where an anchor bolt is damaged, it shall be repaired in accordance with Drawings 454.2009.001 & 454.2009.002. Welding of anchor bolts will not be permitted.

## 351.01.06 Payment for Concrete Bases

Payment for concrete bases will be at the Contract Unit Price per base.

This clause <u>shall not apply</u> to URD shallow utilities in new subdivisions where agreements are in place for work to be done by others.

The Unit Price shall include, but not necessarily be limited to, all costs of excavation (other than Type B rock, concrete and asphalt removal); supply and installation of shoring to meet OHSA requirements; formwork, concrete, reinforcing steel and conduit; supply and installation of grout and sand to fill knock-out voids in bases; installation of individual anchor bolts or anchor bolt cages; placing and compaction of backfill material; removal and disposal of

excess excavated material; and all other labour, equipment, and materials necessary to complete the installation.

Any additional costs for supplying higher strength concrete shall be borne by the Contractor.

Payment for excavation of Type B Rock material, as defined in Chapter 302, will be made on a Force Account Basis unless otherwise stated in the Special Provisions.

All costs related to shoring of excavations, when required to meet OHSA regulations, shall be borne by the Contractor. Shoring of excavations, when directed by the Engineer will be paid by Force Account unless otherwise noted.

No additional payment will be made for de-watering of excavations.

## **351.01.07** Base Capping

Procedure to raise the top of streetlight base to 150mm above finished grade.

- 1. Take before and after pictures of work area and where pole is stored.
- 2. Have qualified workers disconnect power and remove pole.
- 3. Remove about 150mm of old material. Extend carlon or HDPE to 100mm above where the new top will be.
- 4. Install extension bolts onto existing anchor bolts (one locking nut below and one above the coupling).
- 5. Adjust bolts to fit template. Tape ends of extension to protect the threads.
- 6. Set sonotube in place and pour concrete. Finish concrete surface; bevel the edge; make a "V" groove drain as per Type B pre-cast base. Concrete to meet current City specifications.
- 7. In colder months, place heater box over base and ensure it is working.
- 8. After proper curing time, remove sonotube and reinstall pole. Reconnect power.
- 9. Clean up and restore to original or better conditions.
- 10. Measures should be in place to prevent any material from entering the storm water system.

Contact ROADS for mudjacking procedure.

## 351.02.00 JUNCTION BOXES AND VAULTS

#### 351.02.01 General

The Contractor shall supply and install all junction boxes and vaults in accordance with the Construction Standards, and as defined in the contract Special Provisions and on the Contract Drawings.

Plastic junction boxes shall be supplied and installed in accordance with Drawing 454.2020.001.

Concrete vaults shall be supplied and installed in accordance with Drawings 454.2022.001 & 454.2022.002. Concrete vaults shall be designed to withstand 50 kN Static Loading.

The top junction boxes and vaults shall be installed so that they are flush with the finished grade.

Junction box and vault lid hold down bolts shall be coated with anti-seize lubricant.

## 351.02.02 Approved Products – Junction Boxes and Vaults

Manufacturers of concrete junction boxes and vaults must meet the requirements of Chapter 300.

Concrete junction box or vault suppliers wishing to seek City approval must submit shop drawings, sealed by a Structural Engineer registered with the APEGGA, to The City of Calgary, Roads, verifying that the junction box or vault submitted for approval meets the specified loading requirements. The junction box or vault shall also meet the size and functional characteristics shown on the Drawings.

## 351.02.03 Excavation and Backfill for Junction Boxes and Vaults

Excavations for junction boxes and vaults shall meet the requirements but not the Quantities and Payment provisions of Chapter 304 – Utility Trench Backfill Requirements.

All excavation work shall be carried out as required to suit junction boxes and vaults. Where directed by the Engineer, excavations shall be shored to avoid the cutting and/or undermining of pavement, sidewalks and curb and gutter.

Junction boxes and vaults shall be installed on a bedding of 25mm Crushed Gravel material in accordance with Chapter 303 – Granular Material.

Junction box or vault excavations shall be backfilled using suitable excavated material. Where the Engineer rules excavated material unacceptable, junction box and vault excavations shall be backfilled with 25mm Crushed Gravel as specified in Chapter 303 – Granular Material. Unacceptable materials shall be disposed of as specified in Chapter 302 - Earthwork.

Bedding and backfill material shall be placed in accordance with Chapter 304 – Utility Trench Backfill Regulations. Care shall be taken not to damage conduits.

All excavated and backfilled areas shall be restored to their original condition.

Asphalt restoration shall be performed in accordance with Chapter 304 – Utility Trench Backfill Regulations.

Concrete curb and gutter restoration shall be performed in accordance with Chapter 311 – Concrete Sidewalk, Curb and Gutter.

## 351.02.04 Payment for Junction Boxes and Vaults

Payment for junction boxes and vaults will be at the Contract Unit Price per junction box.

This clause <u>shall not</u> apply to URD shallow utilities in new subdivisions where agreements are in place for work to be done by others.

The Unit Price shall include but not necessarily be limited to all costs of excavation (other than Type B rock, concrete and asphalt removal); supply and installation of junction box sections, lids, drain plates, adapter plates, braces and conductor support bars; supply and installation of shoring to meet OHSA requirements; 25 mm crushed gravel material below the junction box; placing and compaction of backfill material; removal and disposal of excess excavated material; and all other labour, equipment and materials necessary to complete the installation.

Payment for the excavation of Type B rock material will be made on a Force Account Basis unless otherwise noted.

All costs related to shoring of excavations, when required to meet OHSA regulations shall be borne by the Contractor. Shoring of excavations, when directed by the Engineer will be paid by Force Account unless otherwise noted.

No additional payment will be made for de-watering of excavations.

Additional drainage in junction boxes, as required by the Engineer, will be paid by Force Account.

## 351.03.00 CONDUIT

#### 351.03.01 General

The Contractor shall supply and install all conduit, with the exception of HDPE duct, in accordance with the Construction Standards, and as defined in the contract Special Provisions and on the Contract Drawings. The City provides HDPE conduit to the Contractor at a predetermined cost.

All electrical conduits shall be installed in accordance with the applicable Construction Standard Drawings and the Contract Plans and Special Provisions.

Rigid PVC (RPVC) conduit shall be unplasticized polyvinyl chloride and conform to CSA C22.2 No. 211.2. RPVC conduit shall be 1¼" (32mm) unless otherwise specified in the Drawings or Special provisions. Couplings, adapters, bends and fittings shall be unplasticized polyvinyl chloride and conform to CSA C22.2 No. 85. RPVC conduit shall be installed using CSA certified cement. Each standard length of RPVC conduit and each fitting shall bear a certification mark attesting to the applicable CSA standard. Underground conduit shall be RPVC where specifically stated in the Drawings or Special Provisions.

All HDPE conduit, provided by The City, shall be 1¼" (32mm) and shall be supplied in the quantities required for the installation on 6'-0" diameter reels. The minimum quantity of HDPE duct that The City will provide to the Contractor will be 1000m, on a single 6'-0" reel. The HDPE shall be installed continuously from pole base to pole base. Mid-run HDPE-HDPE splices will be permitted only when an approved coupler is used. All underground conduit shall be HDPE unless specifically stated otherwise in the Drawings or Special Provisions.

Rigid steel conduit (RSC) shall be hot-dipped galvanized rigid steel and conform to CSA C22.2 No. 45. Any exposed metal on conduit shall be coated with cold galvanizing compound. Above ground service conduits shall be RSC

Flexible liquid-tight non-metallic conduit (FNC) shall conform to CSA 22.2 No. 56. All joints shall be made with FNC threaded couplers, adapters or conduit fittings.

Conduit straps shall be galvanized steel single hole or double hole type, sized to suit conduit.

All empty conduits shall be proven, cleaned, have a pull string installed and shall be capped with an approved fitting. Pull string shall be polypropylene with a minimum tensile strength of 1.1 kN.

The Contractor shall layout conduit so that  $90^{\circ}$  bends are avoided. Where  $90^{\circ}$  bends cannot be avoided, in addition to the  $90^{\circ}$  bends at base entry locations, only one additional  $90^{\circ}$  bend will be allowed in each conduit run.

Conduit couplings or bell ends damaged when pulling conductors shall be replaced at the Contractor's expense. An appropriate pulling jig or method shall be used to avoid damaging conduit or fittings when pulling conductors.

## 351.03.02 Payment for Conduit

Payment for conduit will be at the Contract Unit Price per metre.

This clause <u>shall not apply</u> to URD shallow utilities in new subdivisions where agreements are in place for work to be done by others.

The Unit Price shall include but not necessarily be limited to all costs for the supply and installation of underground conduit, fittings, cement and pull strings; and all other labour, equipment and materials necessary to complete the installation.

Payment for conduit installed above ground on poles is not included in this subsection.

#### 351.04.00 TRENCHED CONDUIT INSTALLATION

#### 351.04.01 General

RPVC conduits shall be installed in an open trench in accordance with Drawings 454.2025.001 & 454.2025.002, except where conduits are to be drilled or pushed under the surface.

HDPE conduits shall be installed in an open trench in accordance with Drawings 454.2025.001 & 454.2025.002, except where conduits are to be drilled or pushed under the surface.

Trenching and backfilling for the installation of conduit shall be performed in accordance with Chapter 304 – Utility Trench Backfill Regulations.

This clause <u>shall not apply</u> to URD shallow utilities in new subdivisions where agreements are in place for work to be done by others.

Trenches shall be excavated with neat, uniform sides to the minimum width necessary, but not less than the minimum dimensions indicated on the drawings. Care shall be taken to prevent sloughing. Material in the floor of the trench shall be undisturbed, or if disturbed, shall be re-compacted to the requirement herein for backfill.

Trenches shall be backfilled using the excavated material except where excavated material is ruled unacceptable by the Engineer for backfill. Where new material is required, 25mm Crushed Gravel material shall be used as specified in Chapter 303 – Granular Material. Unacceptable materials shall be disposed of as specified in Chapter 302 – Earthwork.

A 150mm wide yellow plastic marker tape indicating "WARNING ELECTRICAL" shall be installed in each trench for the complete length of the trench. The location of the marker tape shall be as shown on the Construction Standard Drawings.

All excavated and backfilled areas shall be restored to their original condition.

Asphalt restoration shall be performed in accordance with Chapter 304 – Utility Trench Backfill Regulations.

Concrete curb and gutter and sidewalk restoration shall be performed in accordance with Chapter 311 – Concrete Sidewalk, Curb and Gutter.

## 351.04.02 Payment for Trenched Conduit Installation

Payment for trenching and backfilling for conduit installation will be at the Contract Unit Price per metre.

This clause <u>shall not apply</u> to URD shallow utilities in new subdivisions where agreements are in place for work to be done by others.

The Unit Price shall include but not necessarily be limited to all costs of excavation (other than Type B rock, concrete and asphalt removal); placing and compaction of excavated material as backfill; supply and installation of trench marker tape; removal and disposal of excess excavated material; and all other labour, equipment and materials necessary to complete the installation.

Payment for excavation of Type B rock material, as defined in Chapter 302, will be made on a Force Account Basis.

All costs related to shoring of excavations, when required to meet OHSA regulations, shall be borne by the Contractor. Shoring of excavations, when directed by the Engineer will be paid by Force Account unless otherwise noted.

No additional payment will be made for de-watering of excavations.

## 351.05.00 TRENCHLESS CONDUIT INSTALLATION

#### 351.05.01 General

Where noted on the Plans, the Contractor shall install the conduit using a suitable trenchless (horizontal drilling) technology to avoid cutting the existing pavement or sidewalk. The trenchless technology selected shall suit the site conditions.

Where pavement and sidewalk are existing, "directional drilling" trenchless technology shall be used. Otherwise, "plowing" trenchless technology will be permitted.

The Contractor shall give the Engineer a minimum of 48 hours notice prior to installing conduits.

The Contractor shall locate all underground utilities prior to installing conduits.

## 351.05.02 Payment for Trenchless Conduit Installation

Payment for the supply and installation of conduit using trenchless technology will be at the Contract Unit Price per metre.

This clause shall not apply to URD shallow utilities in new subdivisions where agreements are in place for work to be done by others.

The Unit Price shall include all costs of conduit; excavation for set up; backfilling and restoration when work is complete; and all other labour, equipment and materials necessary to complete the installation.

No separate payment will be made for unsuccessful installation.

## 351.06.00 ASPHALT PAVEMENT RESTORATION

#### 351.06.01 General

Asphalt rehabilitation shall be performed in accordance with Chapter 304 – Utility Trench Backfill Regulations.

The Contractor shall use a pavement saw to cut existing asphalt unless otherwise directed by the Engineer, and shall obtain a neat, uniform cut along the edge of asphalt.

The Contractor shall adhere to the practices outlined in The City of Calgary, Best Management Practice #1, Saw Cutting Operations Rev 1 Mar. 31, 2003 during all asphalt saw cutting operations. A reference copy of this Best Standard Practice document can be found in Appendix G to these construction standards.

## 351.06.02 Payment for Asphalt Restoration

Payment for Asphalt Pavement for electrical work will be as follows:

Where the electrical work forms part of a paving or road construction project, measurement and payment will be made in accordance with the Payment Schedule for Roadwork.

- a) Where the electrical work does not form part of a paving or road construction Project, payment shall be made in accordance with the Schedule of Quantities, except that:
  - All costs of handwork shall be included;
  - No separate payment shall be made for primer and tack coat and all costs of this work shall be included;
  - The contractor shall make every effort and take extra caution to minimize the damage to the sidewalk and asphalt. Replacement and rehabilitation of asphalt adjacent to the pole and cabinet base is considered incidental to the work and no additional payment will be made.
  - Payment for conduit trenches shall be made in tonnes of mix compacted in place but shall not exceed the theoretical quantity, which shall be calculated trench width plus 300mm (asphalt is excavated 150mm beyond the trench on both sides);
  - The theoretical quantity shall be calculated as follows: Theoretical Quantity = (TW+300)\*D\*L\*2.65t/m³
  - Measurement for payment for installation of all other works shall be made in cubic metres of mix and shall be calculated from the measurements of the work.

This clause <u>shall not apply</u> to URD shallow utilities in new subdivisions where agreements are in place for work to be done by others.

## 351.07.00 CONCRETE RESTORATION

#### 351.07.01 General

All concrete curbs and sidewalks shall be installed/restored in accordance with Chapter 311 – Concrete Sidewalk, Curb and Gutter.

The Contractor shall use a pavement saw to cut existing concrete unless otherwise directed by the Engineer, and shall obtain a neat, uniform cut along the edge of concrete. Concrete to be removed shall be cut to the nearest joints. Midslab or section sawcuts will not be permitted. The Contractor shall also prevent base gravel from sloughing and undermining the concrete.

The Contractor shall adhere to the practices outlined in The City of Calgary, Best Management Practice #1, Saw Cutting Operations Rev 1 Mar. 31, 2003 during all concrete saw cutting operations. A reference copy of this Best Standard Practice document can be found in Appendix G to these construction standards.

## 351.07.02 Payment for Concrete Curb and Gutter

The contractor shall make every effort and take extra caution to minimize the damage to the concrete. Replacement and rehabilitation of concrete adjacent to the pole and cabinet base is considered incidental to the work and no additional payment will be made.

Payment for the installation and/or restoration of Concrete Curb and Gutter for electrical work will be at the Contract Unit Price per lineal metre.

This clause <u>shall not apply</u> to URD shallow utilities in new subdivisions where agreements are in place for work to be done by others.

The Unit Price shall include, but not necessarily be limited to, all costs of excavation; supply and installation of 25mm Crushed Gravel bedding material; supply and installation of form work, concrete and expansion joint material, removal and disposal of excess excavated material; and all other labour, equipment and materials necessary to complete the installation.

Payment for Removal of Concrete Curbs will be at the Contract Unit price per lineal metre.

This clause <u>shall not apply</u> to URD shallow utilities in new subdivisions where agreements are in place for work to be done by others.

The Unit price shall include, but not necessarily be limited to, all costs for cutting, removing and disposing of existing concrete; and all other labour, equipment and materials necessary to complete the removal of concrete curbs.

## 351.07.03 Payment for Concrete Sidewalk and Miscellaneous Concrete

The contractor shall make every effort and take extra caution to minimize the damage to the concrete. Replacement and rehabilitation of concrete adjacent to the pole and cabinet base is considered incidental to the work and no additional payment will be made.

Payment for removal of Concrete Sidewalk and Miscellaneous Concrete will be at the Contract Unit Price per square metre.

This clause shall not apply to URD shallow utilities in new subdivisions where agreements are in place for work to be done by others.

The Unit Price shall include, but not necessarily be limited to, all costs for the cutting, removing and disposing of existing concrete roadway, sidewalk, etc.; and all other labour, equipment and materials necessary to complete the removal of concrete. The area for payment of concrete removal for all work will be measured.

## 351.08.00 SITE RESTORATION

#### 351.08.01 General

The contractor shall be responsible for all costs and to return all areas where work has been performed to an equal or better condition than that which existed prior to construction or as specified in the Drawings and Special Provisions. It is recommended that the contractor take site pictures before starting any work.

## 351.08.02 Site Clean up

The contractor shall clean up the site and dispose of all excess material, trash and other debris as work progresses. Before the job is considered to be complete, the contractor shall remove all construction material and equipment and shall clean the site and do such other work as may be necessary to leave the site occupied by them in a neat and fully restored condition.

## 351.08.03 Landscaped Areas

The Contractor shall be responsible for grading, loaming and seeding or sodding all landscaped areas in accordance with the current edition of The City of Calgary, Parks & Recreation Department's Development Guidelines and Standard Specifications, Landscape Construction.

All materials including loam, seeds, fertilizers and plants shall meet the Parks & Recreation Department Specification.

It is required that in areas where high foot traffic is evident, or as required in the drawings and Special Provisions, that sodding be used in place of seeding. The Contractor shall care for the sod for a minimum period of 2 weeks to allow the sod to establish roots. The Contractor shall rope off the newly seeded or sodded areas to prevent the intrusion of pedestrian traffic.

## 351.08.03 Payment for Site Restoration

All costs for site restoration will be considered incidental to the Work.

This clause <u>shall not apply</u> to URD shallow utilities in new subdivisions where agreements are in place for work to be done by others.

## 351.09.00 REMOVAL of REJECTED MATERIAL

## 351.09.01 General

Where excavated material is designated unacceptable for backfill by the Engineer it shall be removed from the work site and disposed of by the Contractor. The Engineer shall approve the disposal site for Rejected Excavated Material.

## 351.09.02 Payment for Removal of Rejected Material

Payment for the Removal of Rejected Excavated Material will be at the Contract Unit Price per cubic metre.

This clause shall not apply to URD shallow utilities in new subdivisions where agreements are in place for work to be done by others.

The Unit Price shall include, but not necessarily be limited to, all costs of removal and disposal, and all other labour, equipment and materials necessary to complete the removal and disposal of rejected material.

## 352.00.0 ELECTRICAL

## 352.01.00 STREETLIGHT POLES

#### 352.01.01 General

Streetlight poles, including luminaries and lamps, shall be installed in accordance with the applicable Construction Standard Drawings for the types of poles to be installed.

All components of the streetlight poles shall be handled with care to prevent stress to the components through bending or twisting. A nylon sling shall be used to transport and erect the components. The use of steel chains as slings will not be permitted. Any damage to the components through overstress, scratching or denting shall be repaired or replaced at the Contractor's expense to the satisfaction of the Engineer.

#### 352.01.02 Poles

The slip-fit connection between pole sections shall be assembled in accordance with the lap length specified by the pole supplier

All pole shafts shall be installed plumb. Poles shall be plumbed using shims where necessary, with a maximum of two shims per anchor bolt permitted. The use of washers to plumb poles shall not be permitted.

Where possible, all streetlight poles shall be positioned with the handhole oriented on the downstream traffic side. Otherwise, the handhole shall be positioned as defined in the Plans and Specifications.

When replacement of existing pole is required, all existing signage is to be removed from existing pole and shall be reinstalled on new pole. See 352.06.00

Poles shall not be erected until concrete bases have attained strength of 30 MPa. Pole shafts shall mount directly on concrete bases and, where necessary, shall be trued to plumb using leveling shims.

Field drilling of holes larger than 33mm (1 5/16") diameter will not be permitted unless specifically detailed on the Street Lighting Construction Standard Drawings

All wiring inside the poles shall be in accordance with the Drawing 454.2066.001.

The Contractor shall tighten all bolts and nuts to 1/3 past snug tight. "Snug-tight" is the tightness attained by a few impacts of an impact wrench or the full effort of a person using a spud wrench.

Hand hole bolts shall be coated with anti-seize lubricant.

All scratches in poles and all field-drilled holes shall be coated with cold galvanizing compound.

## 352.01.03 **Luminaires**

Luminaires shall be installed as per manufacturer's instructions or as noted on the Plans. Luminaires shall be installed in accordance with the applicable Construction Standards drawings.

Where the luminaire has a multi-tap ballast, the Contractor shall verify the service voltage and adjust the luminaire voltage tap to suite.

## 352.01.04 Lamps

Lamps shall be installed as per manufacturer's instructions or as noted on the Plans. Lamps shall be installed in accordance with the applicable Construction Standards drawings.

The Contractor shall permanently mark all lamps, at the time of installation, with the lamp's in-service date.

## 352.01.045 Recycling and Disposal of Streetlight Components

Streetlight components must be handled, stored, transported, disposed of and recycled in accordance with all applicable regulatory requirements.

**Luminaires and Lamps**: all removed luminaires, luminaire components and lamps must be returned to City Stores for proper management and disposal of hazardous luminaire components.

**Poles**: Steel and aluminum poles removed for scrap must be disposed of at one of the City approved recycling facilities:

- a) Federal Metals Inc.
   9715 52<sup>nd</sup> Street, S.E.
   Calgary, AB
- b) Calgary Metals 3415 Ogden Road, S.E. Calgary, AB

The City of Calgary to receive credit for the recovered material.

**Concrete bases**; All concrete bases shall be recycled or disposed of at a suitable recycling or disposal facility.

**Other Materials:** the contractor shall dispose of all other materials at approved disposal facilities. Materials that can be recycled shall be recycled.

## 352.01.05 Payment for Streetlight Poles

Payment for the installation of streetlight poles shall be at the Contract Unit Price for each pole.

This clause shall not apply to URD shallow utilities in new subdivisions where agreements are in place for work to be done by others.

The Unit Price shall include, but not necessarily be limited to, all costs for the supply and installation of poles, and all other labour, equipment and materials necessary to complete the installation.

## 352.01.06 Payment for Streetlight Luminaires

Payment for the installation of streetlight luminaires shall be at the Contract Unit Price for each luminaire.

This clause <u>shall not apply</u> to URD shallow utilities in new subdivisions where agreements are in place for work to be done by others.

The Unit Price shall include, but not necessarily be limited to, all costs for the supply and installation of luminaires; supply and installation of wiring from the luminaire to the handhole at the base of the pole; connection and splicing of all wiring; supply and installation of fuse holders and fuses; and all other labour, equipment and materials necessary to complete the installation.

## 352.01.07 Payment for Streetlight Luminaire Lamps

Payment for the installation of lamps in streetlight luminaires shall be at the Contract Unit Price for each lamp.

This clause <u>shall not apply</u> to URD shallow utilities in new subdivisions where agreements are in place for work to be done by others.

The Unit Price shall include, but not necessarily be limited to, all costs for the supply and installation of lamps; and all other labour, equipment and materials necessary to complete the installation.

## 352.01.08 Payment for Recycling and Disposal of Streetlight Components

All costs for the recycling and disposal of streetlight components will be considered incidental to the Work.

## 352.02.00 SERVICE EQUIPMENT and ELECTRICAL ENERGY SUPPLY

#### 352.02.01 General

Service equipment shall be installed in accordance with the applicable Construction Standard Drawings for the type of service to be installed. Service equipment shall include service, distribution, disconnect and control panels for roadway lighting systems.

Pole mounted service equipment shall be securely attached to the streetlight pole.

Freestanding specialized service equipment (e.g., service kiosks) shall be installed in accordance with the Contract Plans and Special Provisions.

## 352.02.02 Definition of Point of Electrical Energy Service

The point of demarcation between the Enmax Power Corporation (EPC) owned distribution system and the City owned streetlight system, termed the "point of electrical service", shall be as follows:

(a) Underground dip service from the EPC overhead distribution system:

The point of service shall be considered to be the line side termination point at the service panel main circuit breaker or the service disconnect fuses in the handhole of the first streetlight pole. The electrical service conduit from the base of the EPC service pole to the street lighting service panel shall be supplied and installed by the Contractor. The electrical service conduit on the EPC service pole and the electrical service conductors from the service pole to the main circuit breaker or the service disconnect fuses shall be supplied, installed and terminated by EPC.

Refer to drawing 454.2071.002 for installation details.

(b) Overhead drop service from the EPC overhead distribution system:

The point of service shall be considered to be the line side termination point at the service panel main circuit breaker or the service disconnect fuses in the handhole of the first streetlight pole. The electrical service conduit, service weatherhead and service conductors from the main street lighting service panel, up the streetlight pole to the weatherhead, shall be supplied and installed by the Contractor. The overhead electrical service conductors from the EPC service pole to the streetlight pole shall be supplied, installed and terminated at the weatherhead by EPC.

Refer to drawing 454.2071.005 for installation details.

## (c) Underground service from Power Utility distribution transformer:

The point of service shall be considered to be the line side termination point at the service panel main circuit breaker or the service disconnect fuses in the handhole of the first streetlight pole. The electrical service conduit from the street lighting service panel to a point 1.0m from the secondary distribution connection cabinet at the EPC distribution transformer shall be supplied and installed by the Contractor. The electrical service conduit on this point to the distribution transformer shall be supplied and installed by EPC. The electrical service conductors from the service pole to the main circuit breaker or the service disconnect fuses shall be supplied, installed and terminated by EPC.

Refer to drawing 454.2071.002 for installation details.

## 352.02.03 Payment for Service Equipment

Payment for the installation of Service Equipment will be paid at the Lump Sum Price for that service area.

This clause shall not apply to URD shallow utilities in new subdivisions where agreements are in place for work to be done by others.

The Lump Sum Price shall include, but not necessarily be limited to, all costs for the installation of the service and control panel, and service disconnect including the pole where a separate service pole is required; supply and installation of service wiring from the defined point of electrical energy supply including wiring between the disconnect and distribution panels; supply and installation of conduit, fittings, mounting hardware, ground wire, ground clamp, insulating clevis, grounding electrode and branch circuit wiring to the handhole at the base of the pole; and all other labour, equipment and materials necessary to complete the installation.

## 352.02.04 Payment for Electrical Energy Supply

Payment for the supply and connection of the Electrical Energy Supply will be paid at the Lump Sum Price for that service area.

This clause shall not apply to URD shallow utilities in new subdivisions where agreements are in place for work to be done by others.

The Lump Sum Price shall include, but not necessarily be limited to, all costs to be paid to EPC for the design, provision of all materials, equipment and labour, and connection of the electrical service. It shall include the cost of all inspections, fees and permits

## 352.02.05 Temporary Electrical Services

During the construction period, if temporary and/or detour lighting is required, the contractor shall all make necessary arrangements for the required temporary electrical service. The contractor will be responsible for the all costs for installation and removal of the service and for all electrical energy consumption charges for the duration of the service.

#### 352.03.00 WIRING

#### 352.03.01 General

The Contractor shall supply and install wiring in accordance with the Construction Standards, as defined in the Contract Special Provisions and on the Contract Drawings and as directed by the Engineer.

All conductors shall be stranded copper, RW90 XLPE insulated unless otherwise noted in the Contract Plans and Special Provisions. Minimum conductor size shall be #8 AWG for line and neutral conductors and #12 AWG for bonding conductors, unless otherwise specified in the Contract Drawings or Special Provisions.

Conductor colour coding and labeling is required and shall be as noted on Drawing 454.2065.001. Colour coding shall meet the requirements of the Canadian Electrical Code except where specifically stated otherwise in these standards. Service and lighting feeder conductors terminated at PER lighting controllers must be colour coded as shown on drawings 454-2070-002, 454-2070-003 and 454-2070-004.

Each luminaire shall be wired separately to the handhole at the base of the pole. A separate neutral (if required) and bond conductor shall be run from each luminaire to the handhole at the base of the pole. The neutral(s) and bond conductor(s) shall be bundled with the feeder circuits.

Luminaire wiring and fusing in pole handholes shall conform to Drawing 454.2066.001.

Wiring inside round plastic junction boxes shall conform to Drawing 454.2067.001.

Wiring inside rectangular concrete junction boxes shall conform to Drawing 454.2068.001.

Wiring inside concrete vaults shall conform to Drawing 454.2069.001 & 454.2069.002.

Conductor splices shall be secured with solderless wire nut "Marrette" type connectors. Where the number and/or size of conductors exceed the capacity of the wire nut connector, split bolt connectors may be used.

All wiring shall be neatly bundled and labeled in all junction boxes, vaults, handholes at pole bases and service panels.

Sealing of connections shall be performed using one of the following methods:

a) Each conductor shall have a wrap of self-holding tape (3M Linerless Rubber Splicing Tape, Steadfast 8 Ounce Splicing Tape, or approved alternate), and then the complete splice shall be wrapped. PVC tape shall then be applied to cover the entire splice. b) If conductor connections require the use of split bolts or similar style devices due to wire size or quantity, then the splice shall be completely covered with Duct Seal. The Duct Seal shall be thick enough to prevent the ends of the conductors or any portion of the split bolt from protruding through the taped connection.

Once the duct seal has been applied, the splice shall be taped with self-holding and PVC tape as described above.

All luminaires shall be bonded to the ground stud in the handhole at the base of the pole using #12 RW90. Where the luminaire voltage is 240V (line-line) and the luminaire has a CWI ballast, the Contractor shall confirm that the lamp screw shell is bonded to the pole ground stud to satisfy the requirements of CEC Section 30-314(1).

The Contractor shall confirm and, if necessary, modify ballast connections for the voltage used.

Steel junction box and vault lids shall be bonded in accordance with Drawings 454.2067.001, 454.2068.001 and 454.2069.002.

## 352.03.02 Payment for Wiring

Payment for the installation of Wiring shall be at the Lump Sum Price for all the underground wiring in the Work.

This clause <u>shall not apply</u> to URD shallow utilities in new subdivisions where agreements are in place for work to be done by others.

The Lump Sum Price shall include, but not necessarily be limited to, the supply and installation of wiring located in the underground conduit system, unless otherwise noted in the Contract Drawings and Special Provisions; splices; labeling of conductors; and all other labour, equipment and materials necessary to complete the installation.

## 352.04.00 GALVANIZED SURFACE REPAIR

#### 352.04.01 General

Any spots where the galvanized finish is damaged due to drilling, tapping, reaming or welding and any surface damage incurred during transportation or erection shall be refinished with cold galvanizing compound.

Cold galvanizing compound shall be Crown No. 67007 spray type (or approved alternate). The application of cold galvanizing compound shall conform to the Manufacturer's and the following:

- a) The surface shall be mechanically cleaned with a wire brush or grinder and chemically cleaned. All welding flux, paint, grease, oil, rust and other detrimental foreign material must be removed.
- b) The surface shall be completely dry and the temperature shall be over 10°C.
- c) Uniform coats shall be applied. Each coat shall be as thick as possible without causing runs on the finished surface. A minimum of two coats shall be applied.

All repairs shall be completed to the satisfaction of then Engineer.

## 352.04.02 Payment for Galvanized surface repair

All costs for the repair of galvanized surfaces will be considered incidental to the Work.

## 352.05.00 PAINTING OF EXISTING LUMINAIRE POLES

## 352.05.01 General

The painting of poles shall be done in accordance with the Construction Standards, and the Contract drawings and specifications.

This specification only applies to poles owned by The City of Calgary. It does not apply to "joint use" or utility power poles.

## 352.05.02 Work by the Contractor

The Contractor shall be responsible for the provision of all labour, equipment, and incidental materials required to complete the following items of work:

- (a) Paint the full length of streetlight poles, excluding self-weathering Corten poles;
- (b) Remove and dispose of all anchor bolt nut covers;
- (c) Prepare the work site around poles for painting including digging to expose the pole base if required;
- (d) Remove and properly dispose of all soil, dirt and excess materials such as old paint and rust scale created during the preparation process;
- (e) Remove all streetlight pole identification decals or metal tags.
- (f) Remove and dispose of all posters or notices taped or glued to the luminaire poles;
- (g) Report to the Engineer any physical damage to the poles that may have been found. Wait for instructions from the Engineer before proceeding with the painting:
- (h) Supply all paint removal materials necessary for the performance of the work;
- (i) Supply all paint, primer, thinners, masking tapes, rollers, brushes and all other incidental materials required for the performance of the work;
- (j) Maintain a written record of each pole that is painted on a set of "As-Built" drawings;
- (k) Submit the "As-Built" drawings within a month after the completion of the work;
- (I) Provide all traffic control and temporary signing in accordance with the current edition of the City of Calgary Worksite Temporary Traffic Control Manual.

# 352.05.03 Work by the City

The City shall do the repair or replacement of damaged luminaire poles.

# 352.05.04 Materials Supplied by the City

The City will supply, in a timely manner, the following materials to the Contractor:

- (a) Drawings identifying the areas within which streetlight poles are to be painted;
- (b) Current application instructions and procedures.

# 352.05.05 Preparation for Painting

The Contractor shall follow the following preparation procedures:

- (a) Site preparation and inspection for damages on the equipment,
- (b) Grinding or sanding as necessary, including poster, notice and graffiti removal. Sandblasting is not permitted for surface preparation of streetlight poles.

The Contractor shall supply all necessary equipment and materials for cleaning the luminaire pole.

The Contractor shall remove the signs or equipment attached to the pole in order to properly prepare and paint the area under the clamping device. When the paint is fully dried, the Contractor shall re-attach the signs and equipment to the pole. See 352.06.00

Pole preparation and painting operations shall be done in such a manner as not to damage other properties (e.g. plants, materials and equipment not included in this contract). The Contractor shall ensure and provide adequate protection for the public at all times, during the cleaning and painting process. Paint scrapings shall be contained and removed from the work site.

Paint scrapings may contain metals such as lead. Paint scrapings must be tested for TCLP metals prior to disposal to determine if the waste is hazardous. Hazardous waste must be disposed of at an approved waste management facility. Copies of analytical results and waste disposal records must be provided to the Engineer. Arrangements may be made with the Engineer to have The City test the paint scrapings and dispose of the waste.

Where rusting, scaling, or blistering exists, the Contractor shall wire brush the area. Primer shall be applied to all areas of the pole where the cleaning process has exposed the bare metal. The minimum coat of primer shall be a minimum dry film thickness of 2-3 mils. The primer shall be applied within eight (8) hours of the surface being cleaned.

If conditions prevent the application of primer within the stated eight (8) hour period, the Contractor shall, if circumstances require or as directed by the Engineer, re-clean the metal surface to ensure no rusting has commenced before applying primer.

Surface accumulations of grease, oil, dust, dirt or oxidized paint shall be first removed. The surface shall be roughened before the finished coat of paint is applied.

The Contractor shall remove all anchor bolt nut covers and shall expose the area around the anchor nuts for cleaning prior to applying primer or paint.

**Primer for previously painted poles** to be used shall be General Paint 06160 Anti-corrosive Primer, Cloverdale 74024 Rustex Primer or an alternate product approved by The City. The City reserves the right to accept or reject the alternate products.

**Primer for galvanized poles** to be General Paint 06-020 Cementitious Primer, Cloverdale Cementitious Primer or an alternate product approved by The City. The City reserves the right to accept or reject the alternate products.

**Paint for previously painted poles and galvanized** to be used shall be General Paint 10-Line Marine Enamel, Cloverdale Marine Enamel Primer or an alternate product approved by The City. The City reserves the right to accept or reject the alternate products.

The Contractor shall submit paint color samples to The City for review and approval. No painting work shall commence prior to the Contractor receiving approval of the paint color from The City.

The Contractor may submit alternate painting and preparation methods. The details of the proposed methods shall be submitted with this tender for construction and evaluation. The City reserves the right to accept or reject the alternate painting and preparation methods.

# 352.05.06 Painting of Luminaire Poles

The Contractor shall apply paint on streetlight poles within the relative humidity and ambient temperature range in accordance with the manufacturer's recommendations.

The equipment surface shall be thoroughly dry and rust free before paint is applied. Particular attention shall be given to surface condensation.

The Contractor shall ensure correct coverage of all edges and coating applications shall be free of tears, runs, pinholes or any other paint defects. The finished coat shall have a minimum dry film thickness of 2-3 mils, shall be uniform in colour and good in appearance.

The Contractor shall provide protection for the concrete streetlight bases during the painting process to ensure that no paint accumulates on the surface of the concrete base. Paint shall not be applied to the inside of the retaining bolt cup washer on the hand hole plate. If the bolt and cup are badly rusted, it should be reported to the Engineer for replacement.

The Contractor shall not scrape, sand or paint poles that have polyester type finish. Permission must be obtained from the Engineer to work on this type of pole.

# 352.05.07 Payment for Painting of Existing Luminaire Poles

Payment for the Painting of Existing Streetlight Poles the Contract Unit Price per pole.

The Unit Price shall include, but not necessarily be limited to, all costs for the supply of all print, primer, thinners, masking tapes, rollers, brushes and all other incidental materials, preparation and painting of luminaire poles; provision of temporary traffic control; disposal of removed paint and cleaning materials; all disposal, permit and inspection costs; and all other labour, equipment and materials necessary to complete the installation.

# 352.06.0 SIGNAGE

# 352.06.01 General

All work affecting the removal, relocation and reinstallation of traffic control devices must be in accordance with the City of Calgary Traffic Control Policy Manual and City of Calgary Sign Code Book.

# 352.06.02 Regulatory and Warning Signs

Regulatory Signs indicate a legally enforceable traffic regulation under the Traffic Safety Act.

Warning Signs indicate, in advance, potentially dangerous conditions to the road user.

In the case where regulatory and warning signs are to be removed and/or relocated where the streetlight pole is being permanently removed or relocated, the Contractor **must** contact Traffic Engineering (Dial 311). The Contractor shall contact Traffic Engineering a minimum of two business days in advance of the proposed work.

In the case where regulatory and warning signs are to be removed and reinstalled on a streetlight pole in the same location, the Contractor shall relocate the signs in accordance with all requirements of the City of Calgary Traffic Control Policy Manual and City of Calgary Sign Code Book and shall adhere to the following:

"The replacement of regulatory signs in an expedient manner is extremely important, but in the case of STOP and YIELD signs, it is imperative that the following guidelines be followed:

- A portable sign is to be installed prior to the removal of the permanent sign and must remain in place until the permanent replacement installation is completed.
- ii) The portable installations are to be inspected daily and a record of these inspections is to be forwarded to the Traffic Engineering Division.
- iii) If the STOP or YIELD sign is in combination with any other sign, do not wait for the installation of the remaining signs, reinstall the STOP or YIELD sign as soon as possible.

# 352.06.03 Information Signs

Information signs that may be mounted on streetlight poles can be of the following types:

- Guide signs;
- Highway and Street Identification signs;
- Off-Road Facility signs:
- Miscellaneous Information signs.

# 352.06.04 Parking Control Signs

Parking control signs that may be mounted on streetlight poles can be of the following types:

Commercial Loading Zone signs;

Passenger Loading Zone signs;

Handicapped Parking Zone signs;

Residential Parking Zone signs.

In the case where information and parking signs are to be removed and/or relocated where the streetlight pole is being permanently removed or relocated, the Contractor shall contact Traffic Engineering for authorization prior to removal and relocation (Dial 311).

In the case where information and parking signs are to be removed and re-installed on a streetlight pole in the same location, the Contractor shall relocate the signs in accordance with all requirements of the City of Calgary Traffic Control Policy Manual and City of Calgary Sign Code Book.

# 454.00.00 LIST OF STANDARD DRAWINGS

SHEET	DESCRIPTION	FILE NUMBER
	Concrete Bases	
1.	Concrete Base Index	454.2001.001
<del>2.</del>	Type 'A' Precast Concrete Base	<del>454-2001.002</del>
3.	Type 'B' Round Precast Concrete Base	454.2001.003
4.	Type 'B1' Round Precast Concrete Base	454.2001.004
5.	Type 'B2' Square Precast Concrete Base	454.2001.005
6.	Type 'C' Round Precast Concrete Base	454.2001.006
7.	Type 'C1' Square Precast Concrete Base	454.2001.007
8.	Type 'D' Base Detail for 20m Steel Davit Pole	454.2002.001
9.	Anchor Bolt Template and Details for Type 'D' Base	454.2002.002
10.	Material List for Type 'D' Base	454.2002.003
11. 12.	Type 'D1' Precast Concrete Base	454.2002.004
12. 13.	Type 'E' Base Detail for 30m Steel High Mast Pole	454.2003.001 454.2003.002
13. 14.	Anchor Bolt Template and Details for Type 'E' Base Material List for Type 'E' Base	454.2003.002
1 <del>4</del> . 15.	Type 'F' Base Detail for 30m High Mast Pole	454.2004.001
16.	Anchor Bolt Template and Details for Type 'F' Base	454.2004.002
17.	Material List for Type 'F' Base	454.2004.003
18.	Luminaire Pole Attachment on Structure	454.2006.001
19.	Concrete Base for Streetlight Service Cabinet	454.2008.001
20.	Anchor Bolt Repair Procedures	454.2009.001
21.	Anchor Bolt Repair Details	454.2009.002
22.	Breakaway Base Installation Notes	454.2010.001
23.	Breakaway Base Installation Details	454.2010.002
24.	Pole Base Installation Details	454.2015.001
25.	Pole Base Installation Details	454.2015.002
26.	Type 'G' Base for 15m Davit Pole in Median Barrier	454.2016.001
27.	Type 'H' Base for 15m Davit Pole in Median Barrier	454.2016.002
	Junction Boxes	
28.	Round Plastic Junction Box	454.2020.001
<del>29.</del>	Rectangular Concrete Junction Box	454.2021.001
30.	Large Concrete Junction Box (Vault)	454.2022.001
31.	Large Concrete Junction Box (Vault)	454.2022.002
<del>32.</del>	Junction Box at Luminaire Pole	454.2023.001
	Underground Conduit	
00	Hadanara and Dustin David Asses	454 0005 004
33.	Underground Duct in Paved Areas	454.2025.001
34.	Underground Duct in Non-Paved Areas	454.2025.002

# **Decorative Luminaire Poles**

74.

75.

76.

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35.	5m Walkway Pole Installation Details	454.2030.001
36.	5m Walkway Pole Materials List	454.2030.002
37.	5m Traditional (17 <sup>th</sup> Ave.) Pole Installation Details	454.2031.001
38.	5m Traditional (17 <sup>th</sup> Ave.) Pole Materials List	454.2031.002
39.	5m Contemporary Style Pole Installation Details	454.2032.001
40.	5m Contemporary Style Pole Materials List	454.2032.002
41.	4.6m Chinatown Style Pole Installation Details	454.2033.001
42.	4.6m Chinatown Style Pole Materials List	454.2033.002
43.	5m Inglewood Style Pole Installation Details	454.2034.001
44.	5m Inglewood Style Pole Materials List	454.2034.002
45.	5.5m Barclay Mall Style Pole Installation Details	454.2035.001
46.	5.5m Barclay Mall Style Pole Materials List	454.2035.002
47.	5.5m Kensington Style Pole Installation Details	454.2036.001
48.	5.5m Kensington Style Pole Materials List	454.2036.002
49.	8m Stephen Ave. Mall Style Pole Installation Details	454.2037.001
50.	8m Stephen Ave. Mall Style Pole Materials List	454.2037.002
51.	Roulleville Straight Style Pole Installation Details	454.2038.001
52.	Roulleville Straight Style Pole Materials List	454.2038.002
53.	6.4m Electric Ave. Style Pole Installation Details	454.2044.001
54.	6.4m Electric Ave. Style Pole Materials List	454.2044.002
55.	7m Tear Drop Louise Bridge Pole Installation Details	454.2045.001
56.	7m Tear Drop Louise Bridge Pole Materials List	454.2045.002
57.	7m Tear Drop Traditional Step Pole Installation Details	454.2046.001
58.	7m Tear Drop Traditional Step Pole Materials List	454.2046.002
59.	Elbow Drive Pole Installation Details	454.2046.003
60.	Elbow Drive Pole Materials List	454.2046.004
61.	7.8m McKenzie Towne Style Pole Installation Details	454.2047.001
62.	7.8m McKenzie Towne Style Pole Materials List	454.2047.002
63.	8.2m Straight Steel Pole Installation Details	454.2048.001
64.	8.2m Straight Steel Pole Materials List	454.2048.002
04.	0.2111 Straight Steel 1 die Materials List	434.2040.002
	Standard Luminaire Poles	
65.	9m/2.5m Single Davit Pole Installation Details	454.2050.001
66.	9m/2.5m Single Davit Pole Materials List	454.2050.002
67.	9m/2.5m Double Davit Pole Installation Details	454.2051.001
68.	9m/2.5m Double Davit Pole Materials List	454.2051.002
69.	9m Square Steel Pole Installation Details	454.2052.001
70.	9m Square Steel Pole Materials List	454.2052.002
71.	12m Round Tapered Steel Pole Installation Details	454.2053.001
72.	12m Round Tapered Steel Pole Materials List	454.2053.001
73.	12m 16 Sided Tapered Steel Pole Installation Details	454.2053.003
73. 74	12m 16 Sided Tapered Steel Pole Materials Liet	454.2052.003

12m 16 Sided Tapered Steel Pole Materials List

15m/2.5m Single Davit Pole Installation Details

15m/2.5m Double Davit Pole Installation Details

20m/2.5m Single Davit Pole Installation Details

15m/2.5m Single Davit Pole Materials List

15m/2.5m Double Davit Pole Materials List

20m/2.5m Single Davit Pole Materials List

454.2053.004

454.2054.001

454.2054.002

454.2055.001

454.2055.002

454.2056.001

454.2056.002

81. 82.	20m/2.5m Double Davit Pole Installation Details 20m/2.5m Double Davit Pole Materials List	454.2057.001 454.2057.002
	High Mast Lighting Poles	
83. 84. 85. 86.	30m High Mast Pole Installation Details 30m High Mast Pole Wiring Details 30m High Mast Pole Wiring Details 30m High Mast Pole Materials List 30m High Mast Pole (Raise/Lower) Installation Details	454.2058.001 454.2058.002 454.2058.003 454.2058.004 454.2059.001
88. 89. 90.	30m High Mast Pole (Raise/Lower) Device Details 30m High Mast Pole Raise/Lower Wiring Details 30m High Mast Pole (Raise/Lower) Materials List Temporary Lighting on Wood Poles	454.2059.002 454.2059.003 454.2059.004
91. 92.	Temporary Lighting on Wood Pole Installation Details Temporary Lighting on Wood Pole Materials List	454.2060.001 454.2060.002
	Electrical	
93. 94. 95. 96. 97. 98. 99.	Single Conductor Colour Coding Luminaire Wiring in Pole Handhole Wiring in Round Plastic Junction Boxes Wiring in Rectangular Concrete Junction Boxes Wiring in Concrete Vaults Wiring in Concrete Vaults 30A 240V 'PER' Service Relay Installation Details 30A 240V 'PER' Service Relay Installation Details	454.2065.001 454.2066.001 454.2067.001 454.2068.001 454.2069.001 454.2069.002 454.2070.001 454.2070.002
101. 102.	30A 240V N.O. Streetlight Service Unit Materials List & Wiring Details 30A 240V N.C. Streetlight Service Unit Materials	454.2070.003
103. 104. 105. 106. 107.	List & Wiring Details 60A 120/240V U/G Dip Service Installation Details 60A 120/240V U/G Dip Service Installation Details 60A 120/240V U/G Dip Service Panel Mounting Details 60A 120/240V U/G Dip Service Panel Wiring Details 60A 120/240V O/H Drop Service Wiring Details	454.2070.004 454.2071.001 454.2071.002 454.2071.003 454.2071.004 454.2071.005
108. 109. 110. 111. 112.	60A 120/240V O/H Drop Service Panel Mounting Details 60A 120/240V O/H Drop Service Panel Wiring Details Pedestal Style Service Base 60A 120/240V Service Base Panel Details 60A 120/240V Service Base Panel Mounting Details	454.2071.006 454.2071.007 454.2072.001 454.2073.001 454.2073.002
113. 114. 115. 116. 117. 118. 119.	60A 120/240V Service Base Panel Mounting Details 100A Streetlight Service Cabinet Installation Details 100A 120/240V 1ph Service Cabinet Wiring Details 100A 120/208V 3ph Service Cabinet Wiring Details 100A 240/480V 1ph Service Cabinet Wiring Details 100A Streetlight Service Cabinet Materials List Pole Mounted Receptacle Minimum Clearances to Overhead Powerlines	454.2073.003 454.2074.001 454.2074.002 454.2074.003 454.2074.004 454.2074.005 454.2080.001 454.2081.001

# The following drawings were missing from the index at time of publishing. To be revised in future publications.

4a.	Foundation Detail for 12m Aluminum Pole	507-1LBA-001
4b.	Foundation Detail for 12m Aluminum Pole Material List	507-1LBA-002
74a.	14m Pole with T-Arm Assembly Installation Details	454.2054a.003
74b.	14m Pole with T-Arm Assembly Materials List	454.2054b.004

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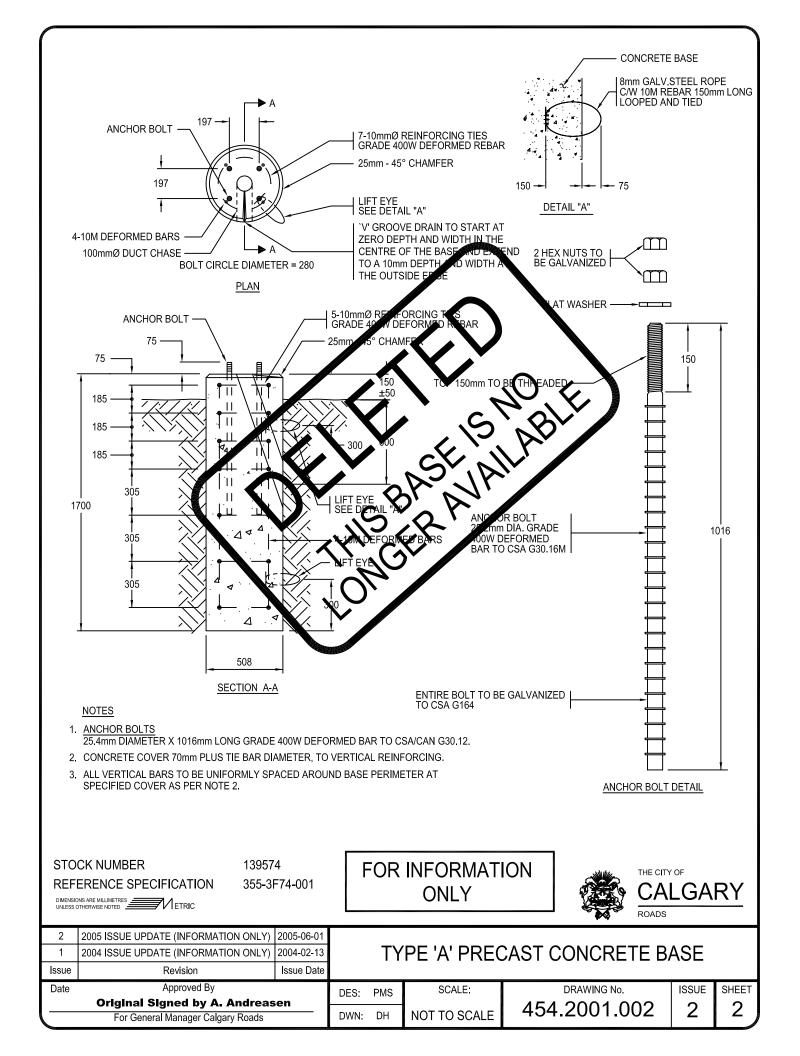
STREE	STREETLIGHT POLE/CONCRETE FOUNDATION INDEX												
POLE TYPE	POLE B.C.D.	CONCRETE FOUNDATION									INSTALLATION		
POLE TIPE	POLE B.C.D.		B1	B2	С	C1	D	D1	Е	F	G	Н	DRAWINGS
5m WALKWAY (SEE NOTE 5)	254mm		•	•									454.2030.001
5m TRADITIONAL (17th AVE.)	280mm		•	•									454.2031.001
4.6m CHINATOWN	280mm		•	•									454.2033.001
5.5m KENSINGTON	270mm		•	•									454.2036.001
ROULLEVILLE STRAIGHT STEEL	267mm		•	•									454.2038.001
6.4m ELECTRIC AVE.	280mm		•	•									454.2044.001
7m TEAR DROP TRADITIONAL STEP	280mm	•											454.2046.001
ELBOW DRIVE	280mm	•											454.2046.003
7.8m McKENZIE TOWNE	280mm	•											454.2047.001
8.2m STRAIGHT STEEL	280mm		•	•									454.2048.001
9m/2.5m SINGLE DAVIT	280mm		•	•									454.2050.001
9m/2.5m DOUBLE DAVIT	280mm		•	•									454.2051.001
9m SQUARE STEEL	280mm	•											454.2052.001
12m ROUND TAPERED STEEL	348mm				•	•							454.2053.001
12m 16 SIDED TAPERED STEEL	348mm				•	•							454.2053.003
14m POLE W/ T-ARM ASSEMBLY	330mm				•	•					•	•	454.2054a.003
15m/2.5m SINGLE DAVIT	330mm				•	•					•	•	454.2054.001
15m/2.5m DOUBLE DAVIT	330mm				•	•					•	•	454.2055.001
20m/2.5m SINGLE DAVIT	396mm						•	•					454.2056.001
20m/2.5m DOUBLE DAVIT	396mm						•	•					454.2057.001
30m HIGH MAST	660mm								•				454.2058.001
30m HIGH MAST (RAISE/LOWER)	660mm									•			454.2059.001


DIMENSIONS ARE MILLIMETRES ETRIC


- 1. SEE MATERIAL STANDARDS AND SPECIFICATIONS FOR PRE-CAST BASE DETAIL DRAWINGS.
- 2. SEE CONSTRUCTION STANDARDS AND SPECIFICATIONS FOR POURED-IN-PLACE BASE DETAILS.
- 3. ALL BASES TO BE INSTALLED WITH A ±150mm PROJECTION ABOVE FINAL GRADE.
- 4. TYPE D AND E BASES MAY, AT THE CONTRACTORS DISCRETION AND WITH THE APPROVAL OF CALGARY ROADS, BE SUPPLIED BY THE CONTRACTOR AS PRECAST BASES.
- 5. 5m WALKWAY POLE DOES NOT MOUNT ON A CITY STANDARD PRE-CAST CONCRETE BASE. CONTRACTOR SHALL CONFIRM POLE B.C.D. AND BASE REQUIREMENTS PRIOR TO CONSTRUCTION.




4	2006 ISSUE UPDATE - WCE	2006-05-23											
3	2004 ISSUE UPDATE	2004-02-13	CONCRETE BASE INDEX										
Issue	Revision	Issue Date											
Date	Approved By		DES:	AD	SCALE:	DRAWING No.	ISSUE	SHEET					
						454.2001.001	1 1	1					
	For Director, Calgary Roads	_	DWN:	BD	NOT TO SCALE	454.2001.001	4						



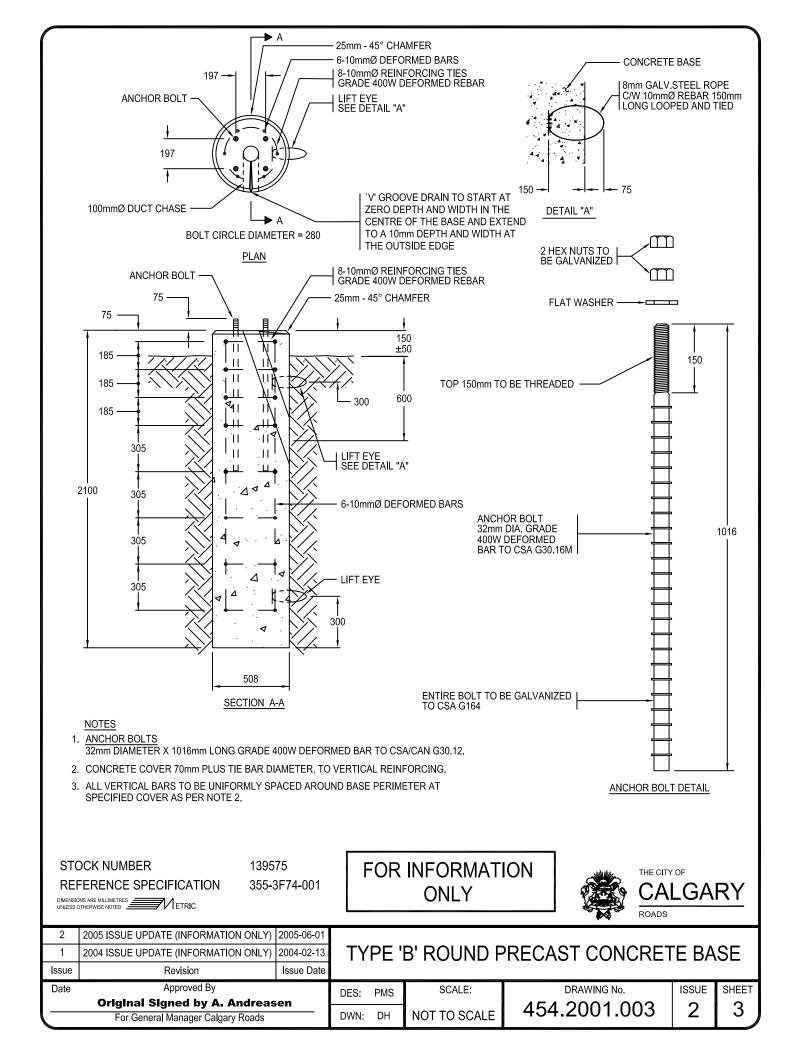

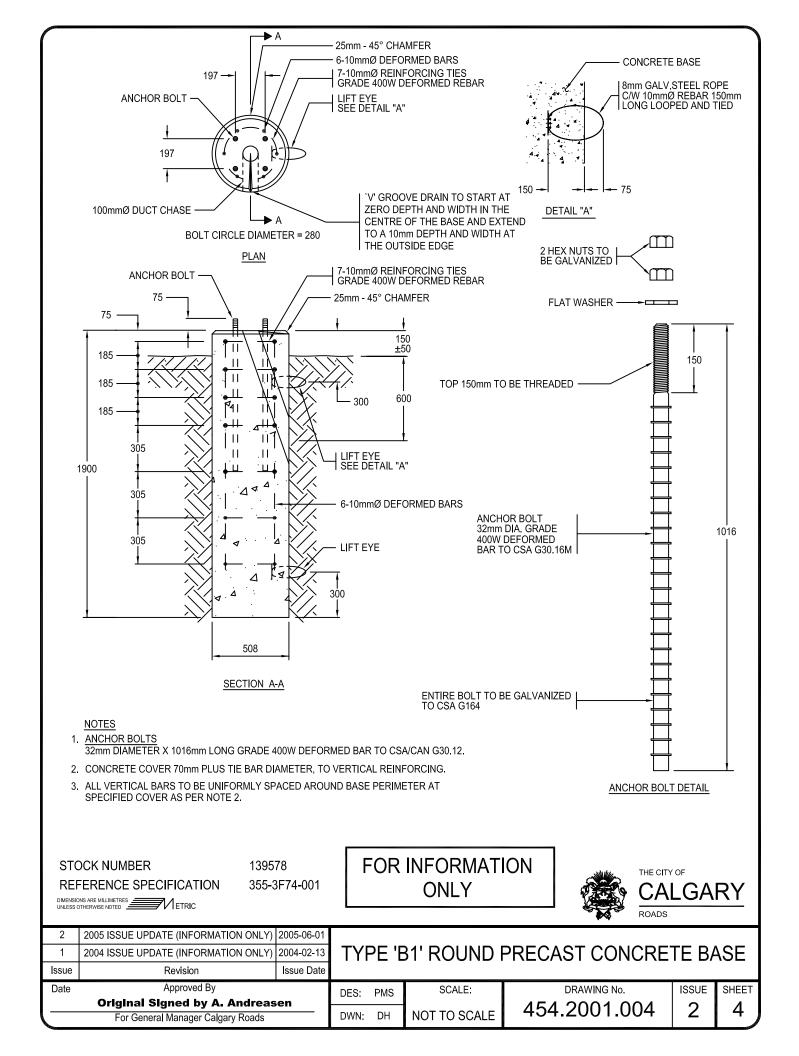

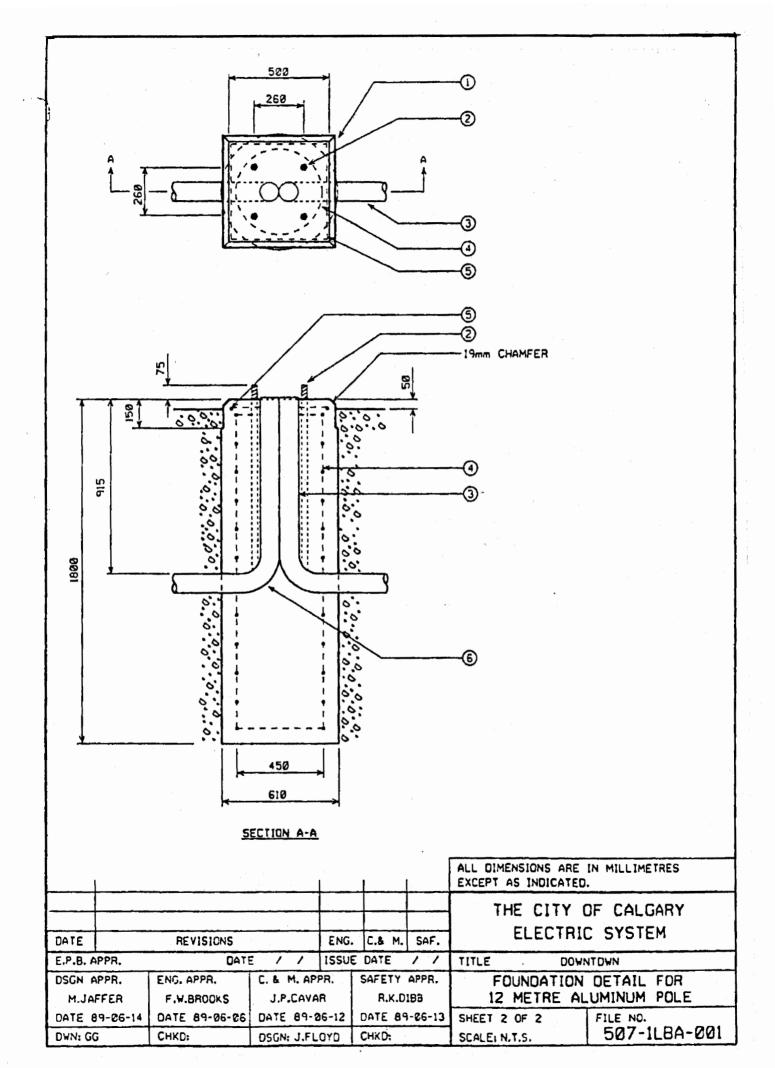



	e ge	<u> </u>		MATERIAL LIST	
ITEM	OTY	STOCK NUMBER	MFG		DESCRIPTION
ı	.75m³	N5610130003	F740	CONCRETE	30.0-MPA
2	4	SUPPLIED W/POLE		BOLT-ANCHOR	1-1/4X40IN-GALVANIZED
3	ı	R5630020146	D772	OUCT-FRE	4 [N
4	3m <sup>2</sup>	N9528828881	F740	MESH-WIRE	6×61N
5	4	95100300177	F740	REBAR	15m-*5-65FT-POLE
6	2	R5630020161	0772	BEND-FRE	41NX90-DEGREE
7	2m	N5640090002	F740	SONOTUBE	24IN


#### NOTES: -


- 1) THE CONCRETE MUST HAVE A MINIMUM COMPRESSIVE STRENGTH OF 30 MPA AT 28 DAYS & 5 TO 7 PERCENT ENTRAINED AIR.
- 2) THE MESH MUST HAVE A MINIMUM OF 50mm OF CONCRETE COVERAGE.
- 3) THE MESH IS TO BE MADE FROM 10 GAUGE WIRE.
- 4) SCNOTUBE IS TO BE USED AS A FORM FOR THE CONCRETE.
- 5) THE ANCHOR BOLTS ARE TO BE 31.75 IN DIAMETER & 1016 LONG FULLY GALVANIZED.
- 6) THE ANCHOR BOLTS ARE TO BE MADE FROM DEFORMED BAR CSA SPECIFICATION A-615-68. THE BOLT MUST HAVE A MINIMUM YIELD STRENGTH OF 40,000 PSI.
- 7) THE BASE IS TO BE POURED SO THAT THE TOP IS 50mm ABOVE THE SIDEWALK.
- 8) THE BOLT CIRCLE DIAMETER IS TO BE 368mm.
- 9) ITEM 5. THE REBAR MUST BE CUT OR FORMED INTO A 500 X 500mm SOUARE.


							ALL DIMENSIONS ARE IN MILLIMETRES EXCEPT AS INDICATED.			
· · · · · · · · · · · · · · · · · · ·	<u> </u>		<u>.</u>				THE CITY OF CALGARY			
DATE		REVISIONS		ENG	. C.8 M.	SAF.	ELECTRIC SYSTEM			
E.P.B.	APPR.	DATI	E / /	/ ISSUE DATE / /			TITLE			
DSGN APPR. ENG. APPR. M.JAFFER F.W.BROOKS		C. & M. APPR.		SAFETY APPR. R.K.DIBB		FOUNDATION DETAIL FOR 12 METRE ALUMINIUM POLE				
DATE	89-06-14	DATE 89-06-06	DATE 89-	26-12	DATE 89	-06-13	SHEET LOF 2	FILE NO.		
DWN: C	AS	CHKO:	DSGN:J.FL	CYC	CHKD:		SCALE: N.T.S.	507-1LBA-001		

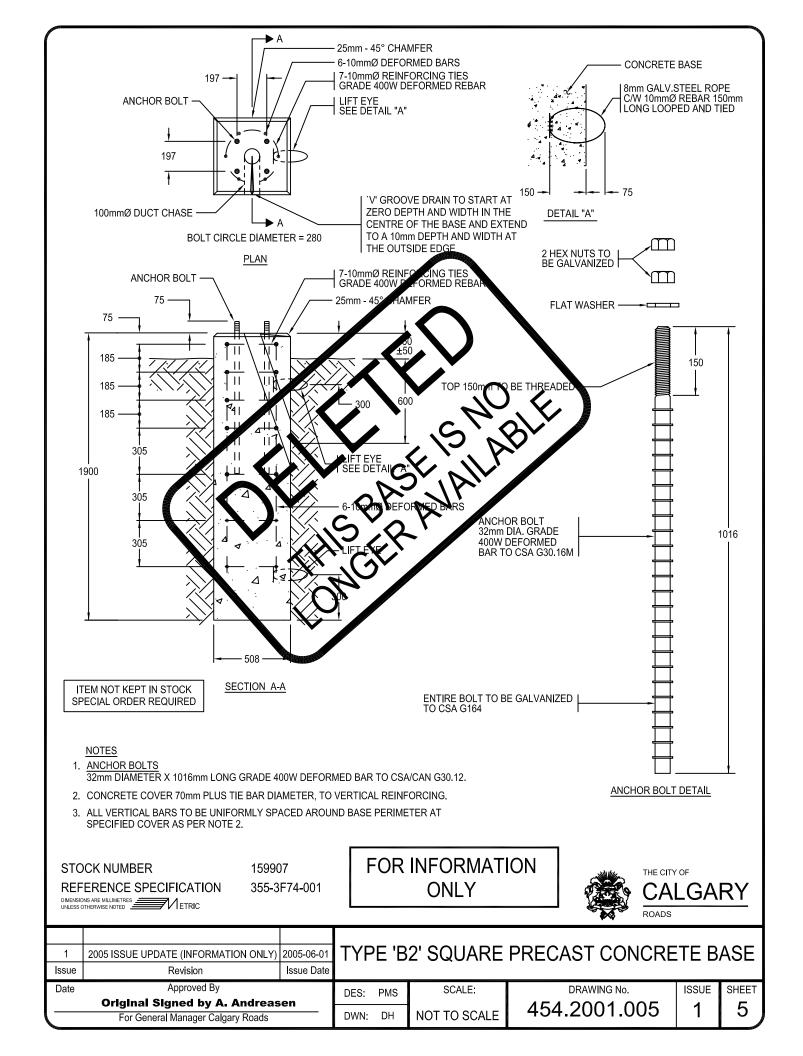

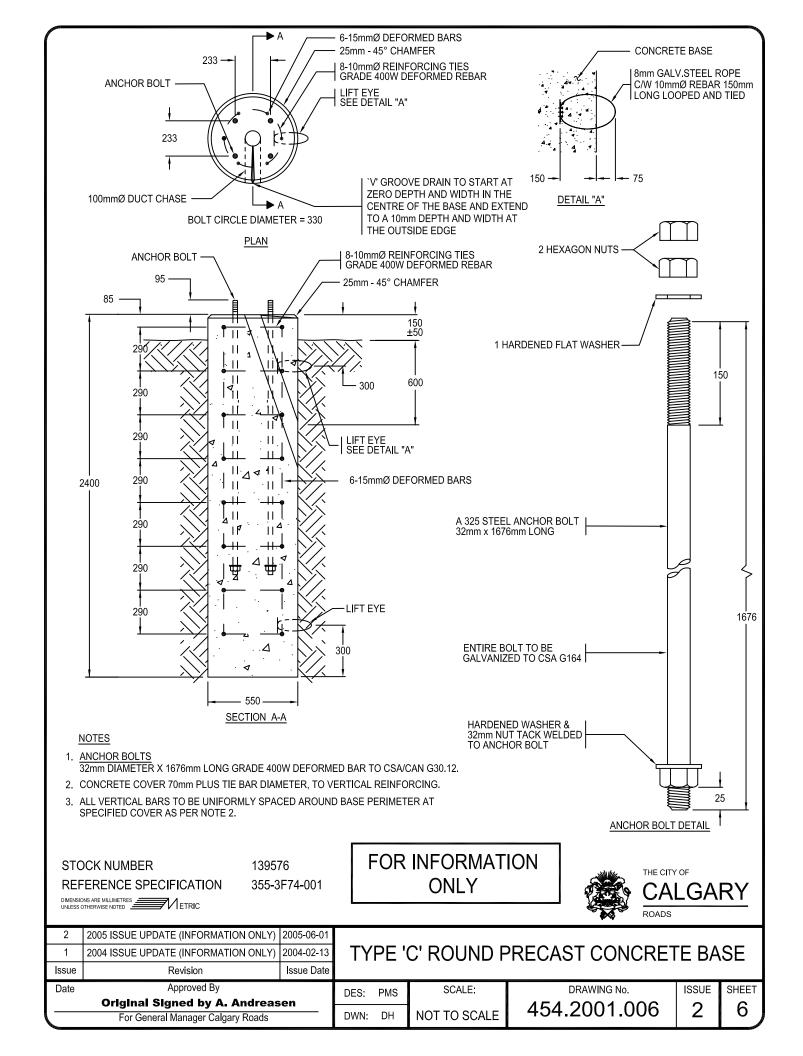

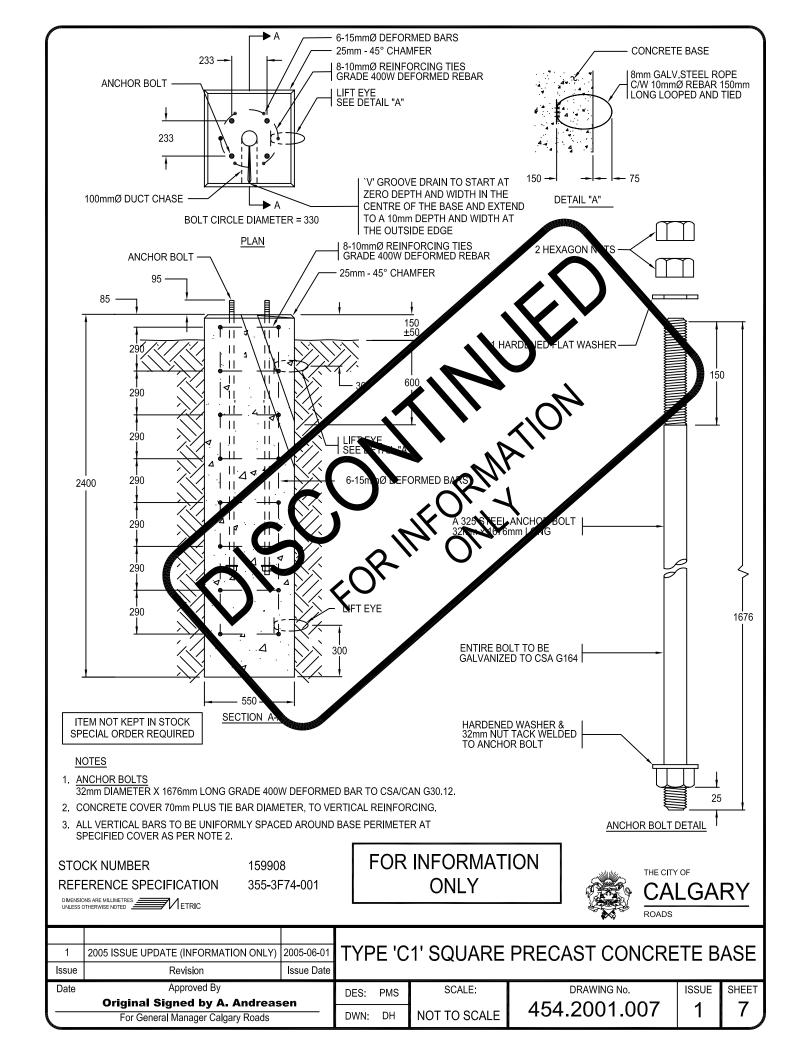

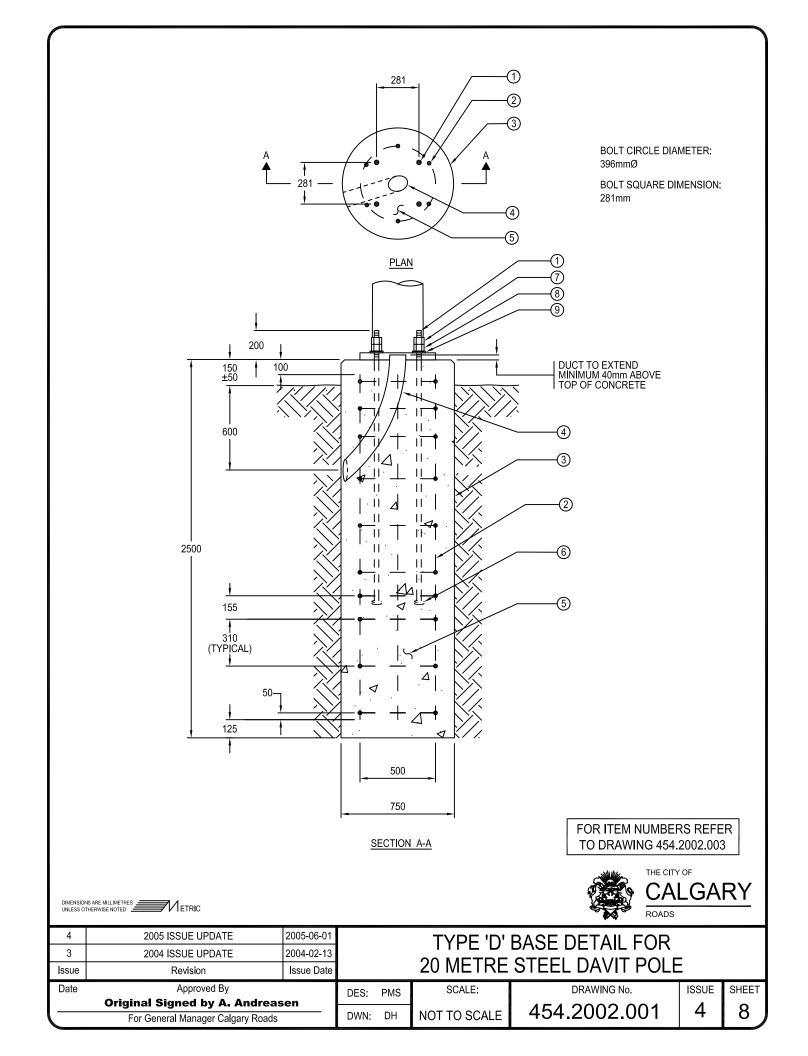

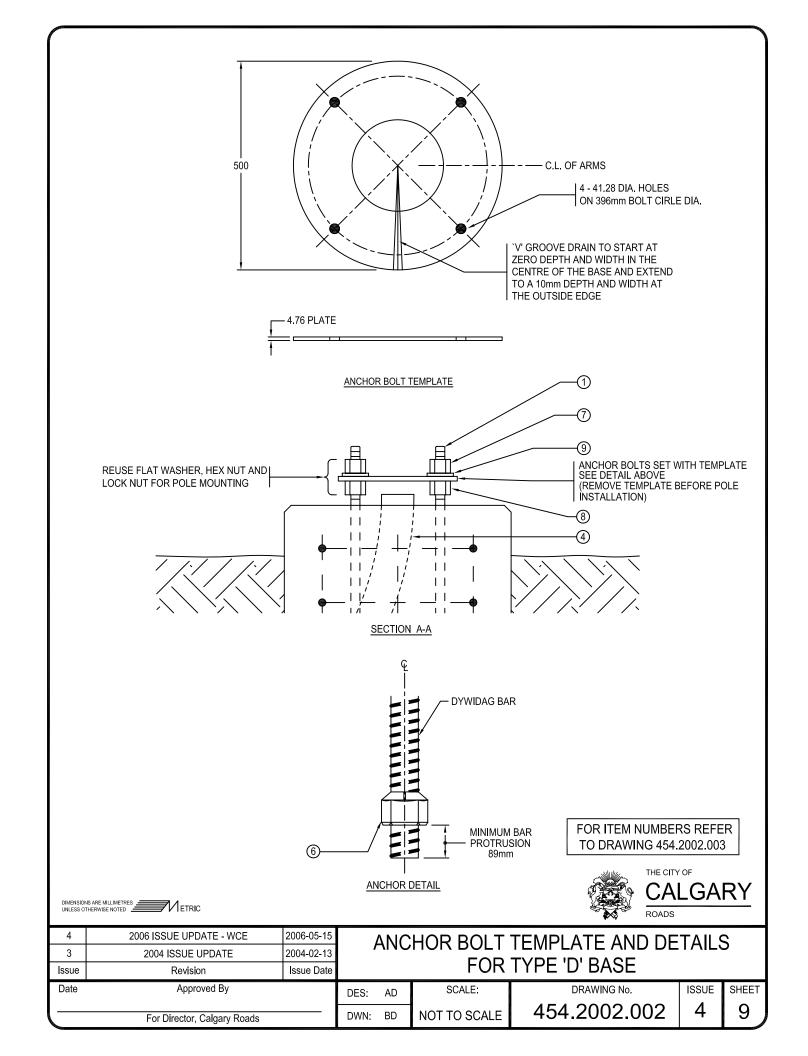

	MATERIAL LIST										
ITEM	QTY	STOCK NUMBER		DESCRIPTION	SUPPLIER						
1	4	151019	BOLT - ANCHOR	32mmØ x 1525mm GRADE 150 DYWIDAG	ROADS						
2	1	151037	REBAR CAGE		ROADS						
3	1	-	SONOTUBE	760mm	CONTRACTOR						
4	1	-	DUCT BEND	100mmØ	CONTRACTOR						
5	1.2m	-	CONCRETE	35.0-MPA	CONTRACTOR						
6	4	138510	ANCHOR NUT	32mmØ DYWIDAG	ROADS						
7	4	138508	LOCK NUT	32mmØ DYMIDAG	ROADS						
8	4	138509	HEX NUT	32mmØ DYWIDAG	ROADS						
9	4	138584	FLAT WASHER	32mmØ DYMIDAG	ROADS						

- 1. MINIMUM CONCRETE COVERAGE OVER WIRE REINFORCING STEEL SHALL BE 75mm.
- 2. SONOTUBE SHALL BE USED TO FORM THE TOP 600mm OF THE FOUNDATION. FULL LENGTH ONLY REQUIRED IF UNSTABLE SOIL CONDITIONS ARE ENCOUNTERED.
- 3. THE DUCT SHALL EXTEND 40mm ABOVE THE TOP OF THE FOUNDATION.
- 4. A 25mm WIDE CHAMFER SHALL BE TROWELLED INTO THE TOP EDGE OF THE FOUNDATION.
- 5. THE DUCT SHALL EXTEND FROM THE SIDE OF BASE A MINIMUM OF 150mm.
- 6. THE TOP OF THE FOUNDATION SHALL BE SMOOTH AND LEVEL WITHIN 3mm BETWEEN ANY TWO BOLTS.
- 7. THE BOLTS SHALL BE PLUMB AND SET TO THE BOLT CIRCLE DIAMETER. THE MAXIMUM DEVIATION FROM TRUE DIMENSIONS ON ANY TWO BOLTS SHALL NOT EXCEED 5mm IN TOTAL.
- 8. THE BOTTOM OF THE FOUNDATION SHALL BE PLACED ON UNDISTURBED OR COMPACTED SOIL.
- 9. USE ANCHOR BOLT TEMPLATE AS PER DETAIL ON SHEET 9.

#### **REBAR CAGE:**

- 1. SIX 20mm VERTICAL BARS 2275mm LONG SHALL BE EQUALLY SPACED ON 500mm DIA. CIRCLE.
- 2. TEN 10m TIES SHALL BE 310mm ON CENTRE EXCEPT AS SHOWN AND TACK WELDED.
- 3. REINFORCING STEEL SHALL BE GRADE 400 DEFORMED BARS.

#### **CONCRETE SPECIFICATIONS:**


- 1. THE CONCRETE SHALL MEET THE REQUIREMENT OF CHAPTER 310 PORTLAND CEMENT CONCRETE.
- 2. MINIMUM COMPRESSIVE STRENGTH 35 MPA AT 28 DAYS. MINIMUM 5-7% ENTRAINED AIR, TYPE 50 CONCRETE,


NOTE: NO WATER IS TO BE ADDED TO THE CONCRETE AT THE SITE.






4	2006 ISSUE UPDATE - WCE	2006-05-15		MATERIAL LIST FOR							
3	2004 ISSUE UPDATE	2004-02-13									
Issue	Revision	Issue Date		TYPE 'D' BASE							
Date	Approved By		DES:	AD	SCALE:	DRAWING No.	ISSUE	SHEET			
			DWN:		NOT TO COALE	454.2002.003	4	10			
For Director, Calgary Roads				BD	NOT TO SCALE	+3+.2002.003					

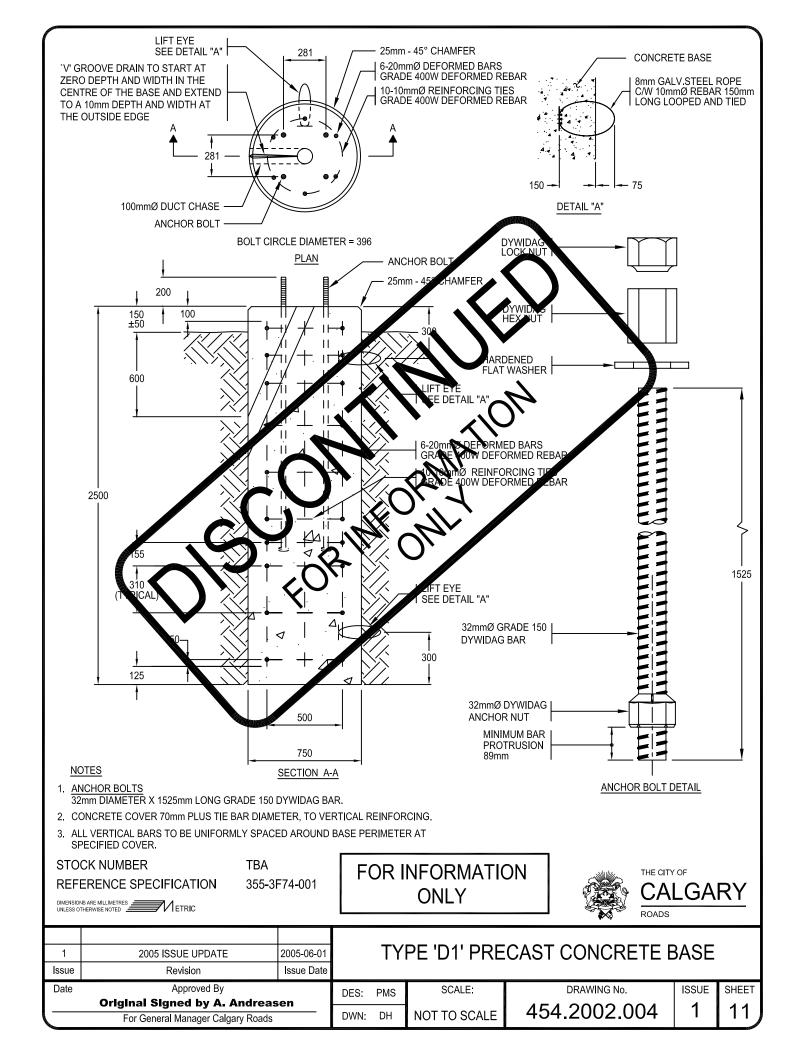

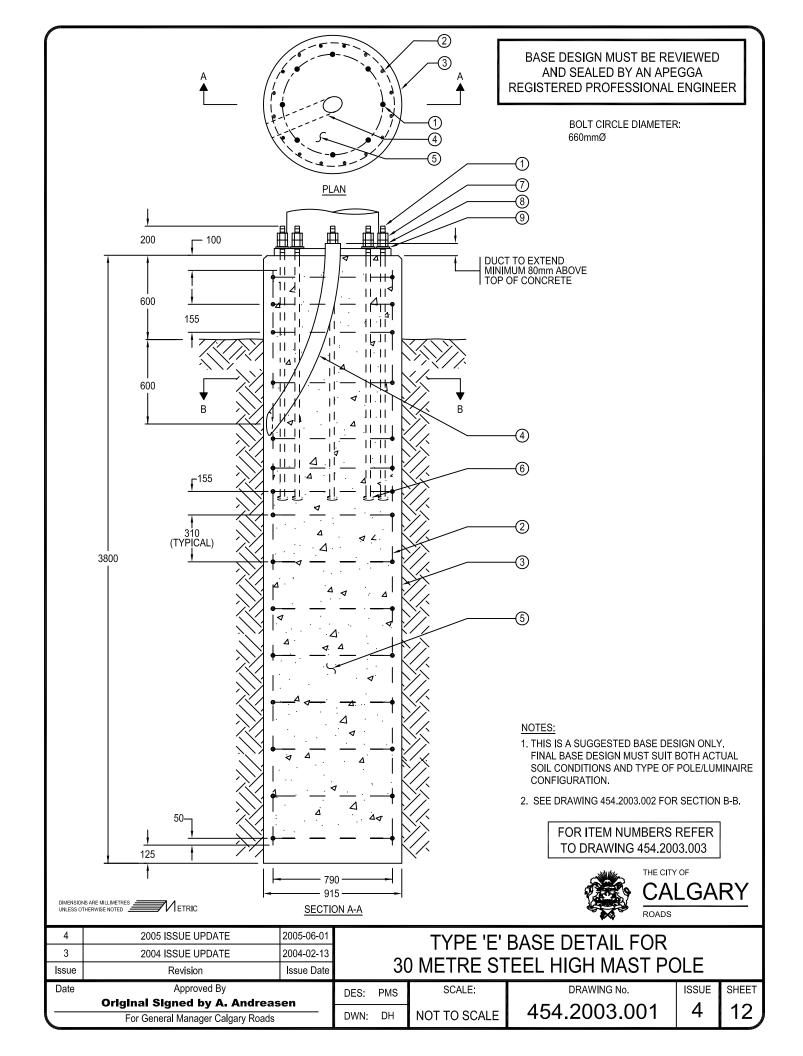

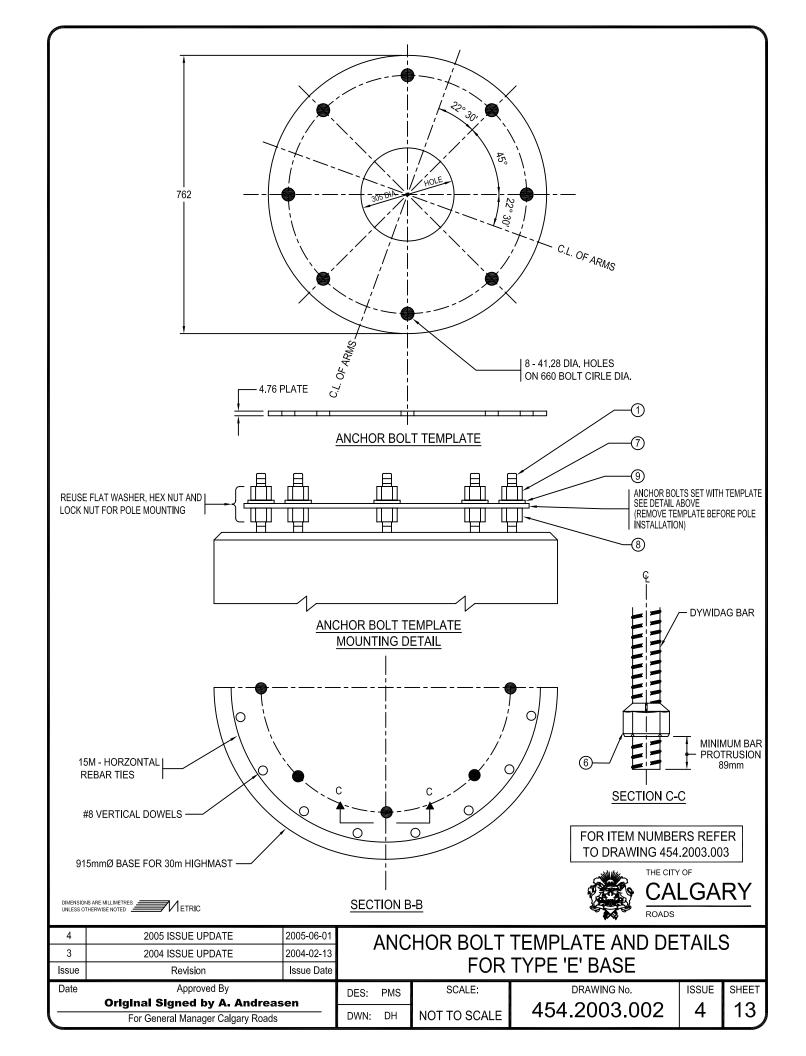

	MATERIAL LIST										
ITEM	QTY	STOCK NUMBER		DESCRIPTION	SUPPLIER						
1	8	151018	BOLT - ANCHOR	32mmØ x 1778mm GRADE 150 DYWIDAG	ROADS						
2	-	-	REINFORCING ST	CONTRACTOR							
3	3.8m	-	SONOTUBE	915mm	CONTRACTOR						
4	1	-	DUCT BEND	100mmØ	CONTRACTOR						
5	2,6m	-	CONCRETE	35.0-MPA	CONTRACTOR						
6	8	138499	ANCHOR NUT	32mmØ	ROADS						
7	8	138508	LOCK NUT	32mmØ	ROADS						
8	8	138509	HEX NUT	32mmØ	ROADS						
9	8	138584	FLAT WASHER	32mmØ	ROADS						

- 1. MINIMUM CONCRETE COVERAGE OVER WIRE REINFORCING STEEL SHALL BE 75mm.
- 2. SONOTUBE SHALL BE USED TO FORM THE TOP 600mm OF THE FOUNDATION. FULL LENGTH ONLY REQUIRED IF UNSTABLE SOIL CONDITIONS ARE ENCOUNTERED.
- 3. THE DUCT SHALL EXTEND 80mm ABOVE THE TOP OF THE FOUNDATION.
- 4. A 25mm WIDE CHAMFER SHALL BE TROWELLED INTO THE TOP EDGE OF THE FOUNDATION.
- 5. THE DUCT SHALL EXTEND FROM THE SIDE OF BASE A MINIMUM OF 150mm.
- 6. THE TOP OF THE FOUNDATION SHALL BE SMOOTH AND LEVEL WITHIN 3mm BETWEEN ANY TWO BOLTS.
- 7. THE BOLTS SHALL BE PLUMB AND SET TO THE BOLT CIRCLE DIAMETER. THE MAXIMUM DEVIATION FROM TRUE DIMENSIONS ON ANY TWO BOLTS SHALL NOT EXCEED 5mm IN TOTAL.
- 8. THE BOTTOM OF THE FOUNDATION SHALL BE PLACED ON UNDISTURBED OR COMPACTED SOIL.
- 9. USE ANCHOR BOLT TEMPLATE AS PER DETAIL ON SHEET 13.


#### REINFORCING STEEL:

- 1. SIXTEEN # 8 VERTICAL DOWELS 3575mm LONG, EQUALLY SPACED ON 790mmØ CIRCLE.
- 2. FIFTEEN 15M TIES SHALL BE 310mmØ ON CENTER (EXCEPT AS SHOWN) AND TACK WELDED.
- 3. REINFORCING STEEL SHALL BE GRADE 400 DEFORMED BARS.

#### **CONCRETE SPECIFICATIONS:**


- 1. THE CONCRETE SHALL MEET THE REQUIREMENT OF CHAPTER 310 PORTLAND CEMENT CONCRETE.
- 2. MINIMUM COMPRESSIVE STRENGTH 35 MPA AT 28 DAYS. MINIMUM 5-7% ENTRAINED AIR. TYPE 50 CONCRETE.


NOTE: NO WATER IS TO BE ADDED TO THE CONCRETE AT THE SITE.

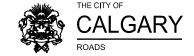



4	2005 ISSUE UPDATE	2005-06-01		MATERIAL LIST FOR								
3	2004 ISSUE UPDATE	2004-02-13	W (12) (1) (2 2) (1) (1)									
Issue	Revision	Issue Date		TYPE 'E' BASE								
Date	Approved By		DES:	PMS	SCALE:	DRAWING No.	ISSUE	SHEET				
Original Signed by A. Andreasen						454.2003.003	1	14				
For General Manager Calgary Roads			DWN:	DH	NOT TO SCALE	454.2005.005	4	14				

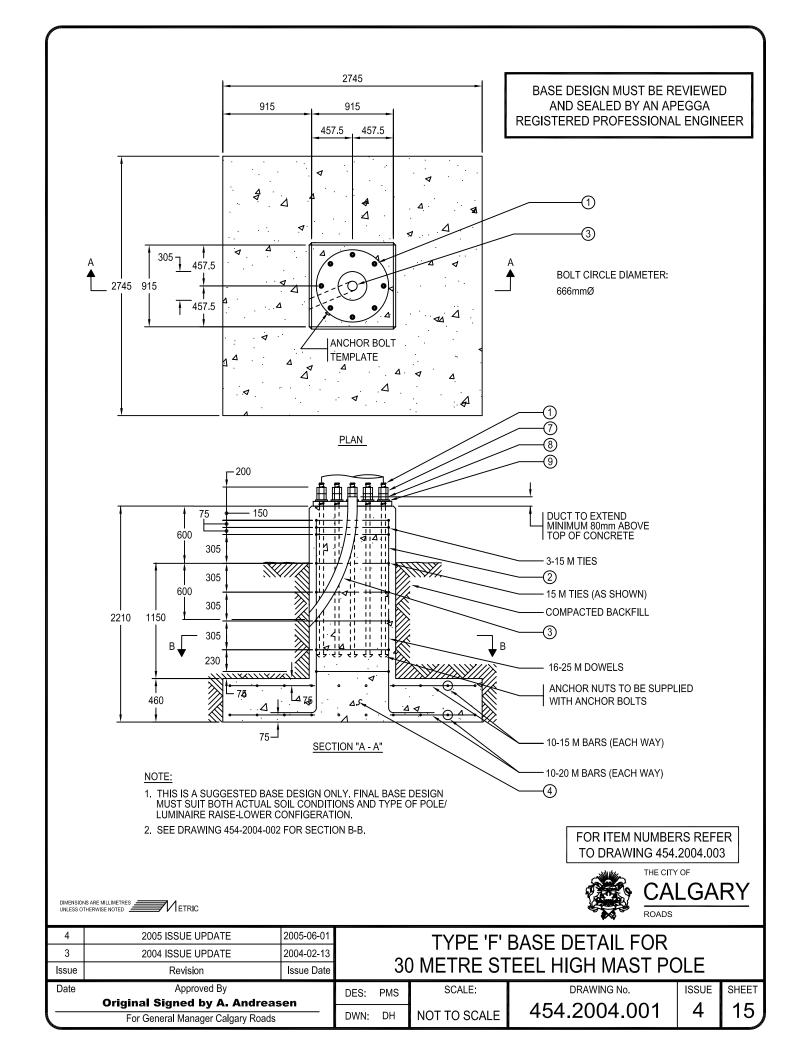

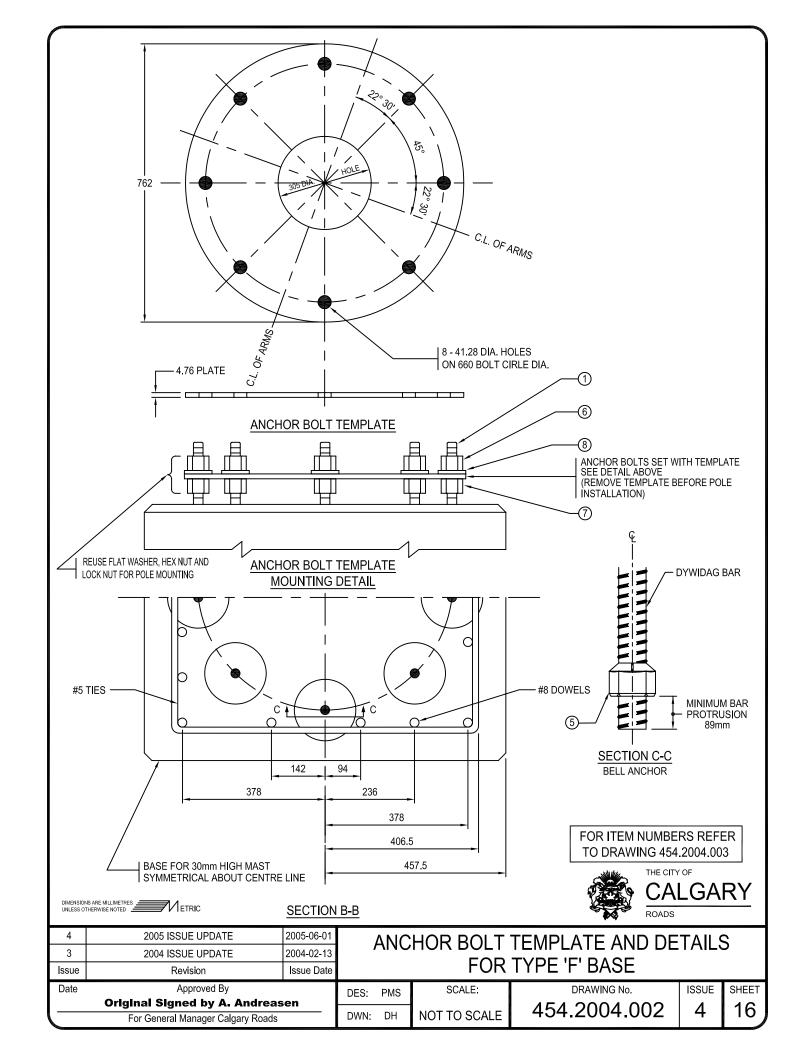

MATERIAL LIST									
ITEM	QTY	STOCK NUMBER		DESCRIPTION					
1	4	151018	BOLT - ANCHOR	ROADS					
2	-	-	REINFORCING ST	CONTRACTOR					
3	1	-	DUCT BEND	100mmØ	CONTRACTOR				
4	4.9m	-	CONCRETE	35.0-MPA	CONTRACTOR				
5	8	138499	ANCHOR NUT	32mmØ	ROADS				
6	8	138508	LOCK NUT	32mmØ	ROADS				
7	8	138509	HEX NUT	32mmØ	ROADS				
8	8	138584	FLAT WASHER	32mmØ	ROADS				

- 1. MINIMUM CONCRETE COVERAGE OVER WIRE REINFORCING STEEL SHALL BE 75mm.
- 2. THE DUCT SHALL EXTEND 80mm ABOVE THE TOP OF THE FOUNDATION.
- 3. A 25mm WIDE CHAMFER SHALL BE TROWELLED INTO THE TOP EDGE OF THE FOUNDATION.
- 4. THE DUCT SHALL EXTEND FROM THE SIDE OF BASE A MINIMUM OF 150mm.
- 5. THE TOP OF THE FOUNDATION SHALL BE SMOOTH AND LEVEL WITHIN 3mm BETWEEN ANY TWO BOLTS.
- THE BOLTS SHALL BE PLUMB AND SET TO THE BOLT CIRCLE DIAMETER. THE MAXIMUM DEVIATION FROM TRUE DIMENSIONS ON ANY TWO BOLTS SHALL NOT EXCEED 5mm IN TOTAL.
- 7. THE BOTTOM OF THE FOUNDATION SHALL BE PLACED ON UNDISTURBED SOIL.
- 8. USE ANCHOR BOLT TEMPLATE AS PER DETAIL ON SHEET 16.

# CONCRETE SPECIFICATIONS:

- 1. THE CONCRETE SHALL MEET THE REQUIREMENT OF CHAPTER 310 PORTLAND CEMENT CONCRETE.
- 2. MINIMUM COMPRESSIVE STRENGTH 35 MPA AT 28 DAYS. MINIMUM 5-7 % ENTRAINED AIR. TYPE 50 CONCRETE

NOTE: NO WATER IS TO BE ADDED TO THE CONCRETE AT THE SITE.





4	2005 ISSUE UPDATE	2005-06-01		ΜΔΤΕ	RIAL LIST FOR
3	2004 ISSUE UPDATE	2004-02-13			
Issue	Revision	Issue Date		IY	PE 'F' BASE
Date	Approved By		DES: PMS	SCALE:	DRAWING No.


Original Signed by A. Andreasen
For General Manager Calgary Roads


DES: PMS SCALE:

DWN: DH NOT TO SCALE

454.2004.003

ISSUE SHEET 4 17

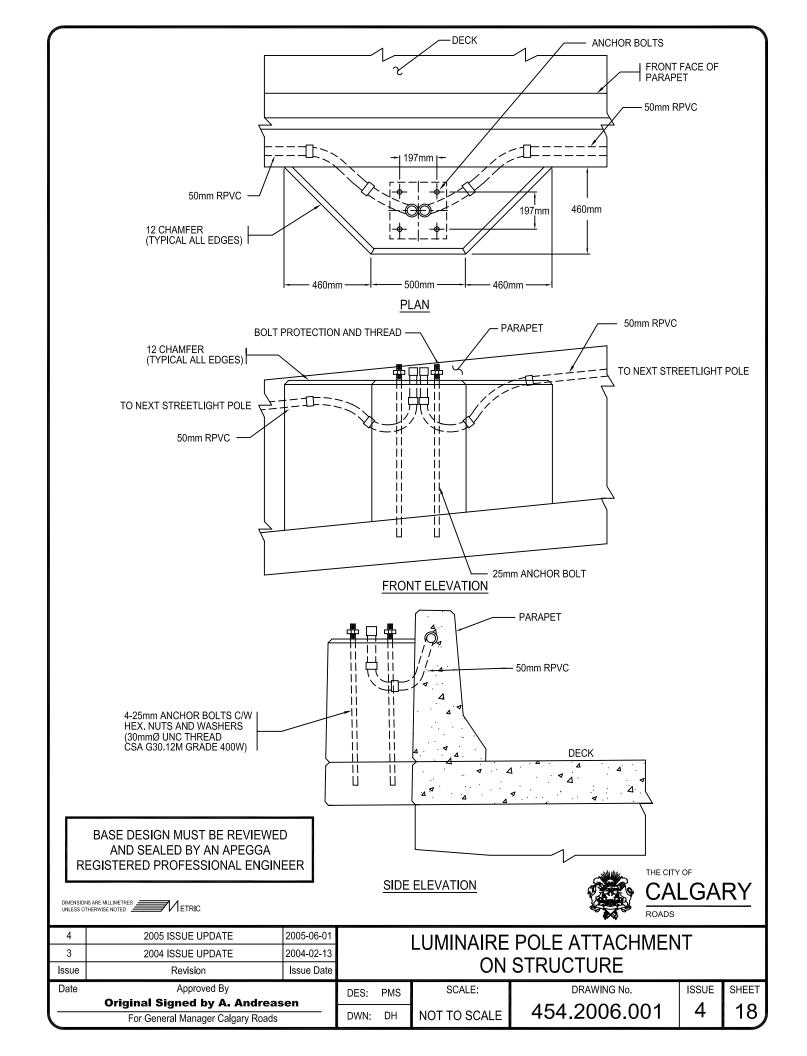

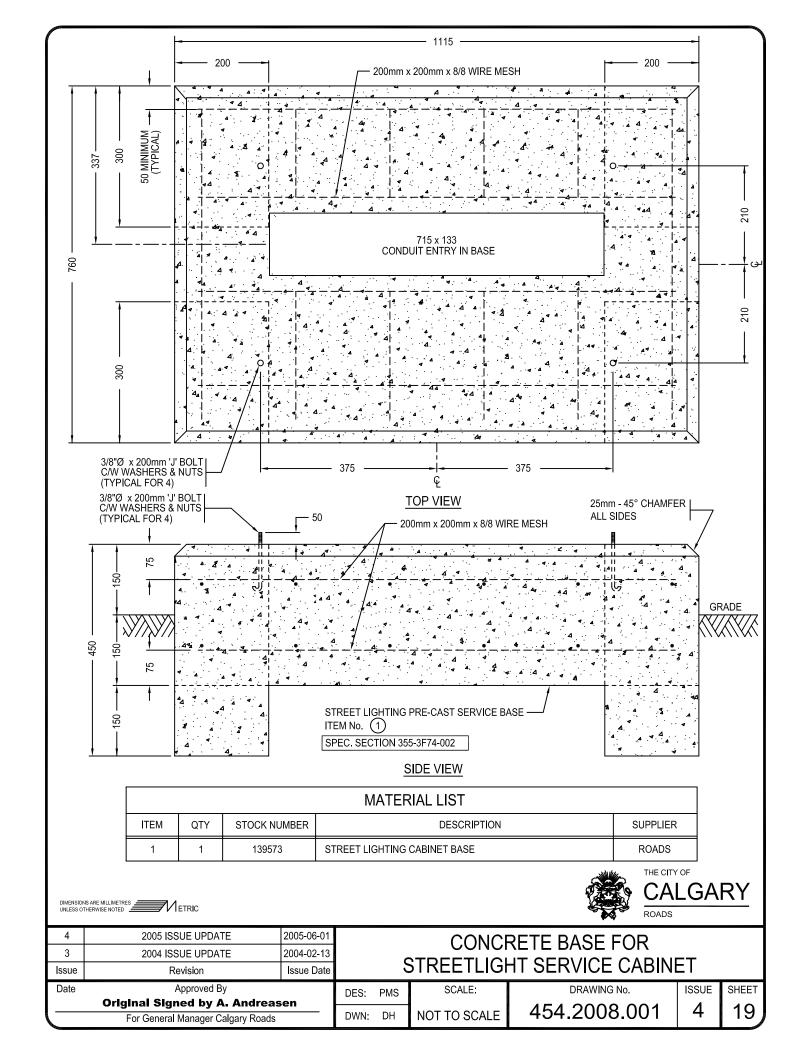

# ANCHOR BOLT REPAIR PROCEDURES

# 1.0 GENERAL

ANCHOR BOLT DAMAGE IS CLASSED AS THE BENDING OR STRETCHING OF THE BOLTS TO THE POINT THAT A POLE CAN NOT BE REMOVED OR INSTALLED.

# 2.0 REPAIR PROCEDURE

REPAIR OF ANCHOR BOLTS SHALL BE AS DETAILED ON DRAWING 454.2009.002

WHERE AN ANCHOR BOLT REQUIRES REPAIR, THE BOLT SHALL BE SAW CUT OFF AND A COUPLER INSTALLED. ANCHOR BOLT COUPLERS SHALL BE USED AS FOLLOWS:

A) 4 ANCHOR BOLT BASE
B) 6 TO 8 ANCHOR BOLT BASE

- MAXIMUM 1 COUPLER PER BASE

- MAXIMUM 2 COUPLERS PER BASE


WHERE THE NUMBER OF COUPLERS REQUIRED PER BASE EXCEEDS THE NUMBER ALLOWED, THE BASE MUST BE REPLACED.

ANY DEVIATIONS FROM THESE PROCEDURES MUST BE APPROVED BY THE ENGINEER PRIOR TO CONSTRUCTION.





4	2005 ISSUE UPDATE	2005-06-01		ANCHOR BOLT				
3	2004 ISSUE UPDATE	2004-02-13			, ,			
Issue	Revision	Issue Date			REPAII	R PROCEDURES		
Date	e Approved By		DES:	PMS	SCALE:	DRAWING No.	ISSUE	SHEET
Original Signed by A. Andreasen						454.2009.001	1 1	20
	For General Manager Calgary Roads			DH	NOT TO SCALE	454.2009.001	4	20 )

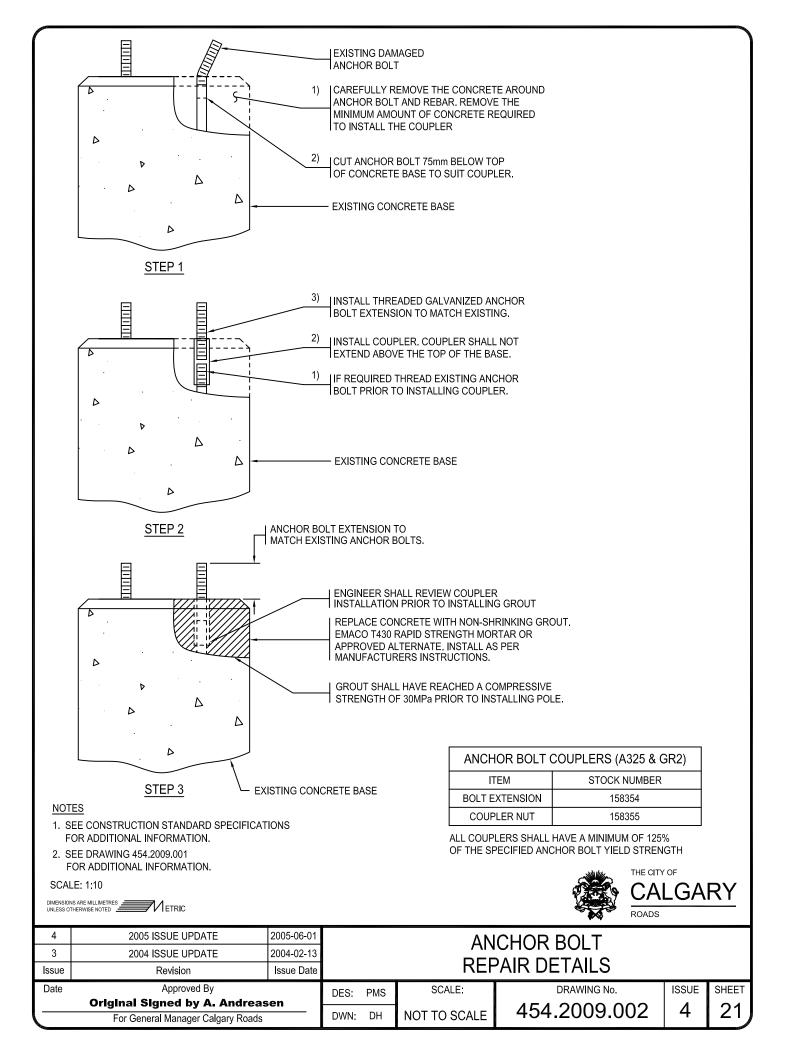

# BREAKAWAY BASE INSTALLATIONS - ALL ANCHOR BOLT SIZES

# BEFORE PROCEEDING WITH THE INSTALLATION

ASCERTAIN THAT THE POLE BASE REQUIREMENTS HAVE BEEN MET AND THAT THE PROPER REACTION PLATE IN AVAILABLE. THE CONCRETE BASE MUST BE IN GOOD CONDITION, AND IT MUST BE FIRMLY BEDDED DOWN IN THE SOIL. THE HEIGHT OF THE BASE ABOVE GRADE MUST BE AT A HEIGHT SO THAT IT DOES NOT ABSORB THE IMPACT LOAD OF THE VEHICLE IN THE EVENT OF A COLLISION. THE UPPER SURFACE OF THE BASE SHOULD BE LEVEL, AND IT SHOULD EXTEND AT LEAST 3" BEYOND THE BOLT SQUARE. THE ANCHOR BOLTS MUST EXTEND NOT LESS THAN 2-1/2" BUT NOT MORE THAN 3-1/4" ABOVE THE BASE SURFACE.

## **PROCEDURE**


- 1. CLEAN THE UPPER SURFACE OF THE POLE BASE, AND PLACE ON IT THE REACTION PLATE. IT A SLOTTED REACTION PLATE IS USED, IT IS RECOMMENDED THAT THE SLOT BE ORIENTED TOWARDS THE ONCOMING TRAFFIC. ENSURE THAT THE ANCHOR BOLTS DO NOT EXTEND MORE THAN 1-1/" ABOVE THE REACTION PLATE.
- 2. SCREW THE COUPLER ASSEMBLY ONTO EACH ANCHOR BOLT. (ENSURE THAT THE STUD IS ENGAGED AT LEAST 1-1/2" BUT NOT MORE THAN 1-3/4" INTO THE COUPLER BEFORE LOCKING).
- 3. SNUG UP EACH COUPLER AGAINST THE REACTION PLATE. TIGHTEN EACH COUPLER ALTERNATELY AND INCREMENTALLY ON THE BOTTOM OF THE COUPLER, WITH APPROXIMATELY 350 FOOT POUNDS OF TORQUE.


WARNING: TIGHTENING THE COUPLER ON THE TOP HEX MAY WEAKEN THE COUPLER AT THE BREAK POINT.

- 4. BRING THE LEVELLING NUTS AND WASHERS INTO A LEVEL PLANE, MAKING CERTAIN THAT AT LEAST ONE LEVELLING NUT AND SPACER REMAIN IN CONTACT WITH THE LOCKING NUT.
- 5. PLACE THE POLE BASE PLATE OVER THE PROTRUDING STUDS, AND SECURE THE POLE WITH THE UPPER WASHERS AND RETAINING NUTS.
- 6. WITH THE POLE IN THE REQUIRED VERTICAL ORIENTATION, AND BEFORE THE FINAL TIGHTENING, ENSURE THAT ALL LEVELLING NUTS AND WASHERS PLUS RETAINING NUTS AND WASHERS ARE MADE SNUG AGAINST THE POLE BASE PLATE.
- 7. TIGHTEN THE RETAINING NUTS WITH APPROXIMATELY 350 FOOT-POUNDS OF TORQUE. THE EXTERNAL POLE SUPPORT CAN NOW BE REMOVED.
- 8. MAKE NECESSARY WIRE CONNECTIONS, AND INSTALL THE PROTECTIVE SHROUD.
- 9. IT IS RECOMMENDED THAT THE THREADED ANCHOR BOLT/COUPLER CONNECTION BE COATED WITH A RUST INHIBITING GREASE. THIS WILL HELP FACILITATE REMOVAL OF THE COUPLER WHEN IT IS NECESSARY.

THE CITY OF

CALGARY

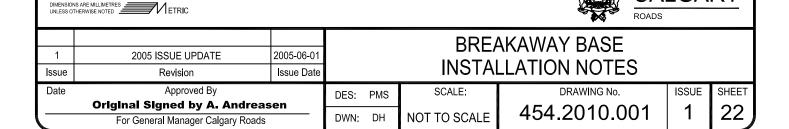

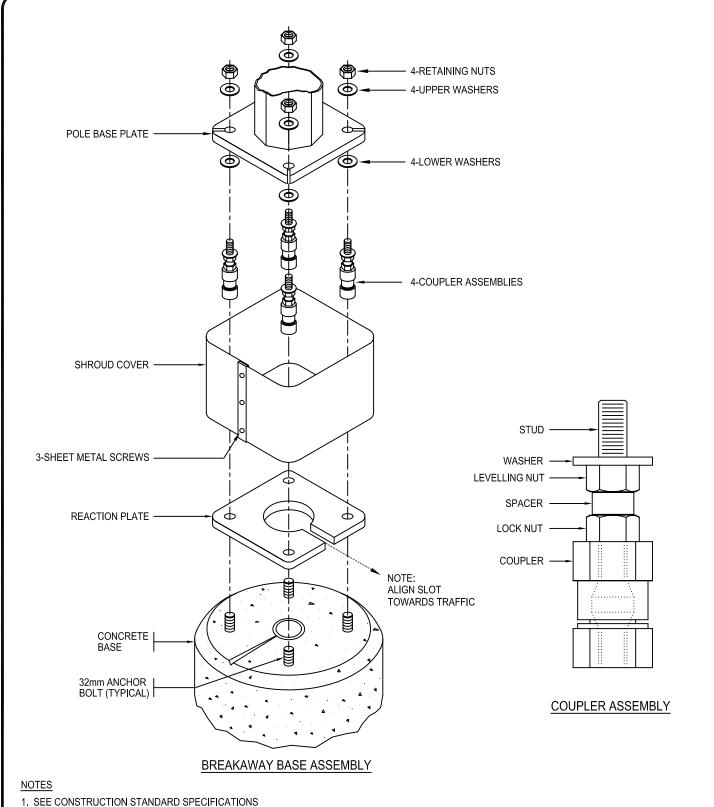


- SEE CONSTRUCTION STANDARD SPECIFICATIONS FOR ADDITIONAL INFORMATION.
- 2. SEE DRAWING 454.2010.001 FOR ADDITIONAL INFORMATION.





For General Manager Calgary Roads			DWN:	DH	NOT TO SCALE	454.2010.002	ı	23			
Original Signed by A. Andreasen					1	454.2010.002	1	22			
Date	Approved By		DES:	PMS	SCALE:	DRAWING No.	ISSUE	SHEET			
Issue	ssue Revision Issue Date			INSTALLATION DETAILS							
1	2005 ISSUE UPDATE	2005-06-01									
					BRF/	AKAWAY BASE					

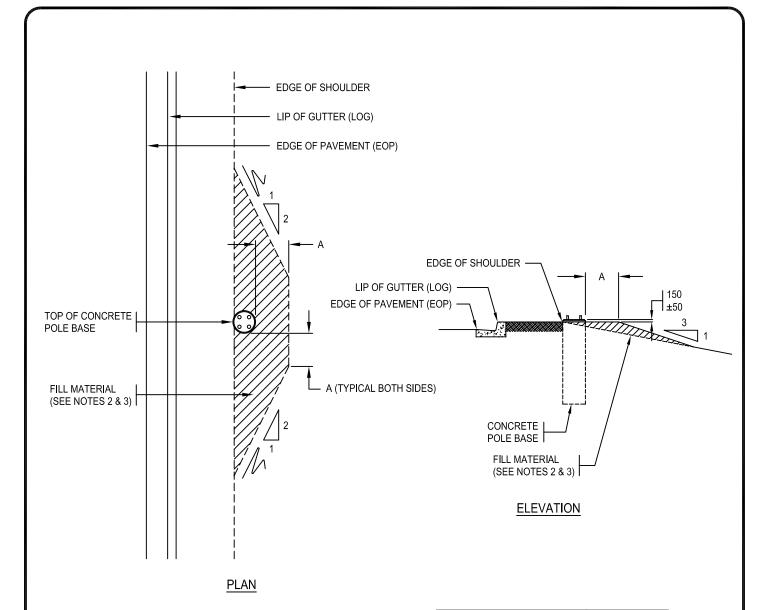


- 1. REFER TO CONTRACT DRAWINGS AND DETAILED SPECIFICATIONS.
- 2. FILL MATERIAL SHALL CONFORM TO SECTION 303.00.00
- 3. FILL MATERIAL SHALL BE SUPPLIED, INSTALLED AND FULLY COMPACTED IN ACCORDANCE WITH SECTION 304.00.00 FOR THE MINIMUM AREA ALL AROUND THE BASE AS SHOWN ABOVE.


BASE TYPES	A MIN. FILL
TYPE B, B1 & B2 CONCRETE BASES	2.1m
TYPE C & C1 CONCRETE BASES	2.4m
TYPE D & D1 CONCRETE BASES	2.5m






4	2005 ISSUE UPDATE	2005-06-01			F	OLE BASE					
3	3 2004 ISSUE UPDATE 2004-02-13										
Issue	Revision Issue Date			INSTALLATION DETAILS							
Date	Approved By		DES:	PMS	SCALE:	DRAWING No.	ISSUE	SHEET			
Original Signed by A. Andreasen						454.2015.001	1	24			
For General Manager Calgary Roads			DWN:	DH	NOT TO SCALE	434.2013.001	4	24			

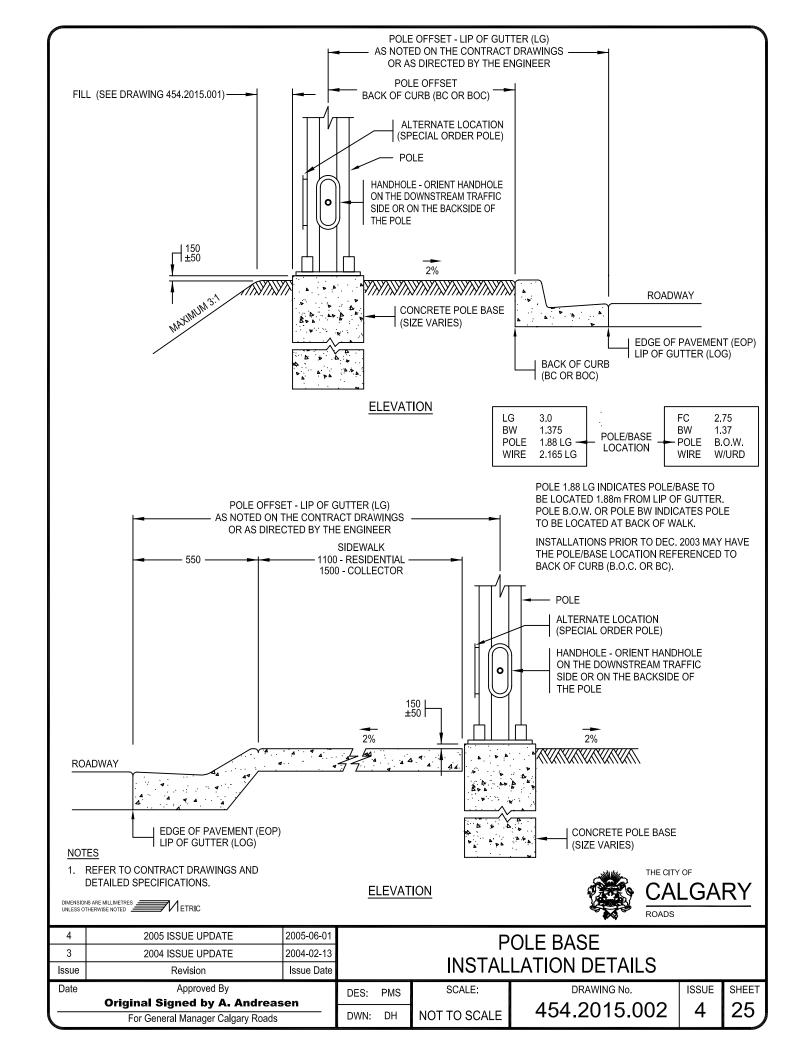

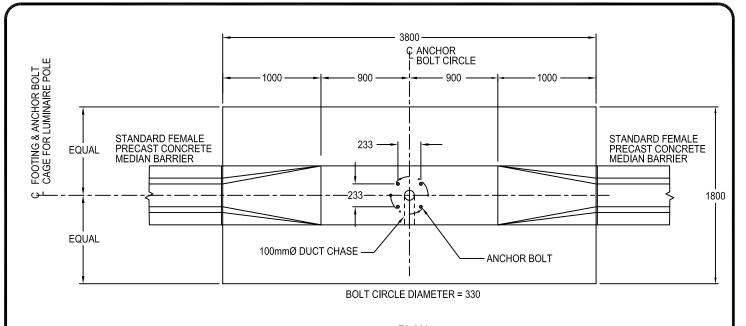

#### PLAN

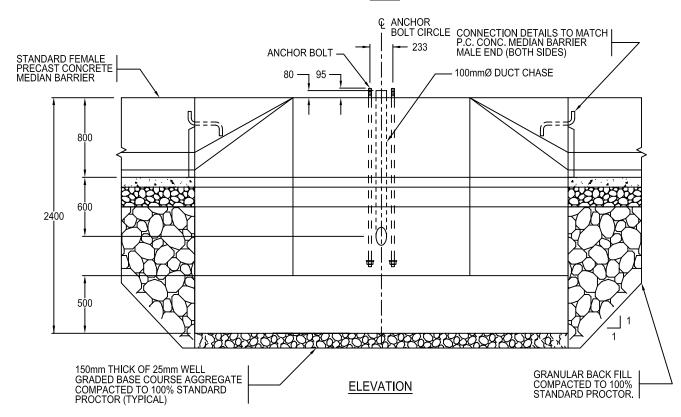

#### **NOTES**

DIMENSIONS ARE MILLIMETRES

- 1. ANCHOR BOLTS
  - 25.4 DIAMETER X 1676mm LONG GRADE 400W DEFORMED BAR TO CSA/CAN G30.12.
- 2. CONCRETE COVER 70mm PLUS TIE BAR DIAMETER, TO VERTICAL REINFORCING.
- 3. ALL VERTICAL BARS TO BE UNIFORMLY SPACED AROUND BASE PERIMETER AT SPECIFIED COVER AS PER NOTE 2.

BASE DESIGN MUST BE REVIEWED AND SEALED BY AN APEGGA REGISTERED PROFESSIONAL ENGINEER



3	2005 ISSUE UPDATE	2005-06-01
2	2004 ISSUE UPDATE	2004-02-13
leeuo	Povision	Iccuo Data

## TYPE G BASE FOR 15 METRE DAVIT POLE IN MEDIAN BARRIER

Date Approved By

Original Signed by A. Andreasen

For General Manager Calgary Roads


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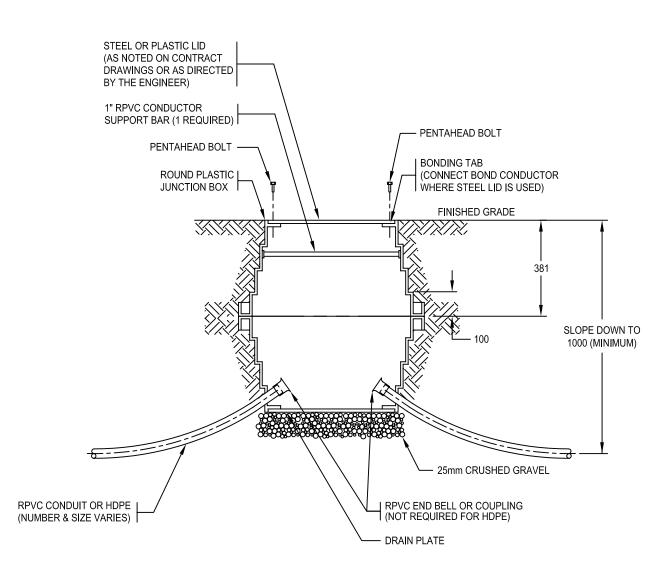
DWN: DH NOT TO SCALE

DRAWING No. 454.2016.001

ISSUE 3


SHEEТ **26** 



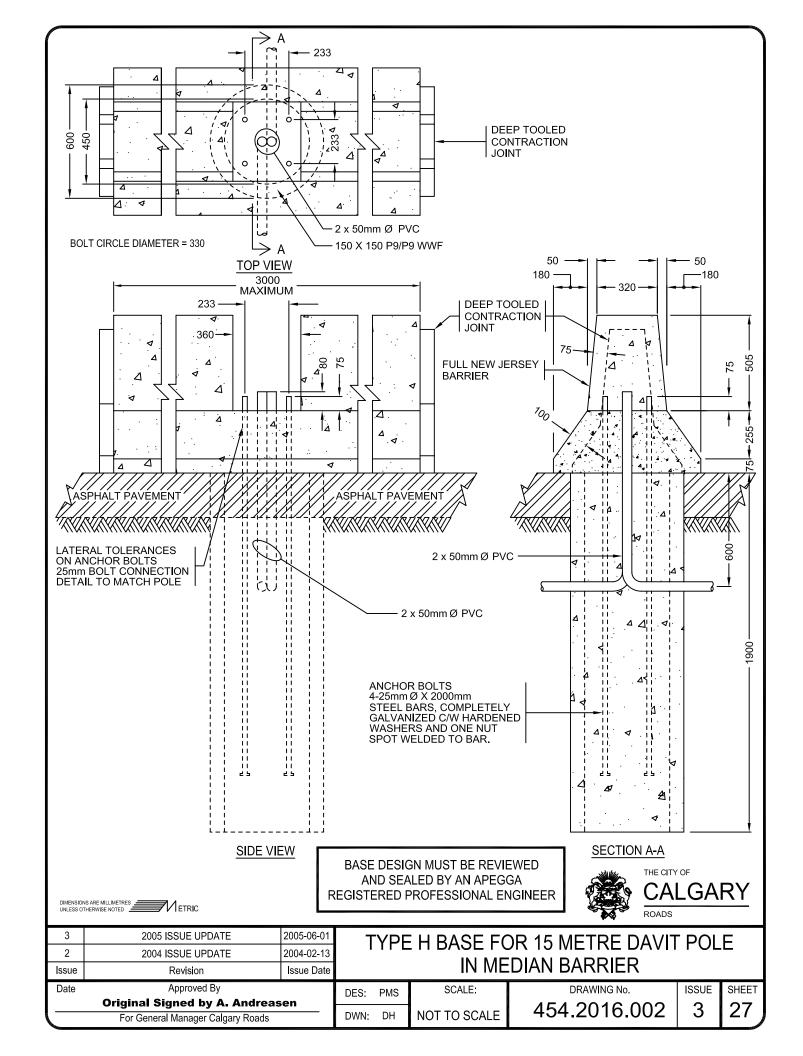


- 1. REFER TO CONTRACT DRAWINGS AND DETAILED SPECIFICATIONS.
- 2. INSTALL LID ON PLASTIC JUNCTION BOX BEFORE BACKFILLING, TAMPING & PAVING OPERATIONS.
- 3. INSTALL TOP OF JUNCTION BOX FLUSH WITH FINISHED GRADE.



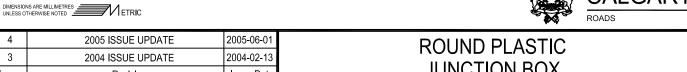

3	2004 ISSUE UPDATE	2004-02-13	ROUND PLASTIC							
Issue	Revision	Issue Date	JUNCTION BOX							
Date	Date Approved By			PMS	SCALE:	DRAWING No.	ISSUE	SHEET		
	Original Signed by A. Andreasen					454.2020.001	1	20		
For General Manager Calgary Roads			DWN:	DH	NOT TO SCALE	454.2020.001	4			

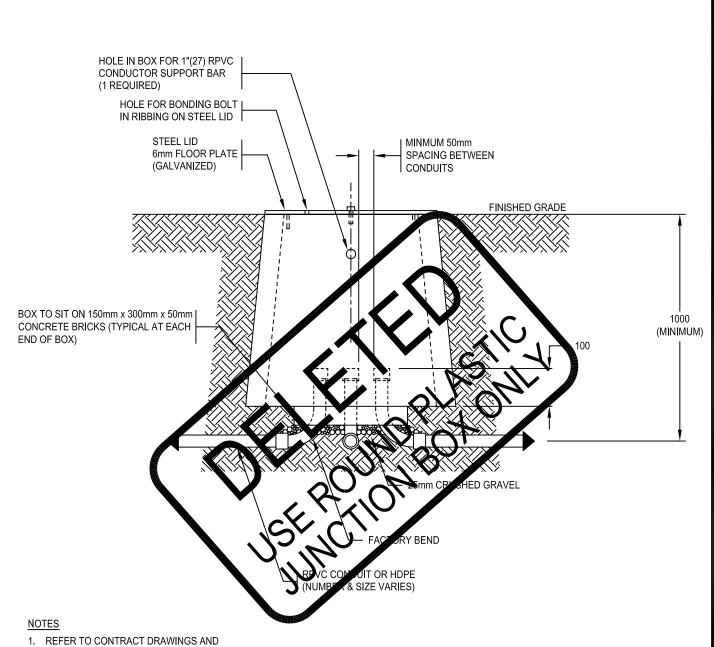

- REFER TO CONTRACT DRAWINGS AND DETAILED SPECIFICATIONS.
- 2. INSTALL LID ON CONCRETE JUNCTION BOX BEFORE BACKFILLING, TAMPING & PAVING OPERATIONS.
- 3. INSTALL TOP OF JUNCTION BOX FLUSH WITH FINISHED GRADE.



4	2005 ISSUE UPDATE	2005-06-01
3	2004 ISSUE UPDATE	2004-02-13
Issue	Revision	Issue Date

DIMENSIONS ARE MILLIMETRES ETRIC


Date


# RECTANGULAR CONCRETE JUNCTION BOX

Approved By  Original Signed by A. Andreasen	DES:	PMS	SCALE:	
For General Manager Calgary Roads	DWN:	DH	NOT TO SCALE	

DRAWING No.						
454.2021.001						

ISSUE	SHEE
4	29

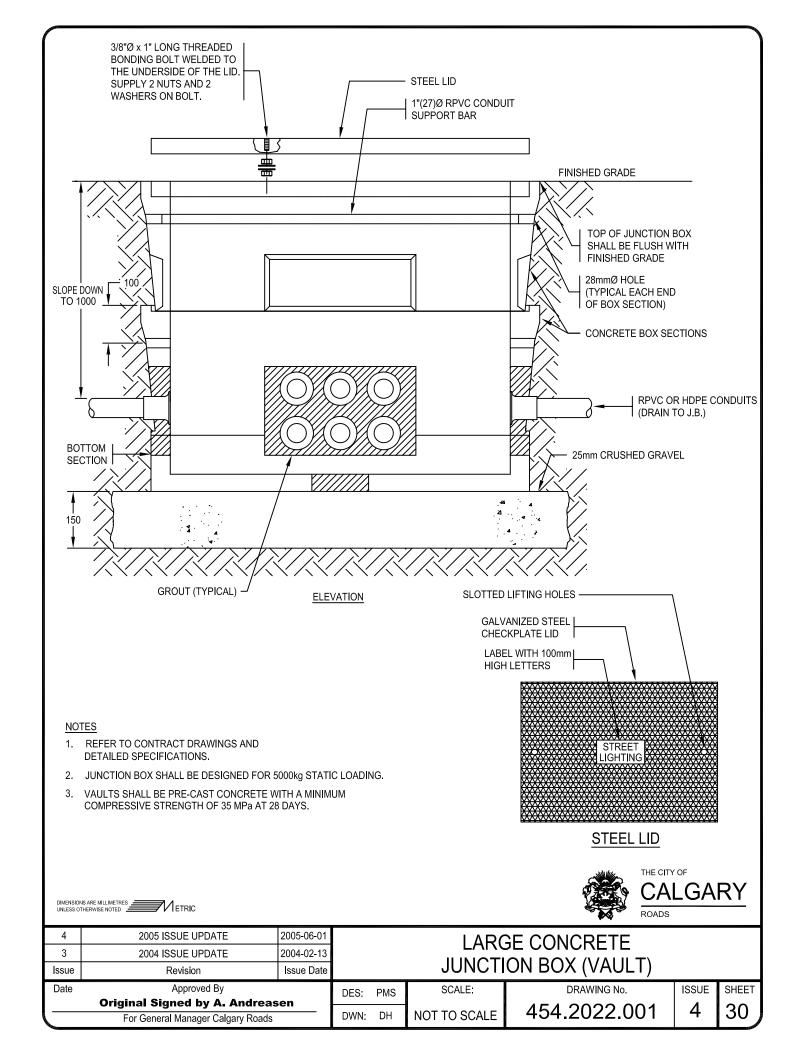

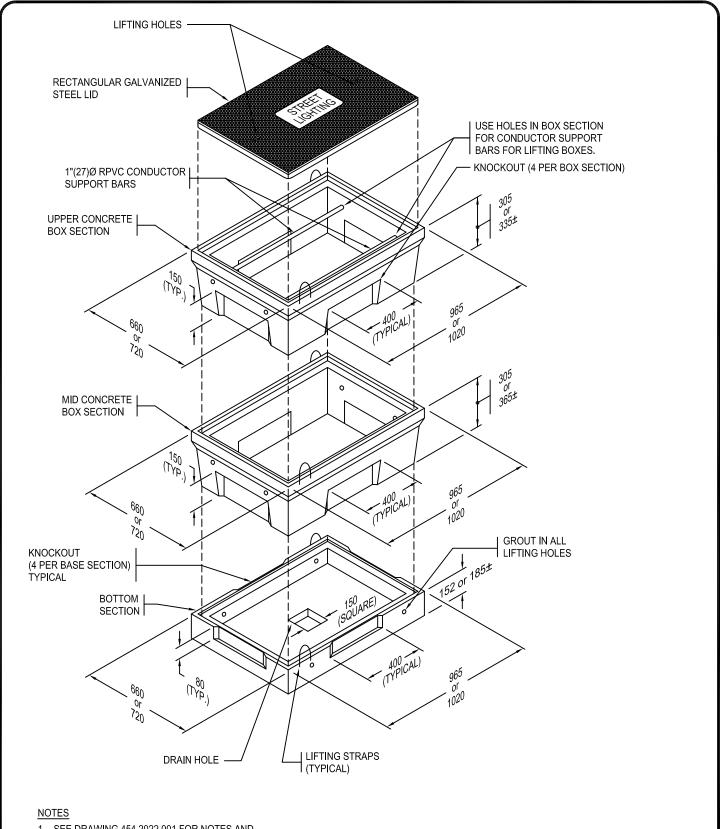



1. SEE DRAWING 454.2022.001 FOR NOTES AND ADDITIONAL DETAILS.





4	2005 ISSUE UPDATE	2005-06-01		LARGE CONCRETE						
3	2004 ISSUE UPDATE	2004-02-13								
Issue	Revision	Issue Date	JUNCTION BOX (VAULT)							
Date	Approved By			PMS	SCALE:	DRAWING No.	ISSUE	SHEET		
	Original Signed by A. Andreasen					454.2022.002	1	24		
	For General Manager Calgary Roads			DH	NOT TO SCALE	434.2022.002	<del>  '+</del>	J   <i> </i>		

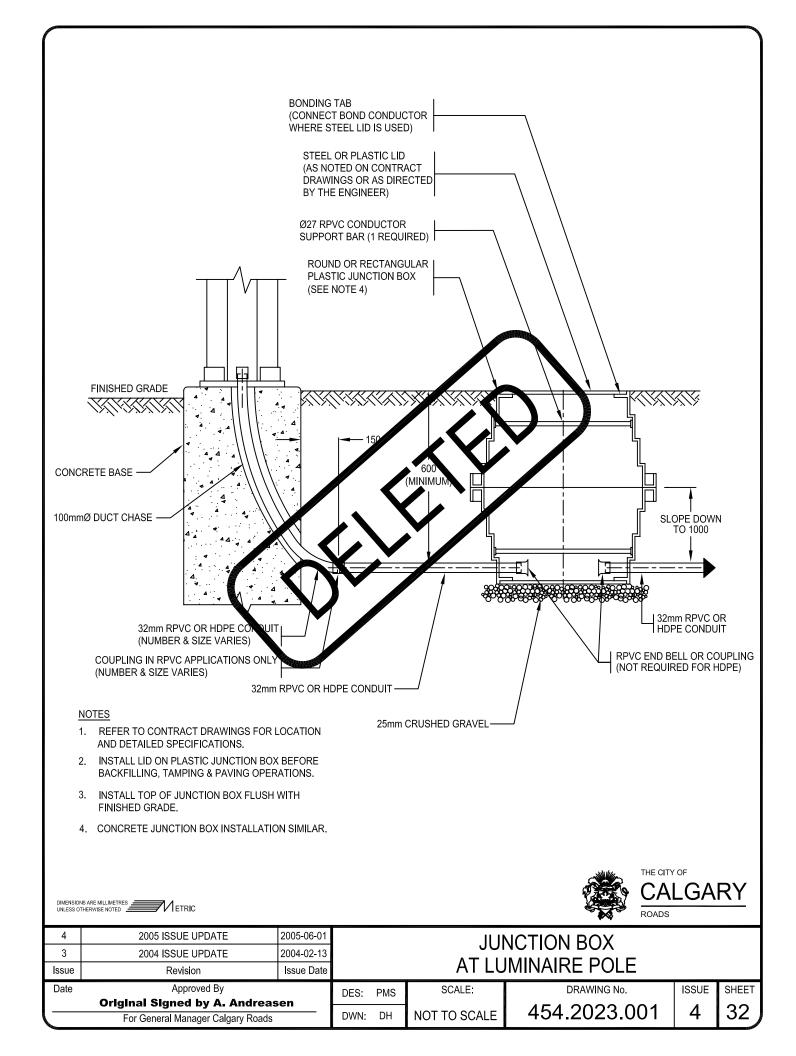

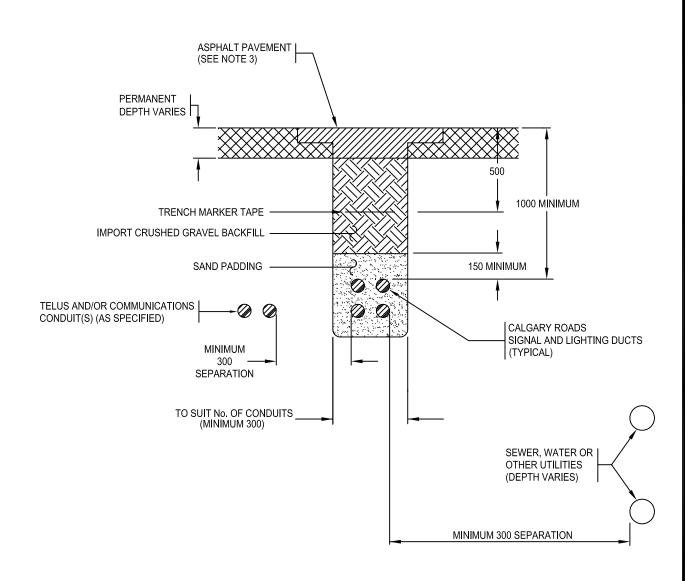

 REFER TO CONTRACT DRAWINGS AND DETAILED SPECIFICATIONS.


DIMENSIONS ARE MILLIMETRES ETRIC UNLESS OTHERWISE NOTED

- 2. PAVEMENT REMOVAL AND REPLACEMENT IN EXISTING PAVED AREAS TO BE IN ACCORDANCE WITH CHAPTER 304.00.00.
- 3. IF REQUIRED COMPACTION IS ACHIEVED, PERMANENT RESTORATION MAY BE UNDERTAKEN IMMEDIATELY.

THIS DRAWING IS <u>NOT</u>
APPLICABLE TO UDI SHALLOW
UTILITIES IN NEW SUBDIVISIONS.



4	4 2005 ISSUE UPDATE 2005-06-01				UNDERGROUND DUCT					
3	2004 ISSUE UPDATE	2004-02-13								
Issue	Revision	Issue Date	IN PAVED AREAS							
Date	Approved By			PMS	SCALE:	DRAWING No.	ISSUE	SHEET		
l	Original Signed by A. Andreasen					454.2025.001	1	22		
	For General Manager Calgary Roads			DH	NOT TO SCALE	404.2020.001	🛨			

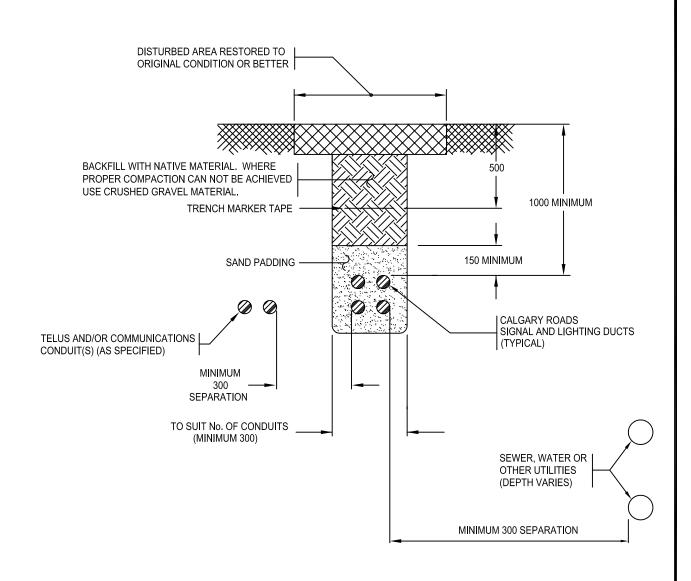


DIMENSIONS ARE MILLIMETRES ETRIC UNLESS OTHERWISE NOTED

1. REFER TO CONTRACT DRAWINGS AND DETAILED SPECIFICATIONS.

THIS DRAWING IS <u>NOT</u>
APPLICABLE TO UDI SHALLOW
UTILITIES IN NEW SUBDIVISIONS.




For General Manager Calgary Roads			DWN:	DH	NOT TO SCALE	454.2025.002	4	34
	Original Signed by A. Andreas	en	DES:	1 1010				
Date	Approved By			PMS	SCALE:	DRAWING No.	ISSUE	SHEET
Issue	Revision	Issue Date	IN NON-PAVED AREAS					
3	2004 ISSUE UPDATE	2004-02-13						
4	2005 ISSUE UPDATE	2005-06-01			UNDERGROUND DUCT			

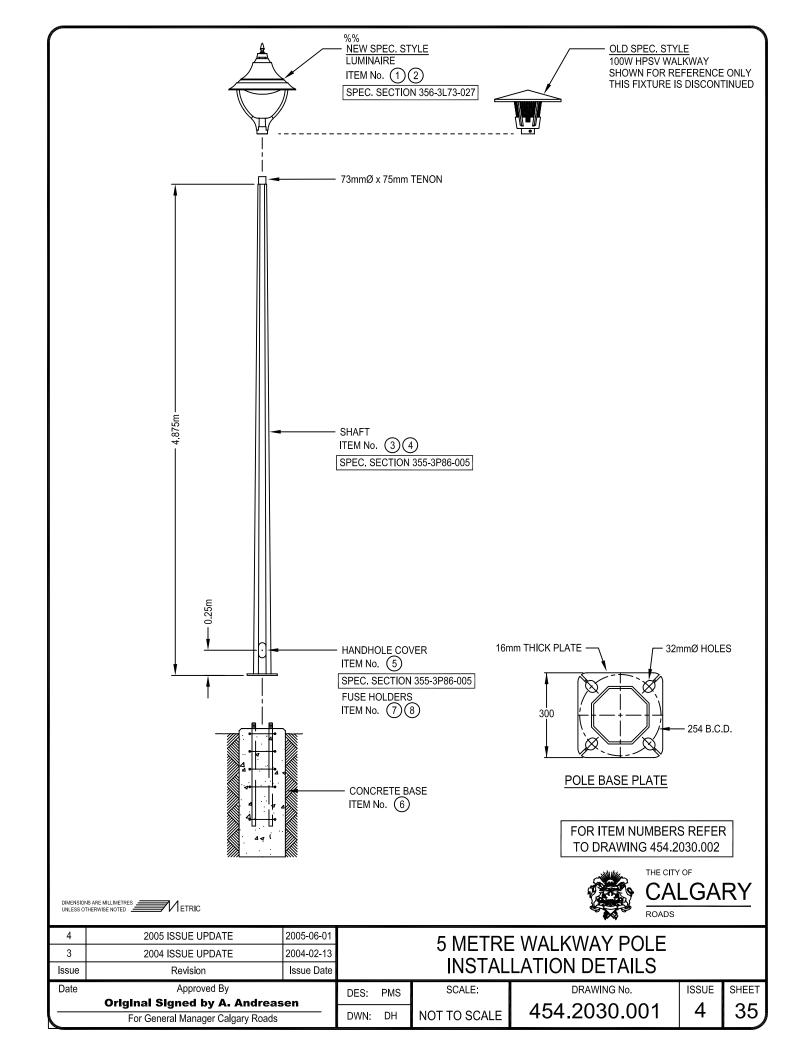


	MATERIAL LIST									
ITEM	QTY	STOCK NUMBER		DESCRIPTION	SUPPLIER					
1	1	158238	LUMINAIRE - HPSV	100W - WALKWAY (NEW SPEC. STYLE)	ROADS					
2	1	143988	LAMP - HPSV	100W - CLEAR	ROADS					
3	1	151239	POLE - PAINTED	5m - WALKWAY - BLACK	ROADS					
4	1	151311	POLE - FIBERGLASS	5m - WALKWAY - BLACK	ROADS					
5	1	N/A	COVER - HANDHOLE	(SUPPLIED W/POLE)	ROADS					
6	1	N/A	CONCRETE BASE	(SEE NOTE 6)	CONTRACTOR					
7	2	154245	FUSE HOLDER 600V	30A - INLINE	ROADS					
8	2	154247	FUSE 10A 250V	TYPE BAF - 10A	ROADS					
9										
10										
11										
12										
13										

- 1. NO MORE THAN 2 SHIMS SHALL BE USED ON ANY ANCHOR BOLT.
- 2. THE ANCHOR NUTS SHALL BE TIGHTENED AS PER SPEC. 352.01.02.
- 3. PRE-CAST BASE IS SUPPLIED C/W ANCHOR NUTS AND WASHERS.
- 4. POLE MAY BE SUPPLIED BY CALGARY ROADS AS EITHER PAINTED STEEL OR PAINTED FIBERGLASS.
- 5. "OLD SPEC. STYLE" FIXTURES ARE NO LONGER AVAILABLE.
- 6. CONTRACTOR SHALL SUPPLY THE BASE, ETHER PRE-CAST OR POURED IN PLACE. THE 5m WALKWAY POLE BASE CONSTRUCTION DETAILS SHALL BE THE SAME AS THE CITY STANDARD TYPE 'B1' OR 'B2' BASE, BUT WITH THE B.C.D. AS REQUIRED.



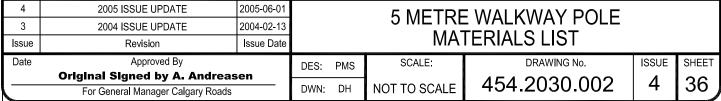

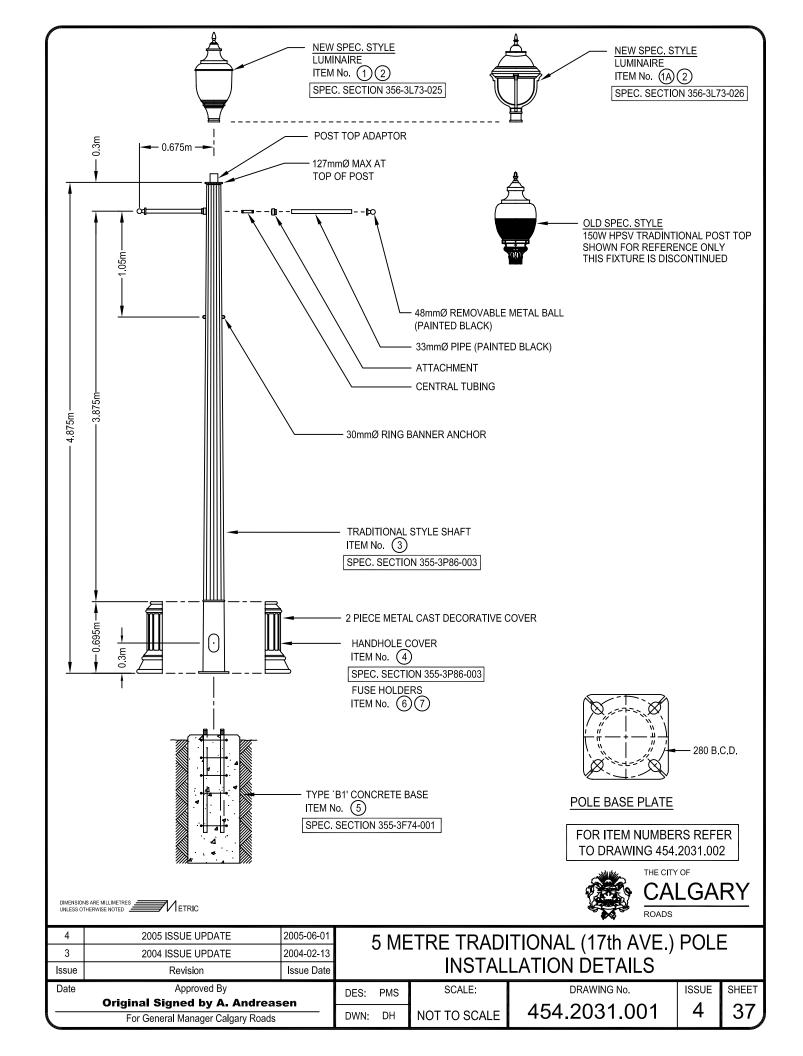


	MATERIAL LIST										
ITEM	QTY	STOCK NUMBER		DESCRIPTION	SUPPLIER						
1	1	158236	LUMINAIRE - HPSV	100W - TRADITIONAL POST TOP STYLE (TYPE 2)	ROADS						
1A	1	158237	LUMINAIRE - HPSV	100W - LANTERN POST TOP STYLE (TYPE 3)	ROADS						
2	1	143988	LAMP - HPSV	100W - CLEAR	ROADS						
3	1	151252	POLE - PAINTED	5m - TRADITIONAL STYLE - BLACK	ROADS						
4	1	N/A	COVER - HANDHOLE	(SUPPLIED W/DECORATIVE POLE BASE COVER)	ROADS						
5	1	139578	TYPE `B1' BASE - ROUN	TYPE `B1' BASE - ROUND CONCRETE PRECAST							
6	2	154245	FUSE HOLDER 600V	30A - INLINE	ROADS						
7	2	154247	FUSE 10A 250V	TYPE BAF - 10A	ROADS						
8											
9											
10											
11											

- 1. NO MORE THAN 2 SHIMS SHALL BE USED ON ANY ANCHOR BOLT.
- 2. THE ANCHOR NUTS SHALL BE TIGHTENED AS PER SPEC. 352.01.02.
- 3. PRE-CAST BASE IS SUPPLIED C/W ANCHOR NUTS AND WASHERS.
- 4. POLE IS SUPPLIED C/W BASE COVER, BANNER ARMS AND BANNER ARM ANCHORS.
- 5. "OLD SPEC. STYLE" FIXTURES ARE NO LONGER AVAILABLE.



4	2005 ISSUE UPDATE	2005-06-01		5 METRE TRADITIONAL (17th AVE.) POLE						
3	2004 ISSUE UPDATE	2004-02-13	<b>\</b>					_		
Issue	Revision	Issue Date	MATERIALS LIST							
Date	Pate Approved By			PMS	SCALE:	DRAWING No.	ISSUE	SHEET		
	Original Signed by A. Andreasen					454.2031.002	1 1	38		
	For General Manager Calgary Roads			DH	NOT TO SCALE	404.2031.002	+			

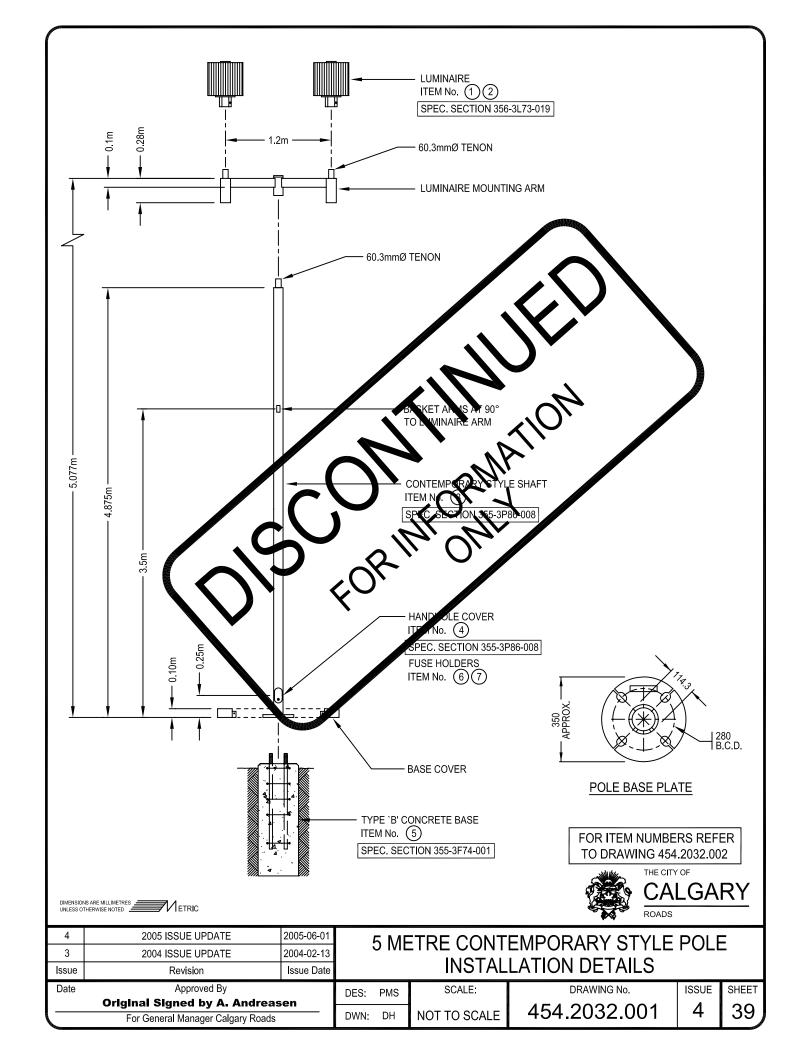


			MATERIA	AL LIST	
ITEM	QTY	STOCK NUMBER		DESCRIPTION	SUPPLIER
1	2	143047	LUMINAIRE - HPSV	100W - CONTEMPORARY POST TOP	ROADS
2	2	143988	LAMP - HPSV	100W - CLEAR	ROADS
3	1	151258	POLE - PAINTED	5m - CONTEMPORARY - BLACK	ROADS
4	1	N/A	COVER - HANDHOLE	(SUPPLIED W/POLE)	ROADS
5	1	139575	TYPE `B' BASE - CONC	RETE PRECAST	ROADS
6	2	154245	FUSE HOLDER 600V	30A LINE	ROADS
7	2	154247	FUSE 10A 250V	YPE BAF - 10x	ROADS
8					
9					
10					
11			1		

- 1. NO MORE THAN 2 SHIMS SHALL
- 2. THE ANCHOR NUTS SHAL
- 3. PRE-CAST BASE IS SU LIED C/W
- 4. POLE IS SUPPLIED ATTACHMENTS W BASE CO NALS AND LU





7	2003 1330E OFDATE	2003-00-01	4 5 METRE CONTEMPORARY STYLE POLE							
3	2004 ISSUE UPDATE	2004-02-13								
Issue	Revision	Issue Date			IVIA	TERIALS LIST				
Date	Pate Approved By			PMS	SCALE:	DRAWING No.	ISSUE	SHEET		
	Original Signed by A. Andreasen					454 2032 002	1	40		
For General Manager Calgary Roads			DWN:	DH	NOT TO SCALE	434.2032.002	<del>  '+</del>	<del>4</del> 0		

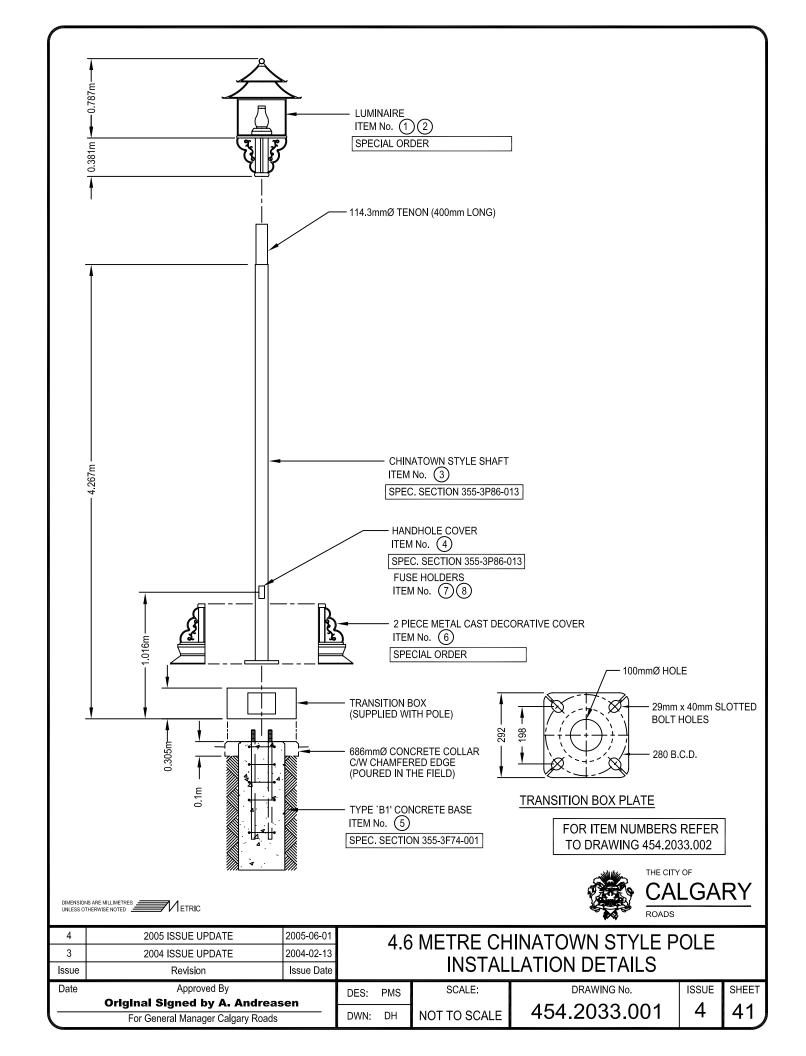


			MATERIAL LIS	ST	
ITEM	QTY	STOCK NUMBER	DES	CRIPTION	SUPPLIER
1	1	143034	LUMINAIRE - MH	250W - CHINATOWN	ROADS
2	1	143984	LAMP - MH	250W - CLEAR	ROADS
3	1	151809	POLE - PAINTED	4.6m - CHINATOWN - RED	ROADS
4	1	N/A	COVER - HANDHOLE	(SUPPLIED W/POLE)	ROADS
5	1	139578	TYPE `B1' BASE - CONCF	ROADS	
6	1	N/A	METAL CAST DECORATI	VE COVER (SPECIAL ORDER)	ROADS
7	2	154245	FUSE HOLDER 600V	30A - INLINE	ROADS
8	2	154247	FUSE 10A 250V	TYPE BAF - 10A	ROADS
9					
10					
11					

- 1. NO MORE THAN 2 SHIMS SHALL BE USED ON ANY ANCHOR BOLT.
- 2. THE ANCHOR NUTS SHALL BE TIGHTENED AS PER SPEC. 352.01.02.
- 3. PRE-CAST BASE IS SUPPLIED C/W ANCHOR NUTS AND WASHERS.
- 4. POLE IS SUPPLIED C/W BASE COVER.




4	2005 ISSUE UPDATE	2005-06-01		4.6 METRE CHINATOWN STYLE POLE							
3	2004 ISSUE UPDATE	2004-02-13									
Issue	Revision	Issue Date	MATERIALS LIST								
Date	e Approved By			PMS	SCALE:	DRAWING No.	ISSUE	SHEET			
	Original Signed by A. Andreas	sen	DWN:			454.2033.002	1	1/2			
	For General Manager Calgary Roads			DH	NOT TO SCALE	404.2033.002	+	L <sup>42</sup>			

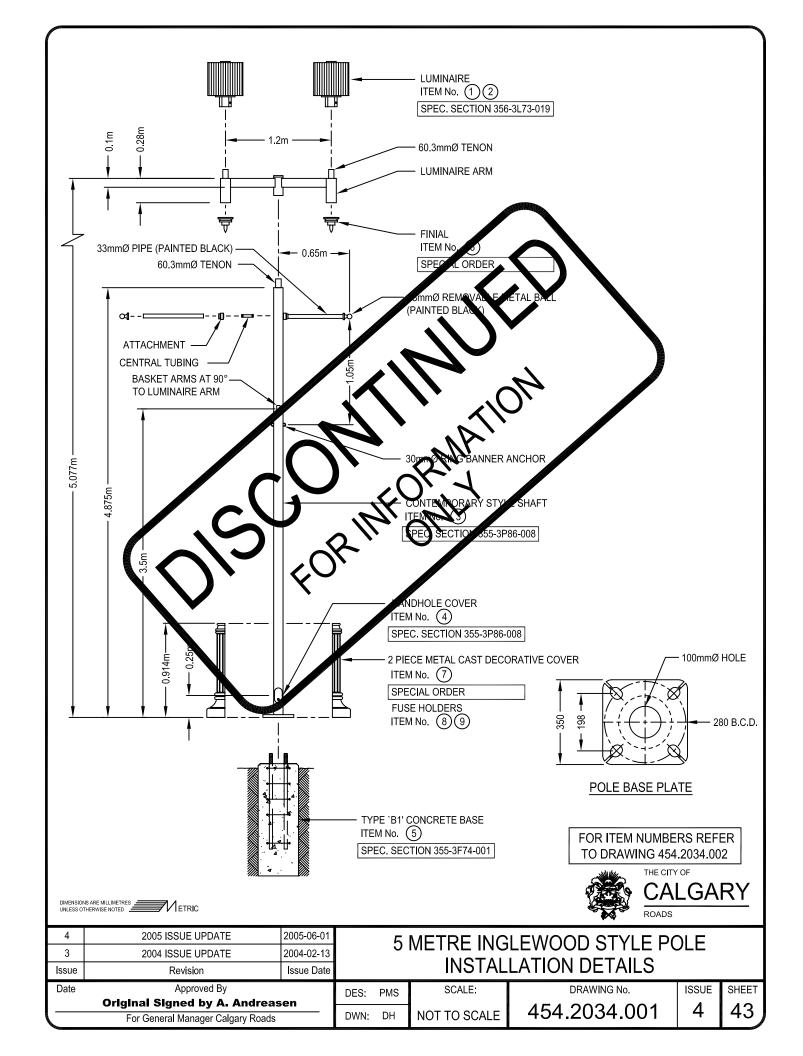


1 2 2 2 3 1 4 1	143047 143988 151258	LUMINAIRE - HPSV  LAMP - HPSV  POLE - PAINTED	DESCRIPTION  100W - CONTEMPORARY POST TOP  100W - CLEAR	SUPPLIER ROADS ROADS
2 2 3 1	143988	LAMP - HPSV		
3 1			100W - CLEAR	ROADS
	151258	DOLE DAINTED		
4 1		FOLE - PAINTED	5m - CONTEMPORARY- BLACK	ROADS
	N/A	COVER - HANDHOLE	(SUPPLIED W/ DECORATIVE POLE BASE COVER)	ROADS
5 1	139578	TYPE `B1' BASE - CON	CRETE PRECAST	ROADS
6 2	N/A	FINIAL	(SUPPLIED W/POLE)	ROADS
7 1	N/A	METAL CAST DECORA	TIVE COVER	ROADS
8 2	154245	FUSE HOLDER 600V	30A - PEINE	ROADS
9 2	154247	FUSE 10A 250V	PE BAF - 10A	QADS
10				
11				
THE ANCHOR NUTS	S SHALL BE TIGHTED S SUPPLIED C/W ACC C/W BASE CAFER. B	HOR NUTS AND WASHER	T. 02. ARM	

- 1. NO MORE THAN 2 SHIMS SHALL BE USED
- 2. THE ANCHOR NUTS SHALL BE TIGHTED
- 3. PRE-CAST BASE IS SUPPLIED C/W CHOR NU
- 4. POLE IS SUPPLIED C/W BASE C ATTACHMENTS, FINIALS AND ER, BASKE UMINAIRE MOU

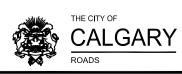

4	2005 ISSUE UPDATE	2005-06-01	5 METRE INGLEWOOD STYLE POLE						
3	2004 ISSUE UPDATE	2004-02-13		J					
Issue	Revision	Issue Date	MATERIALS LIST						
Date	e Approved By			PMS	SCALE:	DRAWING No.	ISSUE	SHEET	
	Original Signed by A. Andreasen			DH		454.2034.002	1	1 11	
	For General Manager Calgary Roads				NOT TO SCALE	434.2034.002	4	ر ۲۲	

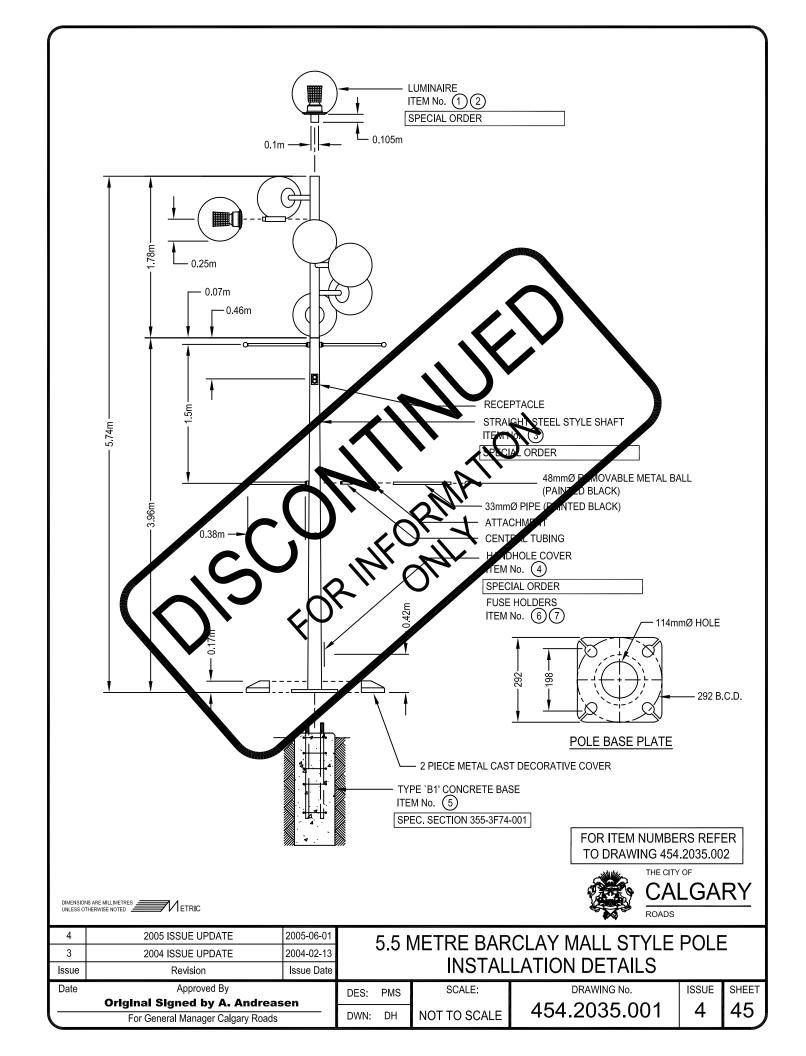

			MATERIA	L LIST					
ITEM	QTY	STOCK NUMBER		DESCRIPTION	SUPPLIER				
1	7	143054	LUMINAIRE - HPSV	150W GLOBE	ROADS				
2	7	143989	LAMP - HPSV	150W CLEAR	ROADS				
3	1	N/A	POLE - PAINTED	5.5m - STRAIGHT STEEL	ROADS				
4	1	N/A	COVER - HANDHOLE	(SUPPLIED W/POLE)	ROADS				
5	1	139578	TYPE `B1' BASE - CONCE	TYPE `B1' BASE - CONCRETE PREC 181					
6	2	154245	FUSE HOLDER 600V	3 X - INLINE	ROADS				
7	2	154247	FUSE 10A 250V	TYPE BA - 10A	ROADS				
8									
9									
10									
11				1,					

- 1. NO MORE THAN 2 SHIMS
- 2. THE ANCHOR NUTS S L BE TIGHTEN
- 3. PRE-CAST BASE IS OPPLIED C
- ANCHUR BOLT.

  GHIENE AS A FERSPEC. 352.01.02


  ANCHOR UTS AND WASHER

  VER, BAIN IERVARMS, BANNER

  MOUNTING ARMS. 4. POLE IS SUPPLARM ATTAC C/W BASE C



4	2005 ISSUE UPDATE	2005-06-01		5.5 METRE BARCLAY MALL STYLE POLE						
3	2004 ISSUE UPDATE	2004-02-13		J.J 1		3 L, (				
Issue	Revision	Issue Date	MATERIALS LIST							
Date	Approved By			PMS	SCALE:	DRAWING No.	ISSUE	SHEET		
	Original Signed by A. Andreasen			DH		454.2035.002	1	16		
	For General Manager Calgary Roads				NOT TO SCALE	434.2033.002	<del>'1</del>	40)		

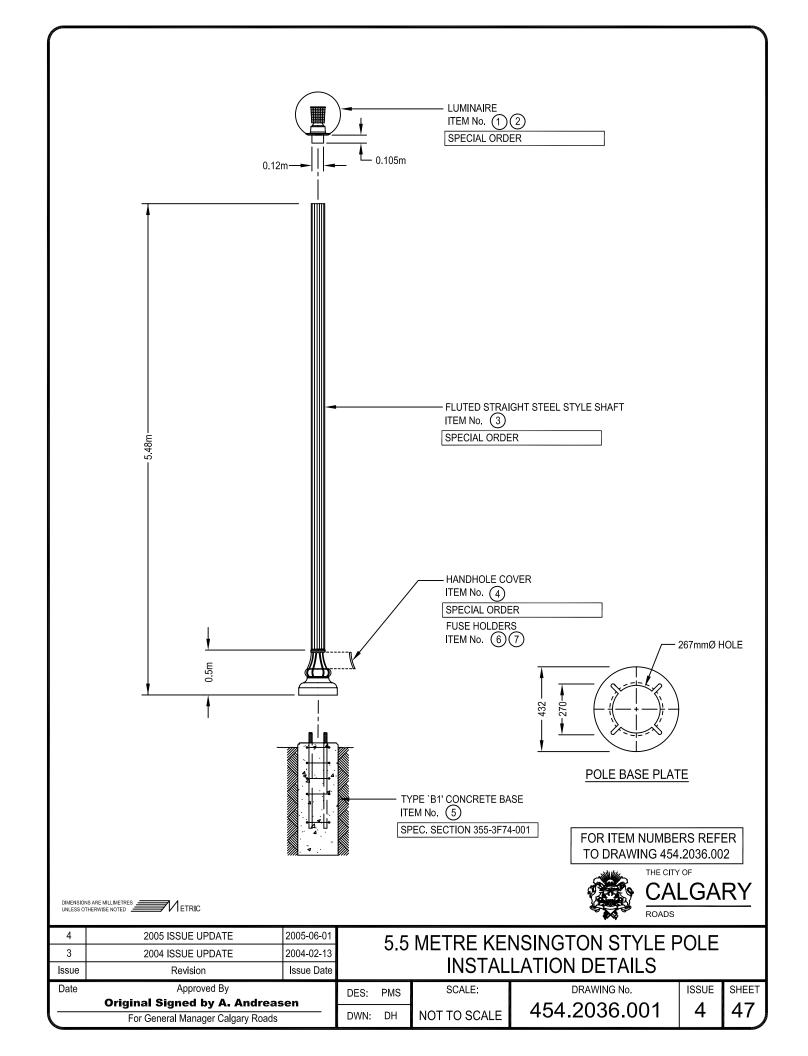


			MATERIAL LIST	
ITEM	QTY	STOCK NUMBER	DESCRIPTION	SUPPLIER
1	1	143054	LUMINAIRE - HPSV 150W GLOBE	ROADS
2	1	143989	LAMP - HPSV 150W CLEAR	ROADS
3	1	N/A	POLE - PAINTED	ROADS
4	1	N/A	COVER - HANDHOLE (SUPPLIED W/POLE)	ROADS
5	1	139578	TYPE `B1' BASE - ROUND CONCRETE PRECAST	ROADS
6	2	154245	FUSE HOLDER 600V 30A - INLINE	ROADS
7	2	154247	FUSE 10A 250V TYPE BAF - 10A	ROADS
8				
9				
10				
11				

- 1. NO MORE THAN 2 SHIMS SHALL BE USED ON ANY ANCHOR BOLT.
- 2. THE ANCHOR NUTS SHALL BE TIGHTENED AS PER SPEC. 352.01.02.
- 3. PRE-CAST BASE IS SUPPLIED C/W ANCHOR NUTS AND WASHERS.



4	2005 ISSUE UPDATE	2005-06-01		5.5 METRE KENSINGTON STYLE POLE					
3	2004 ISSUE UPDATE	2004-02-13	*.*						
Issue	Revision	Issue Date	MATERIALS LIST						
Date	Approved By			PMS	SCALE:	DRAWING No.	ISSUE	SHEET	
	Original Signed by A. Andreas	sen				454.2036.002	1	10	
	For General Manager Calgary Roads			DH	NOT TO SCALE	434.2030.002	<del>  '1</del>	L <sup>40</sup>	

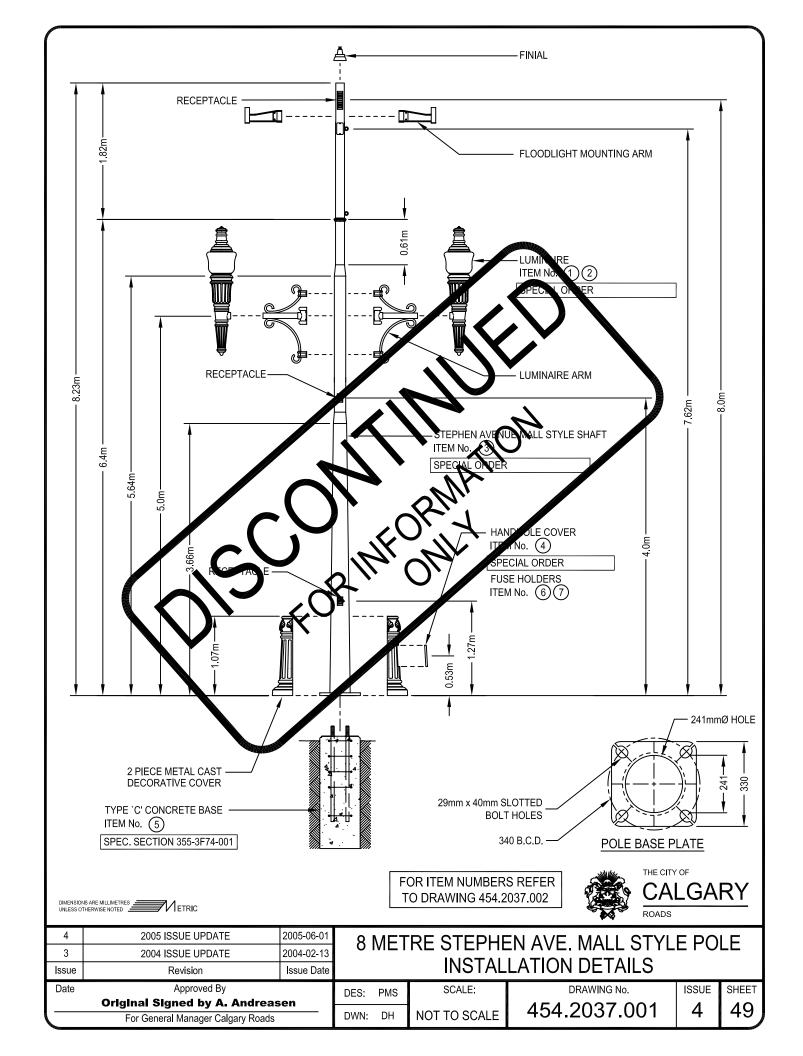


	MATERIAL LIST											
ITEM	QTY	STOCK NUMBER		DESCRIPTION	SUPPLIER							
1	2	N/A	LUMINAIRE - MH	250W CUSTOM	ROADS							
2	2	143984	LAMP - MPSV MH	250W CLEAR	ROADS							
3	1	N/A	POLE - PAINTED	8m - STEPHEN AVE. MALL STYLE	ROADS							
4	1	N/A	COVER - HANDHOLE	(SUPPLIED W/POLE PASE DEC RATIVE COVER)	ROADS							
5	1	139576	TYPE `C' - CONCRETE P	ROADS								
6	2	154245	FUSE HOLDER 600V	30A - INUTE	ROADS							
7	2	154247	FUSE 10A 250V	TYPE BAF - 10A	ROADS							
8												
9												
10												
11												

- 1. NO MORE THAN 2 SHIMS SHALL BE USED ON ANY WOR TOLT.
- 2. THE ANCHOR NUTS SHALL BE GHTENED 31. 8 St. FC. 352. 1.02.
- 3. PRE-CAST BASE IS SUPPLY C/W ANCHOR NUTS A ID MASHERS



4	2005 ISSUE UPDATE	2005-06-01	Ω	8 METRE STEPHEN AVE. MALL STYLE POLE						
3	2004 ISSUE UPDATE	2004-02-13	0	IVIL I	•					
Issue	Revision	Issue Date	MATERIALS LIST							
Date	e Approved By			PMS	SCALE:	DRAWING No.	ISSUE	SHEET		
	Original Signed by A. Andreasen			DH		454 2037 002	1	50		
	For General Manager Calgary Roads				NOT TO SCALE	404.2037.002	+	ر ال		

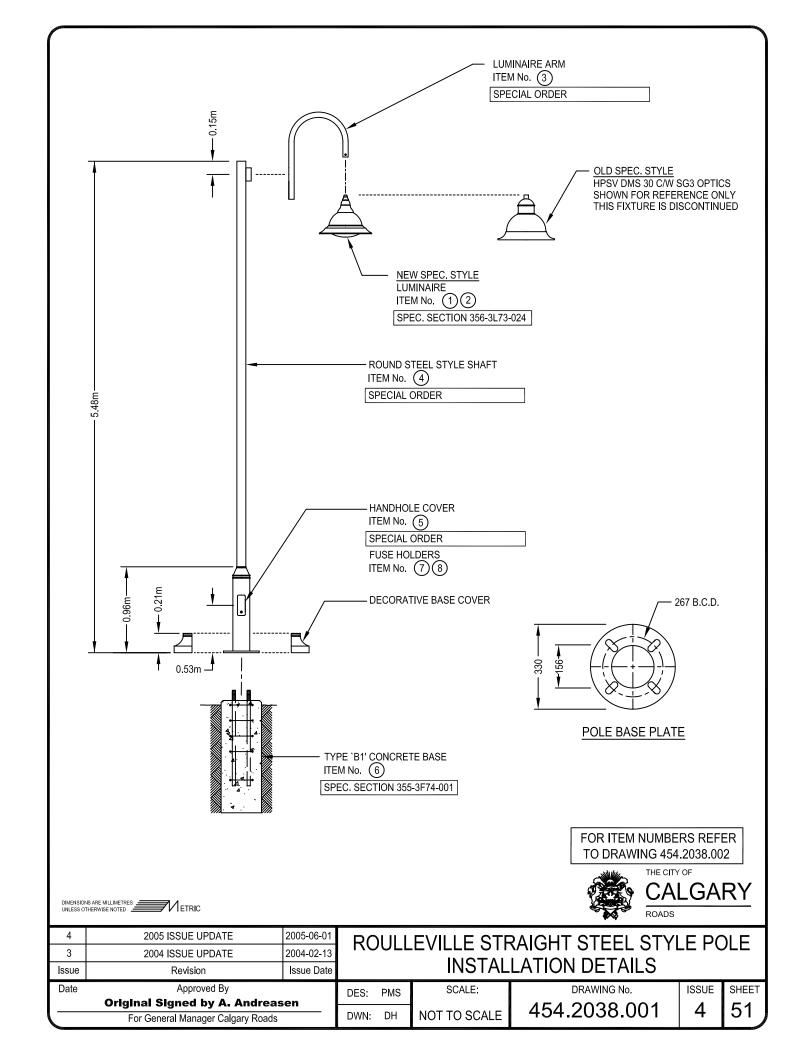



MATERIAL LIST							
ITEM	QTY	STOCK NUMBER		DESCRIPTION			
1	1	159355	LUMINAIRE - HPSV	100W - DOMUS CONCEPT STYLE (TYPE 1)	ROADS		
2	1	143988	LAMP - HPSV	100W CLEAR	ROADS		
3	1	N/A	LUMINAIRE ARM	IF MOUNTING	ROADS		
4	1	N/A	POLE - PAINTED	5.5m - STRAIGHT STEEL STYLE	ROADS		
5	1	N/A	COVER - HANDHOLE	(SUPPLIED W/POLE)	ROADS		
6	1	139578	TYPE `B1' BASE - CONC	RETE PRECAST	ROADS		
7	2	154245	FUSE HOLDER 600V	30A - INLINE	ROADS		
8	2	154247	FUSE 10A 250V	TYPE BAF - 10A	ROADS		
9							
10							
11							

DIMENSIONS ARE MILLIMETRES ETRIC
UNLESS OTHERWISE NOTED

- 1. NO MORE THAN 2 SHIMS SHALL BE USED ON ANY ANCHOR BOLT.
- 2. THE ANCHOR NUTS SHALL BE TIGHTENED AS PER SPEC. 352.01.02.
- 3. PRE-CAST BASE IS SUPPLIED C/W ANCHOR NUTS AND WASHERS.
- 4. POLE IS SUPPLIED C/W BASE COVER.
- 5. "OLD SPEC. STYLE" FIXTURES ARE NO LONGER AVAILABLE.




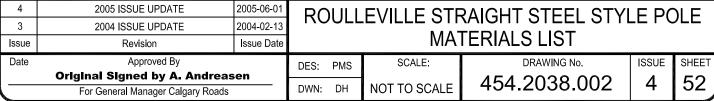

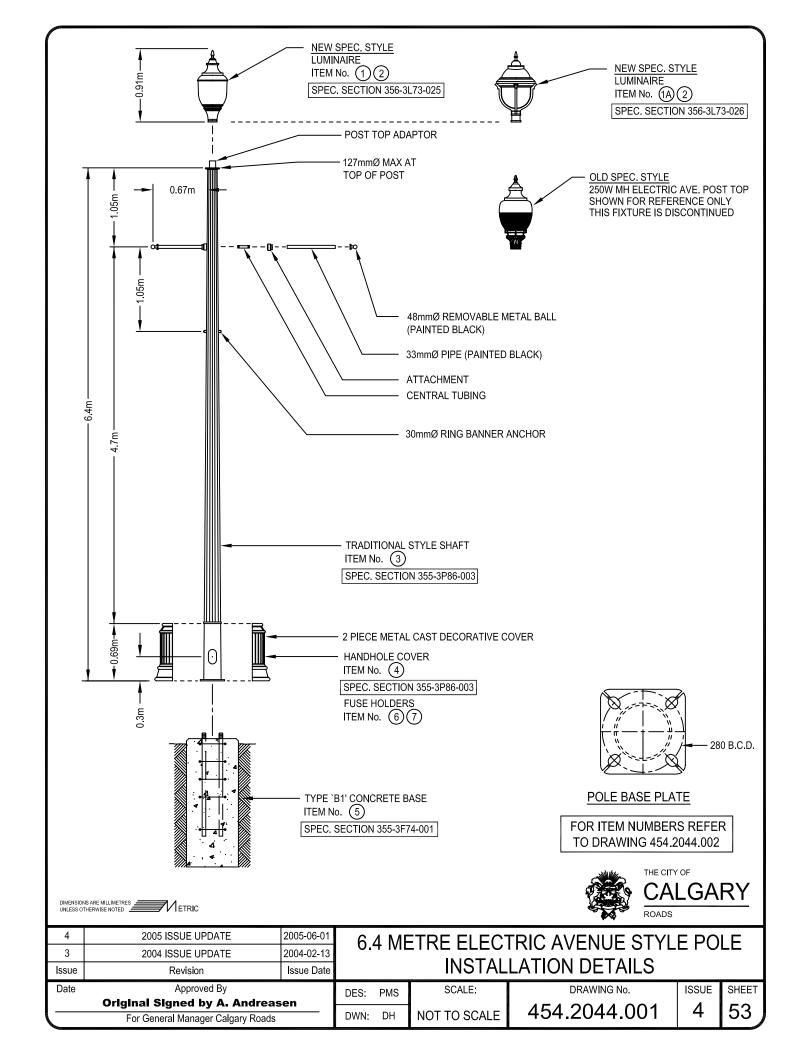


MATERIAL LIST							
ITEM	QTY	STOCK NUMBER		DESCRIPTION			
1	1	158236	LUMINAIRE - HPS	100W - TRADITIONAL POST TOP (TYPE 2)	ROADS		
1A	1	158237	LUMINAIRE - HPS	100W - LANTERN POST TOP (TYPE 3)	ROADS		
2	1	143988	LAMP - HPS	100W - CLEAR	ROADS		
3	1	151285	POLE - PAINTED	6.4m - TRADITIONAL - BLACK	ROADS		
4	1	N/A	COVER - HANDHOLE	(SUPPLIED W/DECORATIVE POLE BASE COVER)	ROADS		
5	1	139578	TYPE 'B1' BASE - CONCI	TYPE `B1' BASE - CONCRETE PRECAST			
6	2	154245	FUSE HOLDER 600V	30A - INLINE	ROADS		
7	2	154247	FUSE 10A 250V	TYPE BAF - 10A	ROADS		
8							
9							
10							
11							

- 1. NO MORE THAN 2 SHIMS SHALL BE USED ON ANY ANCHOR BOLT.
- 2. THE ANCHOR NUTS SHALL BE TIGHTENED AS PER SPEC. 352.01.02.
- 3. PRE-CAST BASE IS SUPPLIED C/W ANCHOR NUTS AND WASHERS.
- 4. POLE IS SUPPLIED C/W BASE COVER, BANNER ARMS, BANNER ARM ATTACHMENTS.
- 5. "OLD SPEC.STYLE" FIXTURES ARE NO LONGER AVAILABLE.

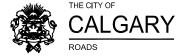



4	2005 ISSUE UPDATE	2005-06-01	6.4 METRE ELECTRIC AVENUE STYLE POLE						
3	2004 ISSUE UPDATE	2004-02-13	0.						
Issue	Revision	Issue Date		MATERIALS LIST					
Date	Approved By		DES:	PMS	SCALE:	DRAWING No.	ISSUE	SHEET	
Original Signed by A. Andreasen					4	454 2044 002	1 1	E /	
	For General Manager Calgary Roads				NOT TO SCALE	454.2044.002	<del>'1</del>	54	

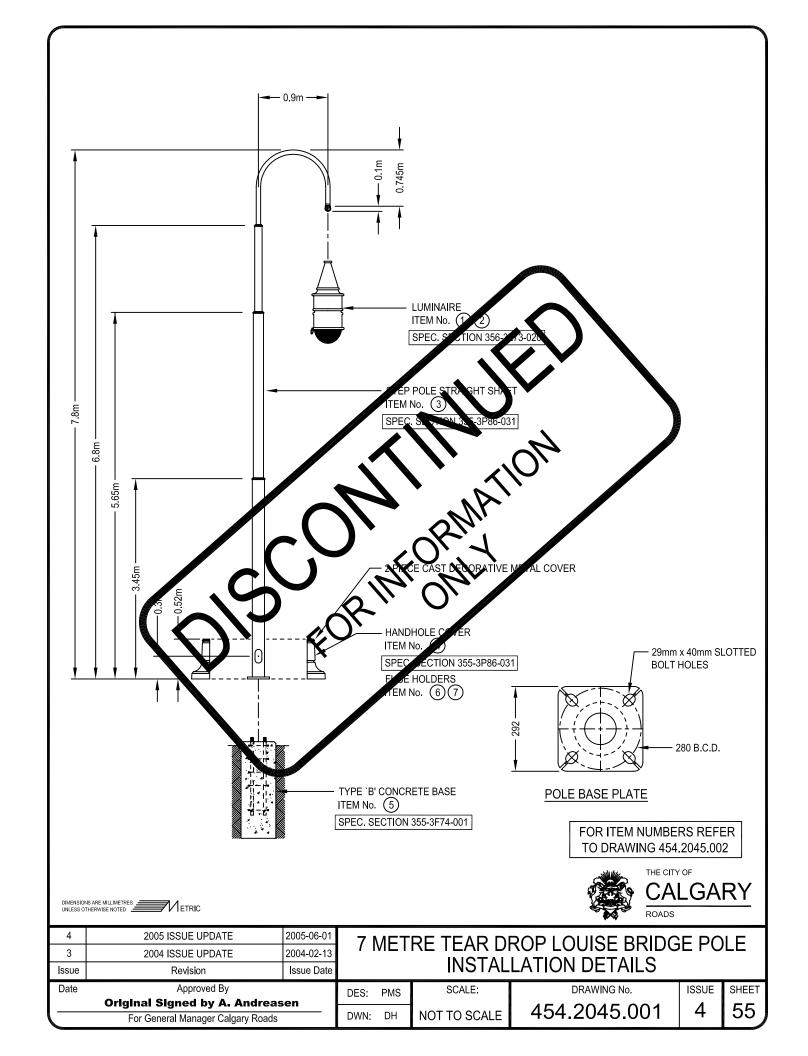


	MATERIAL LIST						
ITEM	QTY	STOCK NUMBER	DES	DESCRIPTION			
1	1	143051	LUMINAIRE - HPSV	150W - LOUISE TEAR DROP	ROADS		
2	1	143989	LAMP - HPSV	150W - CLEAR	ROADS		
3	1	151303	POLE - PAINTED	7m - LOUISE - BLACK	ROADS		
4	1	N/A	COVER - HANDHOLE	(SUPPLIED W/DECORATIVE POLE BASE COVER)	ROADS		
5	1	139575	TYPE 'B' BASE - CONCR	TYPE 'B' BASE - CONCRETE PRECAST			
6	2	154245	FUSE HOLDER 600V	30A - INLINE	ROADS		
7	2	154247	FUSE 10A 250V	TYPE BAF 10A	ROADS		
8							
9							
10							
11							

- 1. NO MORE THAN 2 SHIMS SHALL BE USED IN ANY BOLT
- 2. THE ANCHOR NUTS SHALL BE TORQUED TO 350 FOOL YOUNDS
- 3. PRE-CAST BASE IS SUPPLIED C/W/NCHOR NUMBERS
- 4. POLE IS SUPPLIED C/W BASE OVER



4	2005 ISSUE UPDATE	2005-06-01	7 METRE TEAR DROP LOUISE BRIDGE POLE						
3	2004 ISSUE UPDATE	2004-02-13	' '	VIL I					
Issue	Revision	Issue Date	MATERIALS LIST						
Date	Approved By		DES:	PMS	SCALE:	DRAWING No.	ISSUE	SHEET	
Original Signed by A. Andreasen				DH		454.2045.002	1	56	
	For General Manager Calgary Roads				NOT TO SCALE	434.2043.002	4		

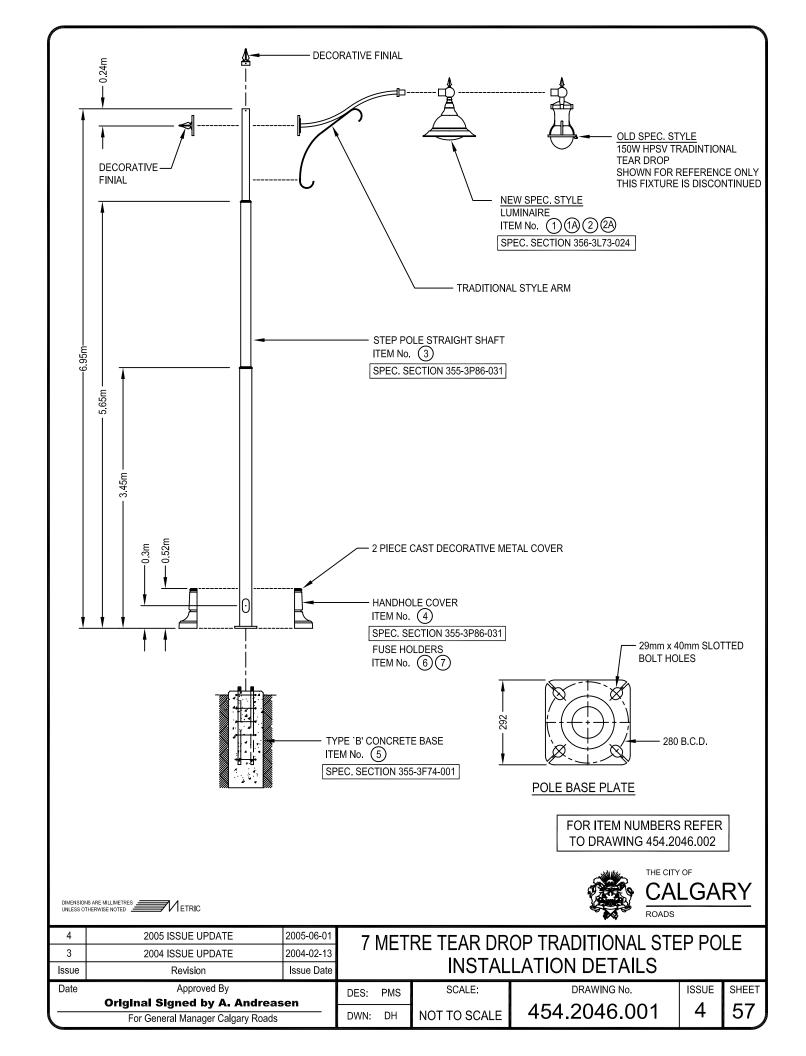



MATERIAL LIST									
ITEM	QTY	STOCK NUMBER		DESCRIPTION					
1	1	159355	LUMINAIRE - HPSV	100W - DOMUS CONCEPT STYLE (TYPE 1)	ROADS				
1A	1	143988	LAMP - HPSV	100W CLEAR	ROADS				
2	1	159826	LUMINAIRE - HPSV	150W - DOMUS CONCEPT STYLE (TYPE 1)	ROADS				
2A	1	143989	LAMP - HPSV	150W CLEAR	ROADS				
3	1	151304	POLE - PAINTED	7m - STEP POLE-STRAIGHT STYLE - BLACK	ROADS				
4	1	N/A	COVER - HANDHOLE	(SUPPLIED W/DECORATIVE POLE BASE COVER)	ROADS				
5	1	139575	TYPE `B' BASE - CONCRI	ETE PRECAST	ROADS				
6	2	154245	FUSE HOLDER 600V	30A - INLINE	ROADS				
7	2	154247	FUSE 10A 250V	TYPE BAF - 10A	ROADS				
8									
9									

DIMENSIONS ARE MILLIMETRES ETRIC
UNLESS OTHERWISE NOTED

- 1. NO MORE THAN 2 SHIMS SHALL BE USED ON ANY BOLT.
- 2. THE ANCHOR NUTS SHALL BE TORQUED TO 350 FOOT POUNDS.
- 3. PRE-CAST BASE IS SUPPLIED C/W ANCHOR NUTS AND WASHERS.
- 4. POLE IS SUPPLIED C/W LUMINAIRE MOUNTING ARM , FINIALS AND BASE COVER.
- 5. "OLD SPEC. STYLE" FIXTURES ARE NO LONGER AVAILABLE.



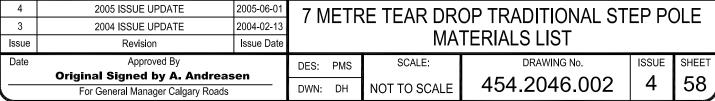

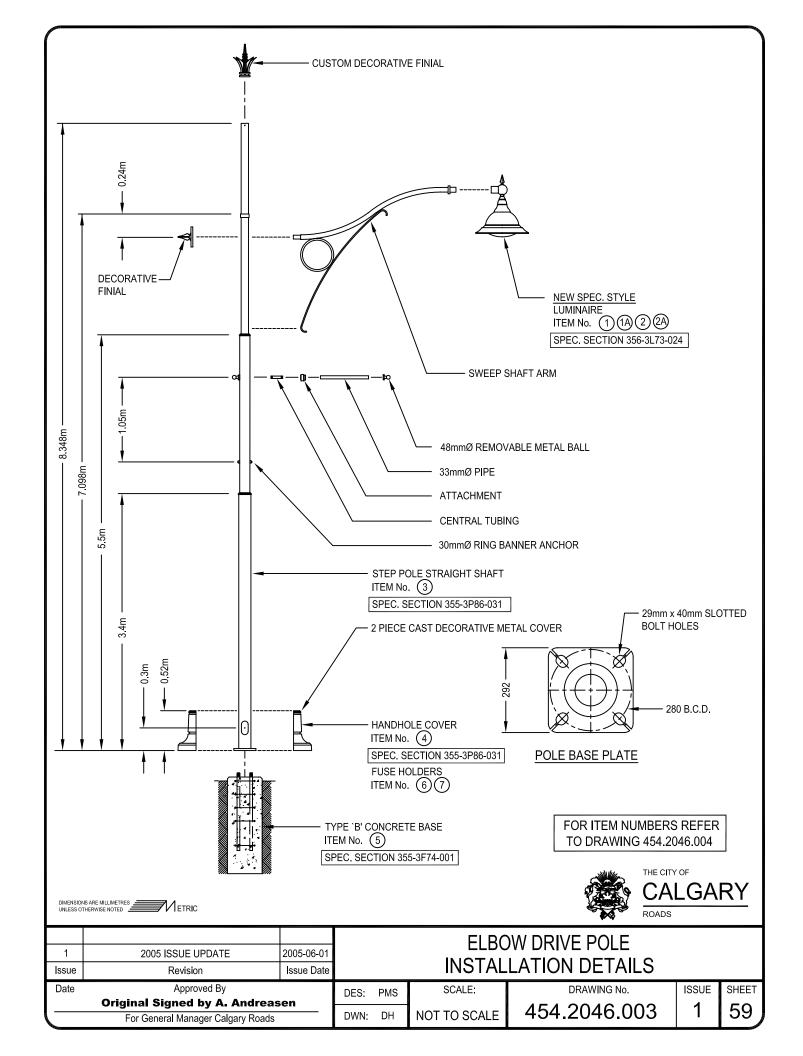



MATERIAL LIST						
ITEM	QTY	STOCK NUMBER		DESCRIPTION	SUPPLIER	
1	1	159355	LUMINAIRE - HPSV	100W - DOMUS CONCEPT STYLE (TYPE 1)	ROADS	
1A	1	143988	LAMP - HPSV	100W CLEAR	ROADS	
2	1	159826	LUMINAIRE - HPSV	150W - DOMUS CONCEPT STYLE (TYPE 1)	ROADS	
2A	1	143989	LAMP - HPSV	150W CLEAR	ROADS	
3	1	157201	POLE - PAINTED	7m - STEP POLE-STRAIGHT STYLE - BLACK	ROADS	
4	1	N/A	COVER - HANDHOLE	(SUPPLIED W/DECORATIVE POLE BASE COVER)	ROADS	
5	1	139575	TYPE `B' BASE - CONCRE	ETE PRECAST	ROADS	
6	2	154245	FUSE HOLDER 600V	30A - INLINE	ROADS	
7	2	154247	FUSE 10A 250V	TYPE BAF - 10A	ROADS	
8						
9						
10						

DIMENSIONS ARE MILLIMETRES ETRIC
UNLESS OTHERWISE NOTED

- 1. NO MORE THAN 2 SHIMS SHALL BE USED ON ANY BOLT.
- 2. THE ANCHOR NUTS SHALL BE TORQUED TO 350 FOOT POUNDS.
- 3. PRE-CAST BASE IS SUPPLIED C/W ANCHOR NUTS AND WASHERS.
- 4. POLE IS SUPPLIED C/W LUMINAIRE MOUNTING ARM , FINIALS AND BASE COVER.
- 5. "OLD SPEC. STYLE" FIXTURES ARE NO LONGER AVAILABLE.



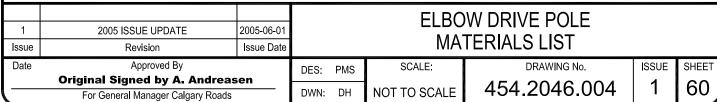


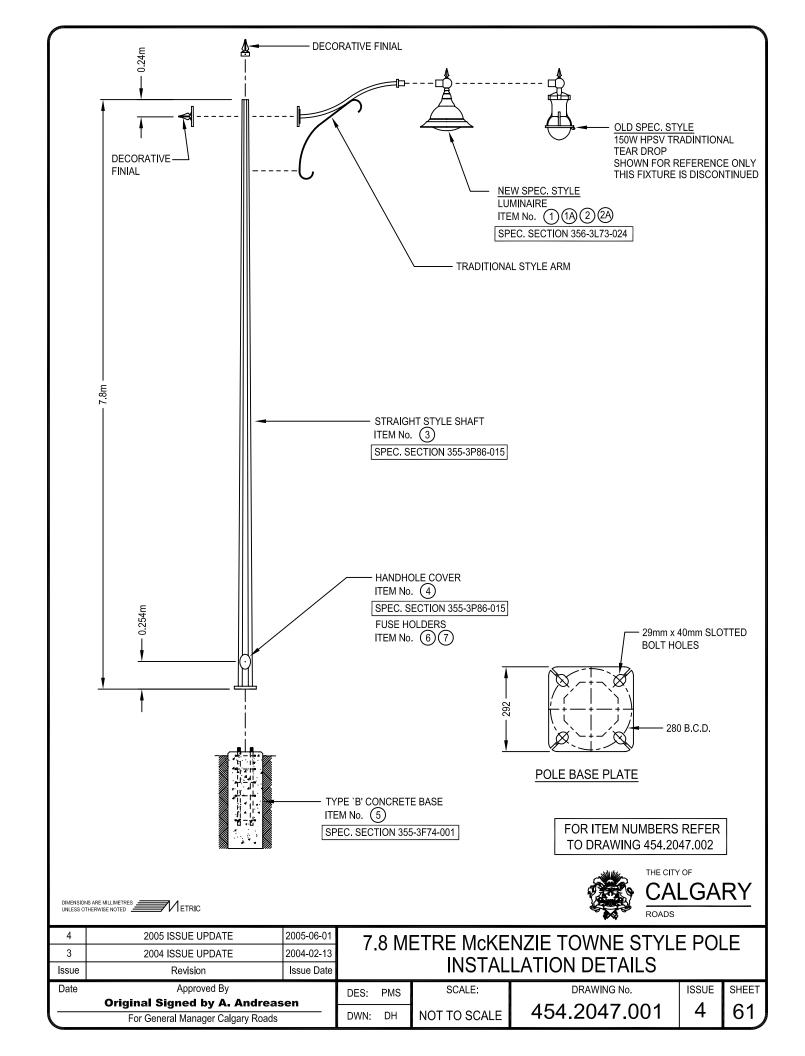


	MATERIAL LIST								
ITEM	QTY	STOCK NUMBER		DESCRIPTION SUPPLIE					
1	1	159355	LUMINAIRE - HPSV	100W - DOMUS CONCEPT STYLE (TYPE 1)	ROADS				
1A	1	143988	LAMP - HPSV	100W CLEAR	ROADS				
2	1	159826	LUMINAIRE - HPSV	150W - DOMUS CONCEPT STYLE (TYPE 1)	ROADS				
2A	1	143989	LAMP - HPSV	150W CLEAR	ROADS				
3	1	151305	POLE - PAINTED	7.8m - STRAIGHT SHAFT - BLACK	ROADS				
4	1	N/A	COVER - HANDHOLE	(SUPPLIED W/POLE)	ROADS				
5	1	139575	TYPE 'B' BASE - CONCF	RETE PRECAST	ROADS				
6	2	154245	FUSE HOLDER 600V	30A - INLINE	ROADS				
7	2	154247	FUSE 10A 250V	TYPE BAF - 10A	ROADS				
8									
9									

- 1. NO MORE THAN 2 SHIMS SHALL BE USED ON ANY BOLT.
- 2. THE ANCHOR NUTS SHALL BE TORQUED TO 350 FOOT POUNDS.
- 3. PRE-CAST BASE IS SUPPLIED C/W ANCHOR NUTS AND WASHERS.
- 4. POLE IS SUPPLIED C/W LUMINAIRE MOUNTING ARM AND FINIALS.
- 5. "OLD SPEC. STYLE" FIXTURES ARE NO LONGER AVAILABLE.




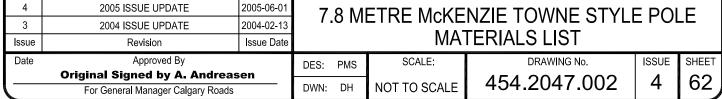


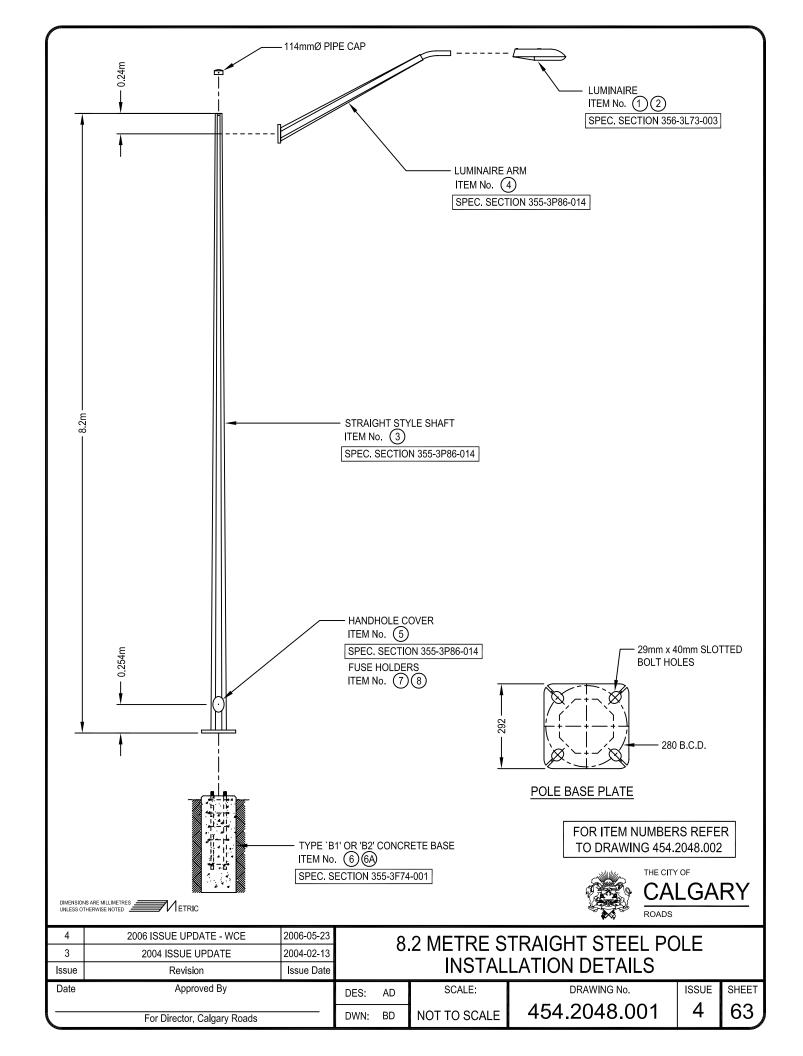


MATERIAL LIST								
ITEM	QTY	STOCK NUMBER	DES	SCRIPTION	SUPPLIER			
1	1	158855	LUMINAIRE - HPSV 200	0W - COBRAHEAD FLAT LENS	ROADS			
2	1	143990	LAMP - HPSV 20	00W	ROADS			
3	1	151267	POLE - GALVANIZED 8.	2m - STRAIGHT STEEL	ROADS			
4	1	151364	UPSWEEP LUMINAIRE ARM W/	/ MOUNTING HARDWARE	ROADS			
5	1	151819	COVER - HANDHOLE (S	SUPPLIED W/POLE)	ROADS			
6	1	139578	TYPE `B1' BASE - ROUND CON	ICRETE PRECAST	ROADS			
6A	1	159907	TYPE `B2' BASE - SQUARE COI	NCRETE BASE	ROADS			
7	2	154245	FUSE HOLDER 600V 30	0A - INLINE	ROADS			
8	2	154247	FUSE 10A 250V T	YPE BAF - 10A	ROADS			
9								
10								

- 1. NO MORE THAN 2 SHIMS SHALL BE USED ON ANY BOLT.
- 2. THE ANCHOR NUTS SHALL BE TORQUED TO 350 FOOT POUNDS.
- 3. PRE-CAST BASE IS SUPPLIED C/W ANCHOR NUTS AND WASHERS.
- 4. POLE IS SUPPLIED C/W TOP CAP AND LUMINAIRE ARM.

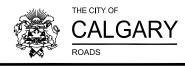

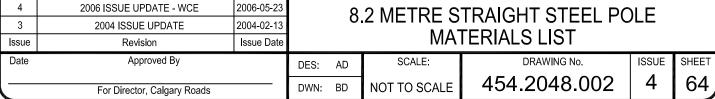

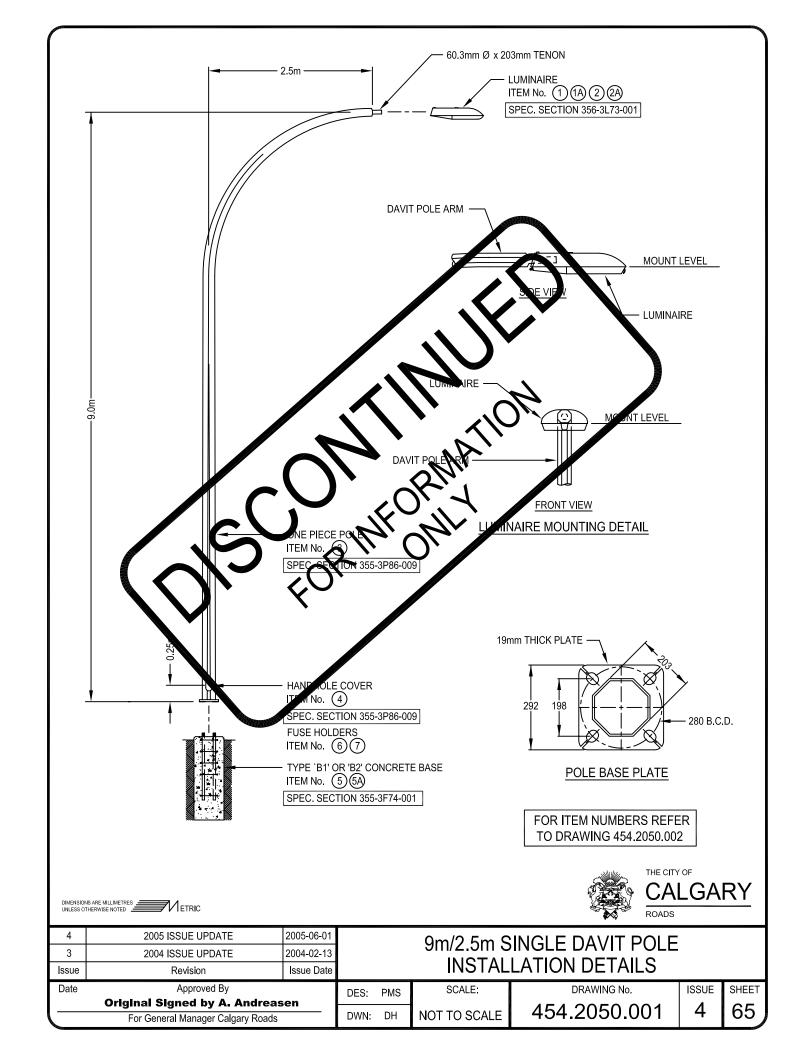


	MATERIAL LIST							
ITEM	QTY	STOCK NUMBER	DESCRIPTION	SUPPLIER				
1	1	158572	LUMINAIRE - HPSV 100W - COBRAHEAD FLAT LENS (SEE NOTE 4 BELOW)	ROADS				
1A		143988	LAMP - HPSV 100W (SEE NOTE 4 BELOW)	ROADS				
2	1	158573	LUMINAIRE - HPSV 150W - COBRAHEAD FLY LENS (SEE NOTE 4 BELOW)	ROADS				
2A	1	143989	LAMP - HPSV 150W (S. ENO) E 4 BELOW)	ROADS				
3	1	151321	POLE - GALVANIZED 9m x x mm - SINGLADA T	ROADS				
4	1	151819	COVER - HANDHOLE SUPPLIED W. OLE)	ROADS				
5	1	139578	TYPE 'B1' BASE - ROLLID CONCRETE PRE CAS	ROADS				
5A	1	159907	TYPE 'B2' BASE' SQUARE CON YESE PREC ST	ROADS				
6	2	154245	FUSE HOWER 600V	ROADS				
7	2	154247	FUS 10A 250V TYPE BAF - 10A	ROADS				
8								
9								
10								

- REQUIRED.






4	2005 ISSUE UPDATE	2005-06-01		9m/2.5m SINGLE DAVIT POLE					
3	2004 ISSUE UPDATE	2004-02-13							
Issue	Revision	Issue Date			MA	ΓERIALS LIST			
Date	Approved By		DES:	PMS	SCALE:	DRAWING No.	ISSUE	SHEET	
	Original Signed by A. Andreasen					454.2050.002	1	66	
	For General Manager Calgary Roads				NOT TO SCALE	404.2000.002	<del>  '1</del>		

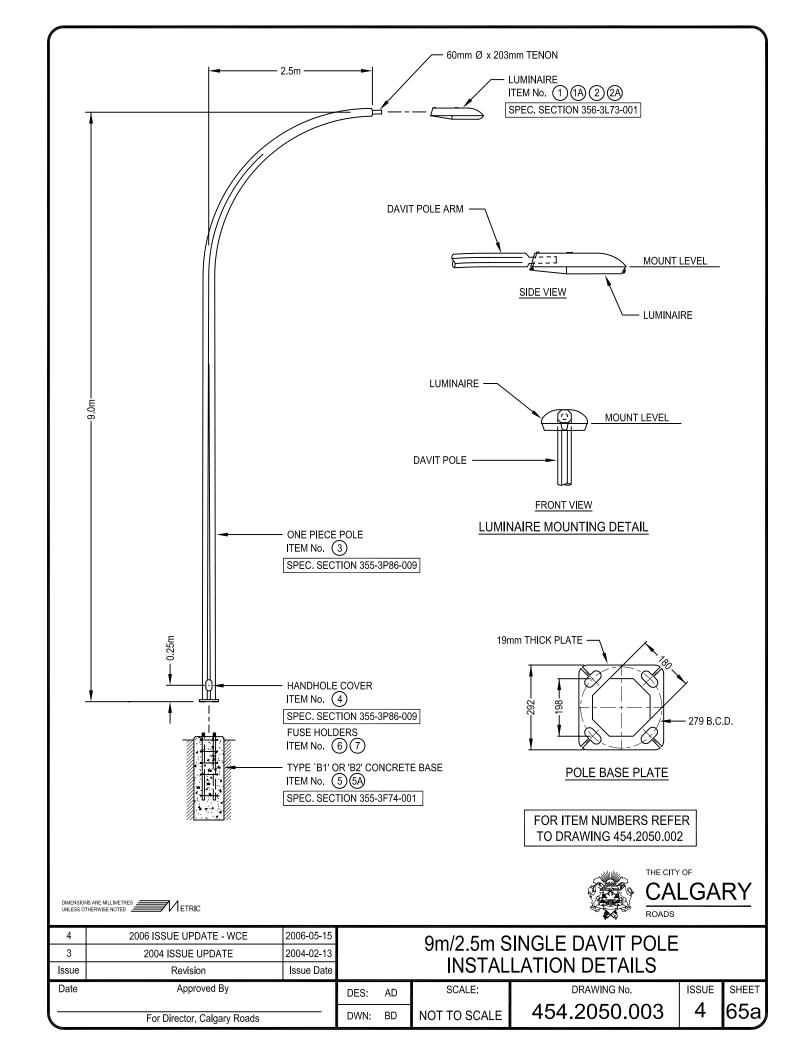

	MATERIAL LIST							
ITEM	QTY	STOCK NUMBER	DESCRIPTION	SUPPLIER				
1	1	158572	LUMINAIRE - HPSV 100W - COBRAHEAD FLAT LENS (SEE NOTE 4 BELOW)	ROADS				
1A	1	158573	LUMINAIRE - HPSV 150W - COBRAHEAD FLAT LENS (SEE NOTE 4 BELOW)	ROADS				
2	1	143988	LAMP - HPSV 100W (SEE NOTE 4 BELOW)	ROADS				
2A	1	143989	LAMP - HPSV 150W (SEE NOTE 4 BELOW)	ROADS				
3	1	151321	POLE - GALVANIZED 9m x 2.5m - SINGLE DAVIT	ROADS				
4	1	151819	COVER - HANDHOLE (SUPPLIED W/POLE)	ROADS				
5	1	139578	TYPE `B1' BASE - ROUND CONCRETE PRECAST	ROADS				
5A	1	159907	TYPE `B2' BASE - SQUARE CONCRETE PRECAST	ROADS				
6	2	154245	FUSE HOLDER 600V 30A - INLINE	ROADS				
7	2	154247	FUSE 10A 250V TYPE BAF - 10A	ROADS				
8								
9								
10								

- 1. WHEN ASSEMBLED THE LOWER 5 METRES OF THE POLE MUST BE PLUMB.
- 2. NO MORE THAN 2 SHIMS SHALL BE USED ON ANY ANCHOR BOLT.
- 3. THE ANCHOR NUTS SHALL BE TIGHTENED AS PER SPEC. 352,01.02.
- 4. 100W FLAT LENS LUMINAIRE IS TYPICAL. REFER TO STREET LIGHTING DESIGN DRAWINGS FOR SPECIFIC LUMINAIRE TYPE & WATTAGE REQUIRED.
- 5. PRE-CAST BASE IS SUPPLIED C/W ANCHOR NUTS AND WASHERS.




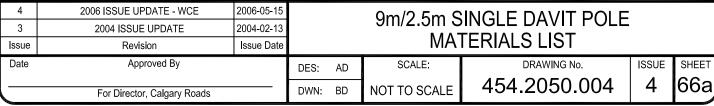




	MATERIAL LIST							
ITEM	QTY	STOCK NUMBER	DESCRIPTION	SUPPLIER				
1	2	158572	LUMINAIRE - HPSV 100W - COBRAHEAD FLAT LENS (SEE NOTE 4 BELOW)	ROADS				
1A	2	143988	LAMP - HPSV 100W (SEE NOTE 4 BELOW)	ROADS				
2	2	158573	LUMINAIRE - HPSV 150W - COBRAHEAD FLOT LENS (SEE NOTE 4 BELOW)	ROADS				
2A	2	143989	LAMP - HPSV 150W REF NOTE 4 BELOW)	ROADS				
3	1	151322	POLE - GALVANIZED 9m x 2.5m OUBLE DAY	ROADS				
4	1	151819	COVER - HANDHOLE (SUPPLIED W/POLE)	ROADS				
5	1	139578	TYPE 'B1' BASE - ROUND CONCRETE PRECAST	ROADS				
5A	1	159907	TYPE 'B2' BASE / QUARE CONCRETE A ECAS	ROADS				
6	4	154245	FUSE HOLDER 600V 30A - NUINE	ROADS				
7	4	154247	FUSE VA 250V TYPERAF 10A	ROADS				
8								
9								
10								

- E REQUIRED.
- GS FOR SPECIFIC A MINAIRE TYPE & WATT/ IS SUPPLIED C/W ANCHOR NUTS AND W/ A

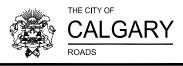




4	2005 ISSUE UPDATE	2005-06-01		9m/2.5m DOUBLE DAVIT POLE					
3	2004 ISSUE UPDATE	2004-02-13							
Issue	Revision	Issue Date	MATERIALS LIST						
Date	Approved By		DES:	PMS	SCALE:	DRAWING No.	ISSUE	SHEET	
	Original Signed by A. Andreasen			DH		454.2051.002	1	ြင္ပ	
	For General Manager Calgary Roads				NOT TO SCALE	434.2031.002	4	68	

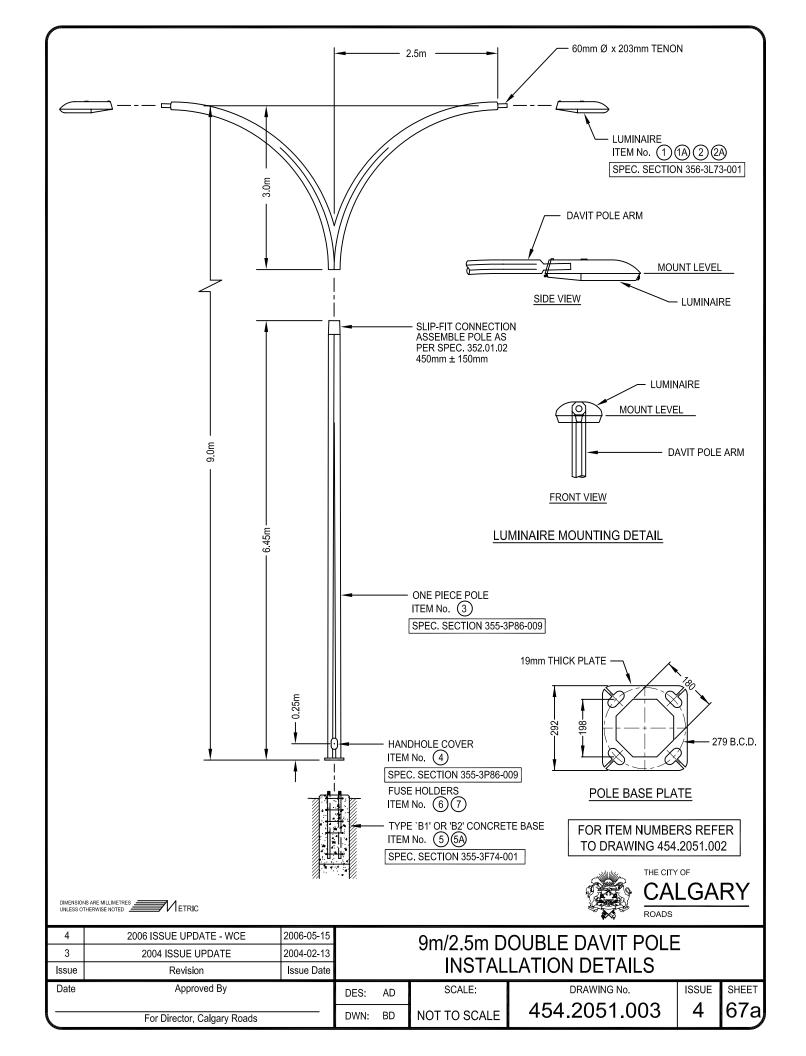


	MATERIAL LIST								
ITEM	QTY	STOCK NUMBER		DESCRIPTION		SUPPLIER			
1	2	158572	LUMINAIRE - HPSV	100W - COBRAHEAD FLAT LENS	(SEE NOTE 4 BELOW)	ROADS			
1A	2	158573	LUMINAIRE - HPSV	150W - COBRAHEAD FLAT LENS	(SEE NOTE 4 BELOW)	ROADS			
2	2	143988	LAMP - HPSV	100W	(SEE NOTE 4 BELOW)	ROADS			
2A	2	143989	LAMP - HPSV	150W	(SEE NOTE 4 BELOW)	ROADS			
3	1	160360	POLE - GALVANIZED	9m x 2.5m - DOUBLE DAVIT (BOTT)	OM)	ROADS			
3A	1	160361	POLE - GALVANIZED	9m x 2.5m - DOUBLE DAVIT (TOP)		ROADS			
4	1	151819	COVER - HANDHOLE	(SUPPLIED W/POLE)		ROADS			
5	1	139578	TYPE `B1' BASE - ROU	ND CONCRETE PRECAST		ROADS			
5A	1	159907	TYPE `B2' BASE - SQU	ARE CONCRETE PRECAST		ROADS			
6	4	154245	FUSE HOLDER 600V	30A - INLINE		ROADS			
7	4	154247	FUSE 10A 250V	TYPE BAF - 10A		ROADS			
8									
9									

- 1. WHEN ASSEMBLED THE LOWER 5 METRES OF THE POLE MUST BE PLUMB.
- 2. NO MORE THAN 2 SHIMS SHALL BE USED ON ANY ANCHOR BOLT.
- 3. THE ANCHOR NUTS SHALL BE TIGHTENED AS PER SPEC, 352,01,02.
- 4. 100W FLAT LENS LUMINAIRE IS TYPICAL. REFER TO STREET LIGHTING DESIGN DRAWINGS FOR SPECIFIC LUMINAIRE TYPE & WATTAGE REQUIRED.
- 5. PRE-CAST BASE IS SUPPLIED C/W ANCHOR NUTS AND WASHERS.



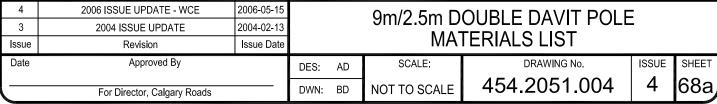


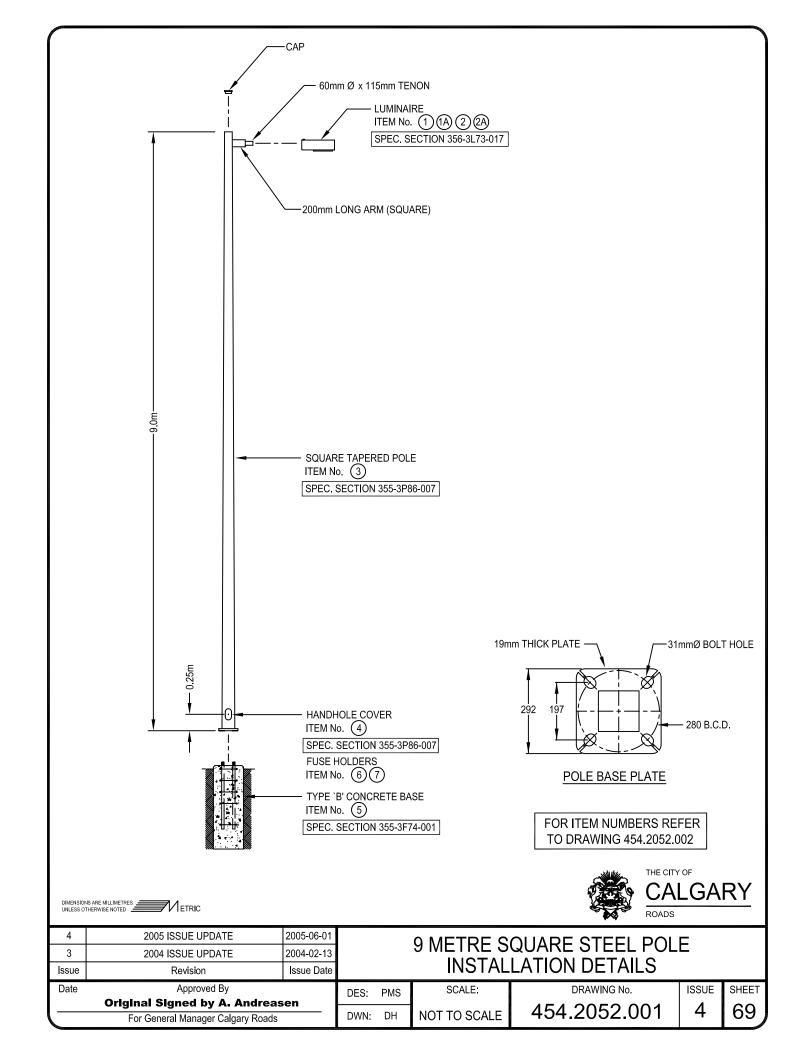


MATERIAL LIST									
ITEM	QTY	STOCK NUMBER	DES	DESCRIPTION					
1	1	143046	LUMINAIRE - HPSV	150W - SQUARE PACK	ROADS				
1A	1	143989	LAMP - HPSV	150W - CLEAR	ROADS				
2	1	143039	LUMINAIRE - HPSV	250W - SQUARE PACK	ROADS				
2A	1	143991	LAMP - HPSV	250W - CLEAR	ROADS				
3	1	151241	POLE - PAINTED	9m - SQUARE - BLACK	ROADS				
4	1	N/A	COVER - HANDHOLE	(SUPPLIED W/POLE)	ROADS				
5	1	139575	TYPE `B' BASE - CONCRI	ETE PRECAST	ROADS				
6	2	154245	FUSE HOLDER 600V	30A - INLINE	ROADS				
7	2	154247	FUSE 10A 250V	TYPE BAF - 10A	ROADS				
8									
9									

- 1. NO MORE THAN 2 SHIMS SHALL BE USED ON ANY ANCHOR BOLT.
- 2. THE ANCHOR NUTS SHALL BE TIGHTENED AS PER SPEC. 352.01.02.
- 3. PRE-CAST BASE IS SUPPLIED C/W ANCHOR NUTS AND WASHERS.
- 4. POLE IS SUPPLIED C/W TOP CAP AND LUMINAIRE ARM.



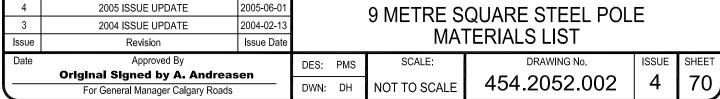

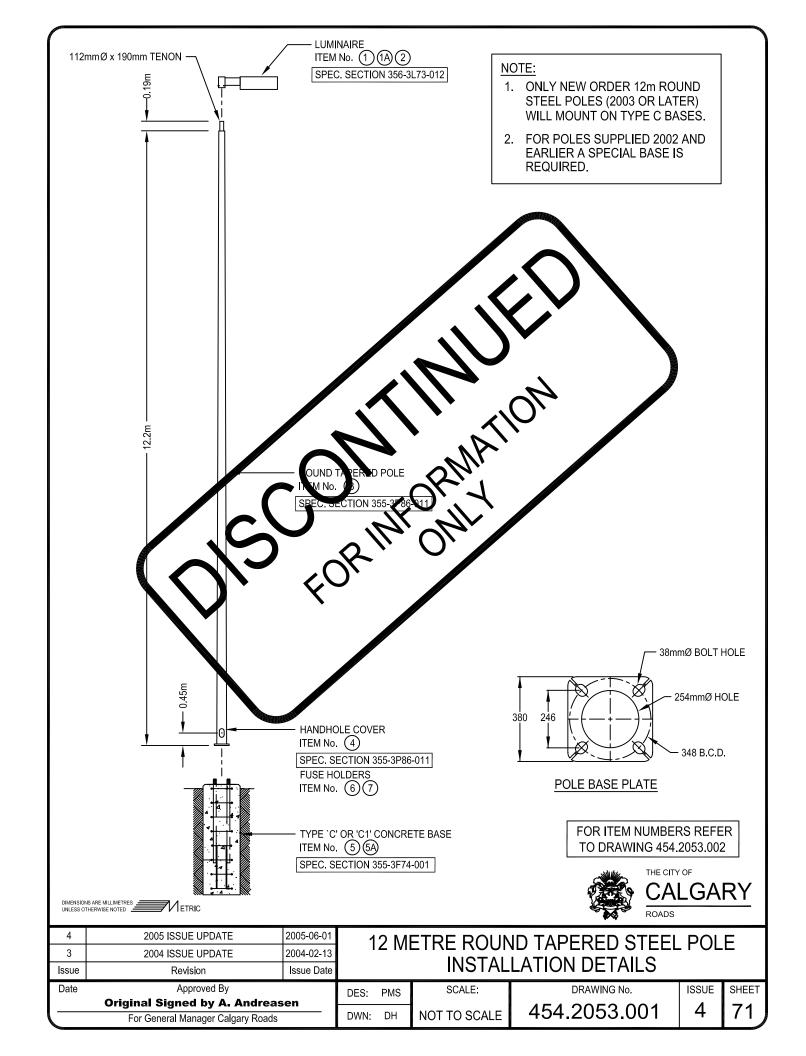


MATERIAL LIST								
ITEM	QTY	STOCK NUMBER		DESCRIPTION	SUPPLIER			
1	1	143035	LUMINAIRE - MH	1000W - ROUND PACK (11th Ave.)	ROADS			
1A	1	143048	LUMINAIRE - MH	1000W - ROUND PACK (7th Ave.)	ROADS			
2	1	143986	LAMP - MH	1000W - CL	ROADS			
3	1	151808	POLE - GALVANIZED	12m XOUND TAPERED	ROADS			
4	1	N/A	COVER - HANDHOLE	SUPPLIED W. OLE)	ROADS			
5	1	139576	TYPE 'C' - ROUND PB	AST CONCLETE	ROADS			
5A	1	159908	TYPE `C1' - SQUIRE PR	ECAST CONTACTE	ROADS			
6	2	154245	FUSE HOL ZR 600V	30A - ILLINE	NADS			
7	2	154247	FUST 10A 250V	NPE FAF - 10A	ROALS			
8				7				
9								
10								

- 1. NO MORE THE X 2 SHIMS SHALL RE USED ON ANY ANCHOR SO
- 2. THE ANCY OR NUTS SHALL BE TIGHTEN D AS PER SPEC. 352 01.02.
- 3. PRE-CAST BASE IS SUI PLIED CAT ANCHOR NUTS AND WASHERS



4	2005 ISSUE UPDATE	2005-06-01	1	12 METRE ROUND TAPERED STEEL POLE					
3	2004 ISSUE UPDATE	2004-02-13						· <b>L</b>	
Issue	Revision	Issue Date	MATERIALS LIST						
Date	Approved By		DES:	PMS	SCALE:	DRAWING No.	ISSUE	SHEET	
	Original Signed by A. Andreasen					454.2053.002	1 1	72	
	For General Manager Calgary Roads				NOT TO SCALE	454.2055.002	4	12	

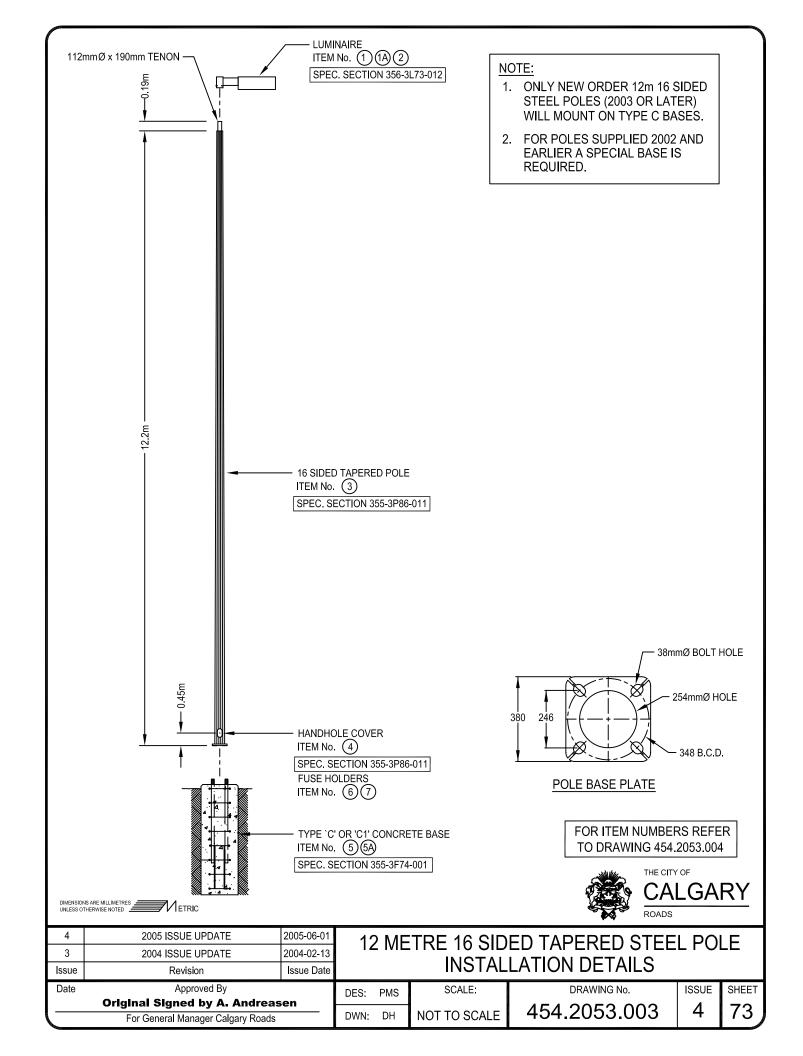


	MATERIAL LIST								
ITEM	QTY	STOCK NUMBER	DESCRIPTION	SUPPLIER					
1	1	143035	LUMINAIRE - MH 1000W - ROUND PACK (11th Ave.)	ROADS					
1A	1	143048	LUMINAIRE - MH 1000W - ROUND PACK (7th Ave.)	ROADS					
2	1	143986	LAMP - MH 1000W - CLEAR	ROADS					
3	1	151808	POLE - GALVANIZED 12m - 16 SIDED TAPERED	ROADS					
4	1	N/A	COVER - HANDHOLE (SUPPLIED W/POLE)	ROADS					
5	1	139576	TYPE `C' - PRECAST CONCRETE CONFIRM WITH ROADS BEFORE ORDERING	ROADS					
5A	1	159908	TYPE `C1' BASE - SQUARE CONCRETE PRECAST CONFIRM WITH ROADS BEFORE ORDERING	ROADS					
6	2	154245	FUSE HOLDER 600V 30A - INLINE	ROADS					
7	2	154247	FUSE 10A 250V TYPE BAF - 10A	ROADS					
8									
9									
10									

- 1. NO MORE THAN 2 SHIMS SHALL BE USED ON ANY ANCHOR BOLT.
- 2. THE ANCHOR NUTS SHALL BE TIGHTENED AS PER SPEC. 352.01.02.
- 3. PRE-CAST BASE IS SUPPLIED C/W ANCHOR NUTS AND WASHERS.




4	2006 ISSUE UPDATE - WCE	2006-05-23	11	12 METRE 16 SIDED TAPERED STEEL POLE					
3	2004 ISSUE UPDATE	2004-02-13							
Issue	Revision	Issue Date	MATERIALS LIST						
Date	Approved By		DES:	AD	SCALE:	DRAWING No.	ISSUE	SHEET	
					NOT TO 2041 F	454.2053.004	1	7/	
	For Director, Calgary Roads		DWN:	BD	NOT TO SCALE	434.2033.004			

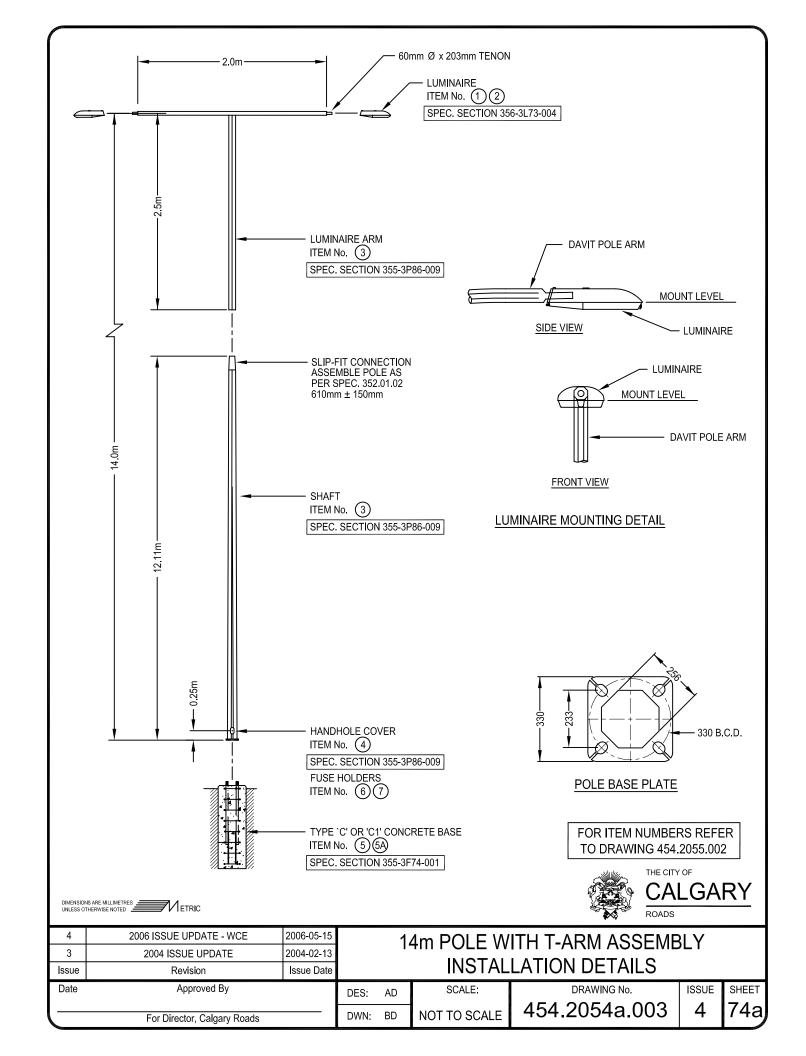


	MATERIAL LIST											
ITEM	QTY	STOCK NUMBER		DESCRIPTION		SUPPLIER						
1	2	158856	LUMINAIRE - HPSV	400W - COBRAHEAD FLAT LENS	(SEE NOTE 4 BELOW)	ROADS						
2	2	143992	LAMP - HPSV	400W - CLEAR	(SEE NOTE 4 BELOW)	ROADS						
3	1	160362	POLE - GALVANIZED	14m x 2.0m - DOUBLE DAVIT (BOT	TOM)	ROADS						
4	1	151325	POLE - GALVANIZED	14m x 2.0m - DOUBLE DAVIT (TOP	)	ROADS						
5	1	151819	COVER - HANDHOLE	(SUPPLIED W/POLE)		ROADS						
6	1	139576	TYPE `C' BASE - ROUND	CONCRETE PRECAST		ROADS						
6A	1	159908	TYPE `C1' BASE - SQUAF	RE CONCRETE PRECAST		ROADS						
7	4	154245	FUSE HOLDER 600V	30A - INLINE		ROADS						
8	4	154247	FUSE 10A 250V	TYPE BAF - 10A		ROADS						
9												
10												

- 1. WHEN ASSEMBLED THE LOWER 5 METRES OF THE POLE MUST BE PLUMB.
- 2. NO MORE THAN 2 SHIMS SHALL BE USED ON ANY ANCHOR BOLT.
- 3. THE ANCHOR NUTS SHALL BE TIGHTENED AS PER SPEC. 352.01.02.
- 4. 400W FLAT LENS LUMINAIRE IS TYPICAL. REFER TO STREET LIGHTING DESIGN DRAWINGS FOR SPECIFIC LUMINAIRE TYPE & WATTAGE REQUIRED.
- 5. PRE-CAST BASE IS SUPPLIED C/W ANCHOR NUTS AND WASHERS.

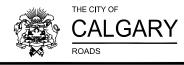





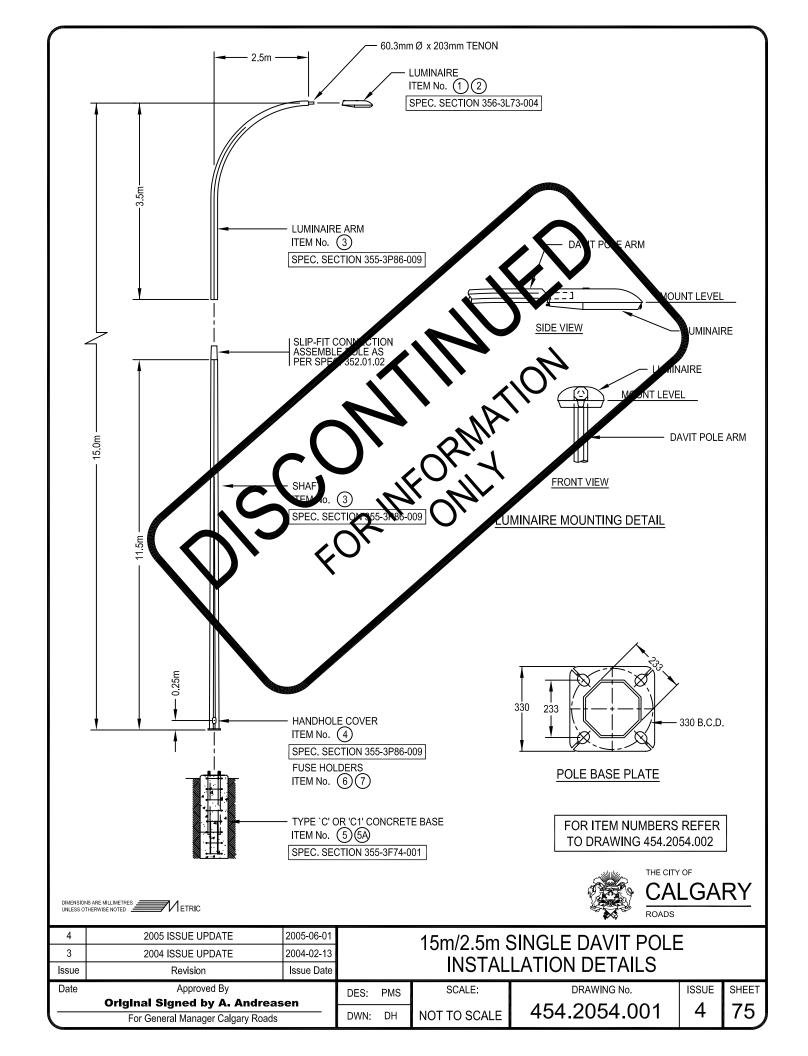


			MATERIA	AL LIST		
ITEM	QTY	STOCK NUMBER		DESCRIPTION		SUPPLIER
1	1	158856	LUMINAIRE - HPSV	400W - COBRAHEAD FLAT LENS	S (SEE NOTE 4 BELOW)	ROADS
2	1	143992	LAMP - HPSV	400W CLEAR	(SEE NOTE 4 BELOW)	ROADS
3	1	151323/151324	POLE - GALVANIZED	15m x 2.5m - SINGLE AVIT		ROADS
4	1	151819	COVER - HANDHOLE	(SUPPLIED W/PLLE)		ROADS
5	1	139576	TYPE `C' BASE - ROUND	CONCRETE RECAST		ROADS
5A	1	159908	TYPE `C1' BASE - SQUAR	RE COMPRETE PRECEST		ROADS
6	2	154245	FUSE HOLDER 600V	30A - INLINE		ROADS
7	2	154247	FUSE 10A 250V	TYPE BAP 10A		ROADS
8						
9				11		
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- 1. WHEN ASSEMBLED THE LOW AR 5 METRES OF THE ADLE MUST BE PLUMD
- 2. NO MORE THAN 2 SHIMS HALL BE USED OF ANY ANOHOR BOLT
- 3. THE ANCHOR NUTS FALL BE TIGHTENED AS DEC. 352.01,02
- 4. 400W FLAT LENS, UMINAIRE IS TYP CAL. REJER TO STREET INSY ING DESIGN DRAY INGS FOR STACIFIC LIGHT TYPE & WATER REQUIRE
- 5. PRE-CAST SASE IS SUPPLIED WAS CHOR NUTS AND WAS NEWS
- 6. POLE I SUPPLIED C/W L MINAIRE / RM.



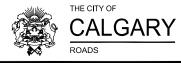

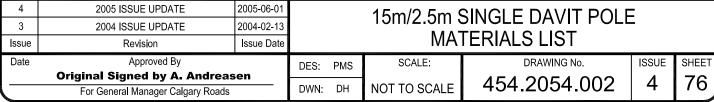


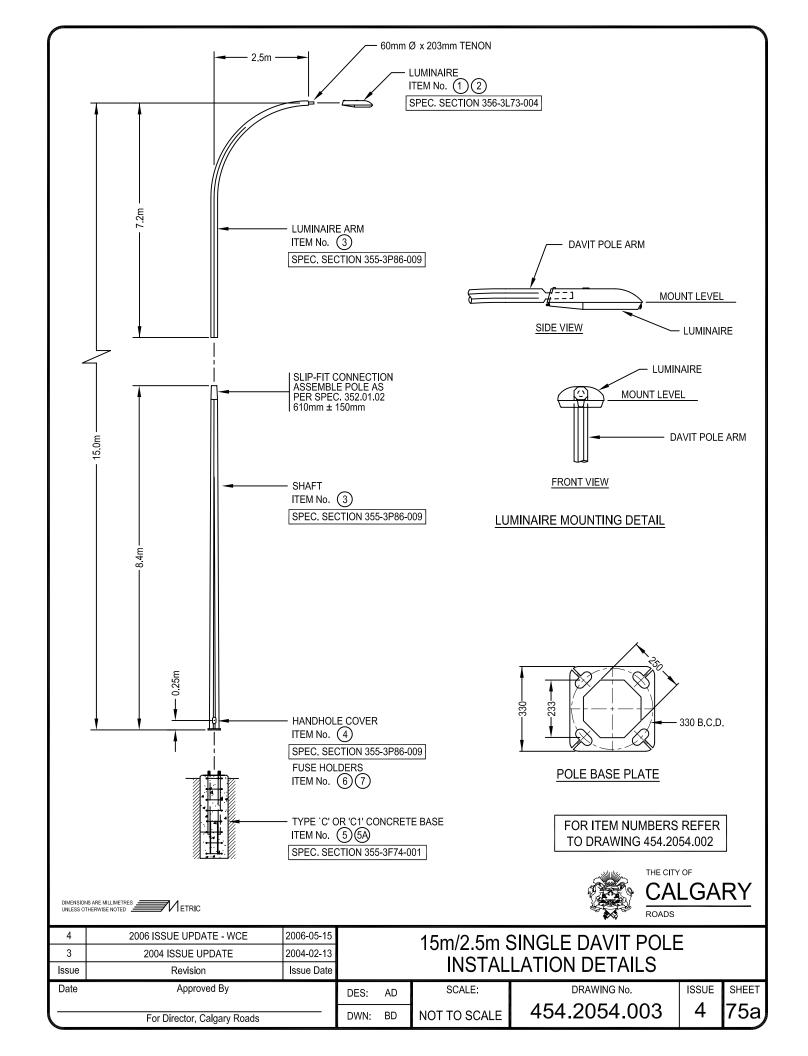			MATERIA	AL LIST		
ITEM	QTY	STOCK NUMBER		DESCRIPTION		SUPPLIER
1	1	158856	LUMINAIRE - HPSV	400W - COBRAHEAD FLAT LEN	IS (SEE NOTE 4 BELOW)	ROADS
2	1	143992	LAMP - HPSV	400W CLEAR	(SEE NOTE 4 BELOW)	ROADS
3	1	151323	POLE - GALVANIZED	15m x 2.5m - SINGLE DAVIT (B	ОТТОМ)	ROADS
4	1	151324	POLE - GALVANIZED	15m x 2.5m - SINGLE DAVIT (T	OP)	ROADS
5	1	151819	COVER - HANDHOLE	(SUPPLIED W/POLE)		ROADS
5A	1	139576	TYPE `C' BASE - ROUND	CONCRETE PRECAST		ROADS
6	1	159908	TYPE `C1' BASE - SQUAF	RE CONCRETE PRECAST		ROADS
7	2	154245	FUSE HOLDER 600V	30A - INLINE		ROADS
8	2	154247	FUSE 10A 250V	TYPE BAF - 10A		ROADS
9						
10						

- 1. WHEN ASSEMBLED THE LOWER 5 METRES OF THE POLE MUST BE PLUMB.
- 2. NO MORE THAN 2 SHIMS SHALL BE USED ON ANY ANCHOR BOLT.
- 3. THE ANCHOR NUTS SHALL BE TIGHTENED AS PER SPEC. 352.01.02.
- 4. 400W FLAT LENS LUMINAIRE IS TYPICAL. REFER TO STREET LIGHTING DESIGN DRAWINGS FOR SPECIFIC LUMINAIRE TYPE & WATTAGE REQUIRED.
- 5. PRE-CAST BASE IS SUPPLIED C/W ANCHOR NUTS AND WASHERS.






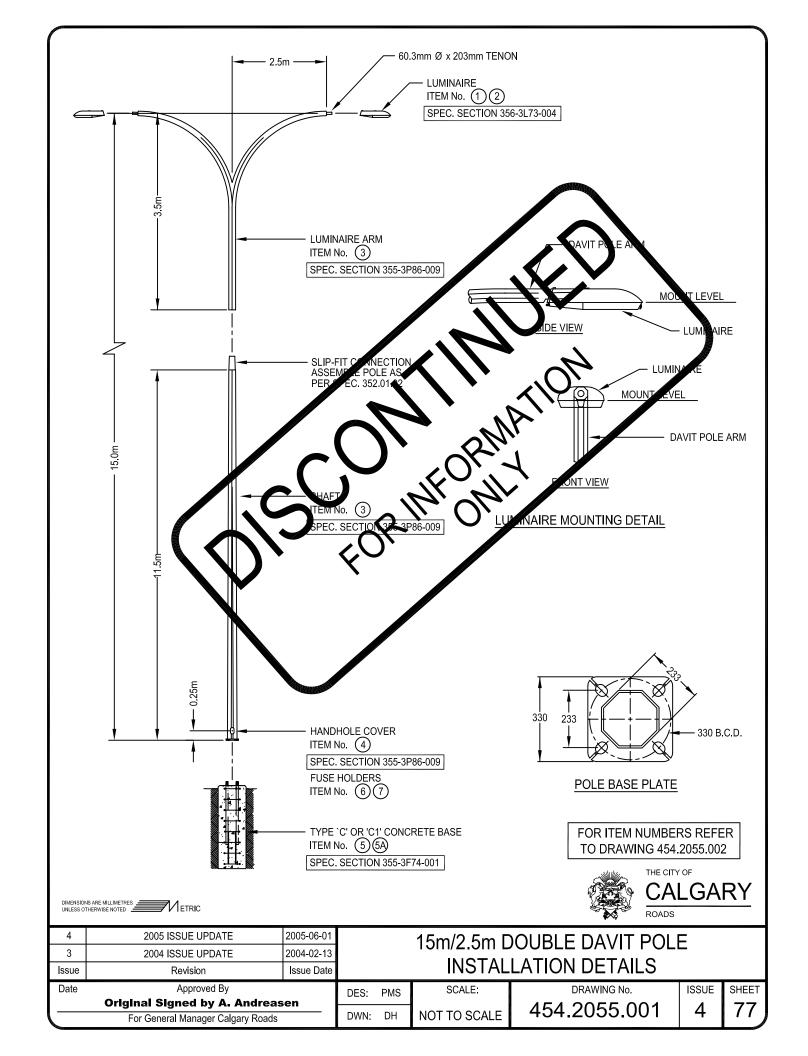


			M	ATERIAL LIST						
ITEM	QTY	STOCK NUMBER		DESCRIPTION						
1	2	158856	LUMINAIRE - HPSV	400W - COBRAHEAD FLAT LENS	(SEE NOTE 4 BELOW)	ROADS				
2	2	143992	LAMP - HPSV	400W - CLEAR	(SEE NOTE 4 BELOW)	ROADS				
3	1	151323/151325	POLE - GALVANIZED	15m x 2.5m - DOUBLE 7 VIT		ROADS				
4	1	151819	COVER - HANDHOLE	(SUPPLIED W/POLZ)		ROADS				
5	1	139576	TYPE `C' BASE - ROUND	CONCRETE PERCAST		ROADS				
5A	1	159908	TYPE `C1' BASE - SQUA	RE CONCLETE PRECAS		ROADS				
6	4	154245	FUSE HOLDER 600V	30A - INLINE		ROADS				
7	4	154247	FUSE 10A 250V	TYPE ENF - VA		ROADS				
8				·N						
9				11						
10				10,						

- 1. WHEN ASSEMBLED THE LOWE / METRES OF THE POLE MUST BE PLUMB.
- 2. NO MORE THAN 2 SHIMS SYALL BE USED ON A MY ANCH DR BOLT.
- 3. THE ANCHOR NUTS SHOULD BE TIGHT NED AS PER CELC. 352.01.02
- 4. 400W FLAT LENS LAMINAIRE IS TYPICAL. REFER TO STREET LICHTING DESIGN DRAWL AS FOR SPENIFIC LUMINAIRE TYPE & WATTANE PROUIRED
- 5. PRE-CAST PLSE IS SUPPLIED ST AND HOR NUTS AND WASHER
- 6. POLE IS OPPLIED CAVILUI WAIRE AP

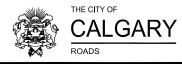

4	2005 ISSUE UPDATE	2005-06-01	15m/2 5m D			OUBLE DAVIT POLE				
3	2004 ISSUE UPDATE	2004-02-13								
Issue Revision Issue Date				MATERIALS LIST						
Date	Pate Approved By			PMS	SCALE:	DRAWING No.	ISSUE	SHEET		
	Original Signed by A. Andreasen			-		454 2055 002	1	70		
	For General Manager Calgary Roads		DWN:	DH	NOT TO SCALE	454.2055.002	4	ره ۱ ا		

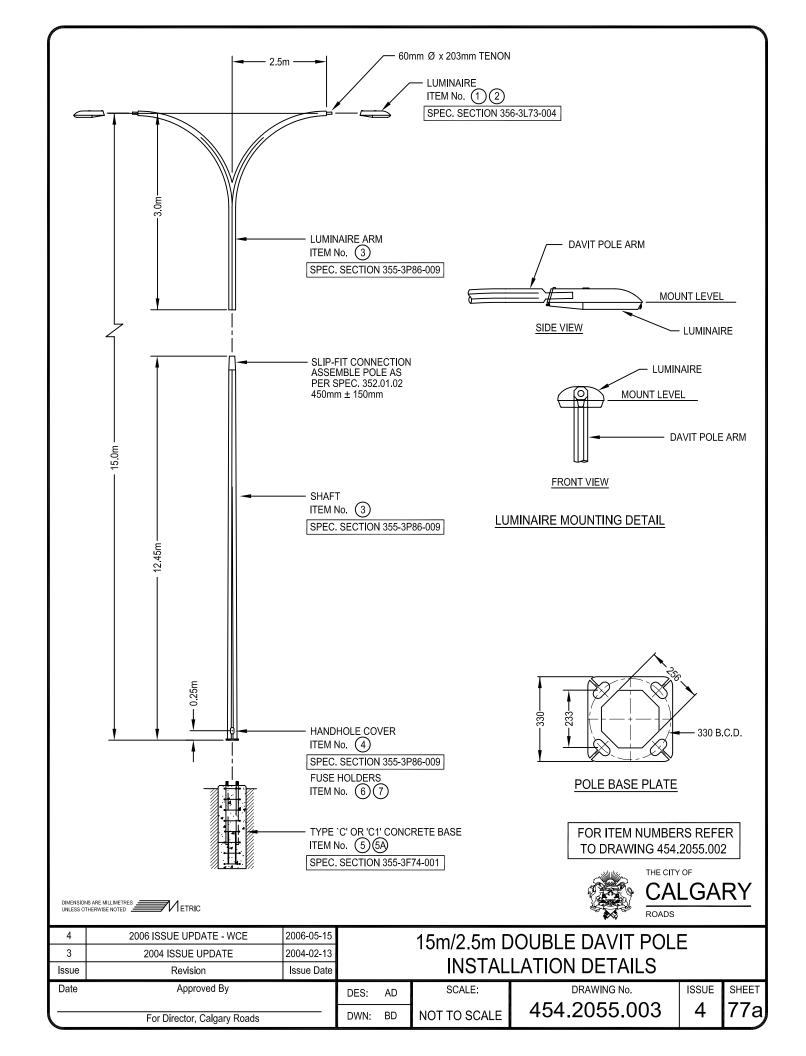


	MATERIAL LIST										
ITEM	QTY	STOCK NUMBER		DESCRIPTION							
1	2	158856	LUMINAIRE - HPSV	400W - COBRAHEAD FLAT LENS	(SEE NOTE 4 BELOW)	ROADS					
2	2	143992	LAMP - HPSV	400W - CLEAR	(SEE NOTE 4 BELOW)	ROADS					
3	1	160362	POLE - GALVANIZED	15m x 2.5m - DOUBLE DAVIT (BOT	TOM)	ROADS					
4	1	151325	POLE - GALVANIZED	15m x 2.5m - DOUBLE DAVIT (TOP	)	ROADS					
5	1	151819	COVER - HANDHOLE	(SUPPLIED W/POLE)		ROADS					
6	1	139576	TYPE `C' BASE - ROUND	CONCRETE PRECAST		ROADS					
6A	1	159908	TYPE `C1' BASE - SQUAF	RE CONCRETE PRECAST		ROADS					
7	4	154245	FUSE HOLDER 600V	30A - INLINE		ROADS					
8	4	154247	FUSE 10A 250V	TYPE BAF - 10A		ROADS					
9											
10											

- 1. WHEN ASSEMBLED THE LOWER 5 METRES OF THE POLE MUST BE PLUMB.
- 2. NO MORE THAN 2 SHIMS SHALL BE USED ON ANY ANCHOR BOLT.
- 3. THE ANCHOR NUTS SHALL BE TIGHTENED AS PER SPEC. 352.01.02.
- 4. 400W FLAT LENS LUMINAIRE IS TYPICAL. REFER TO STREET LIGHTING DESIGN DRAWINGS FOR SPECIFIC LUMINAIRE TYPE & WATTAGE REQUIRED.
- 5. PRE-CAST BASE IS SUPPLIED C/W ANCHOR NUTS AND WASHERS.




4	2006 ISSUE UPDATE - WCE	2006-05-15		15m/2.5m DOUBLE DAVIT POLE					
3	2004 ISSUE UPDATE	2004-02-13							
Issue	Revision	Issue Date		MATERIALS LIST					
Date	ate Approved By		DES:	AD	SCALE:	DRAWING No.	ISSUE	SHEET	
l					NOT TO COALE	454.2055.004	4	782	
	For Director, Calgary Roads		DWN:	BD	NOT TO SCALE	434.2033.004		1 Ga	

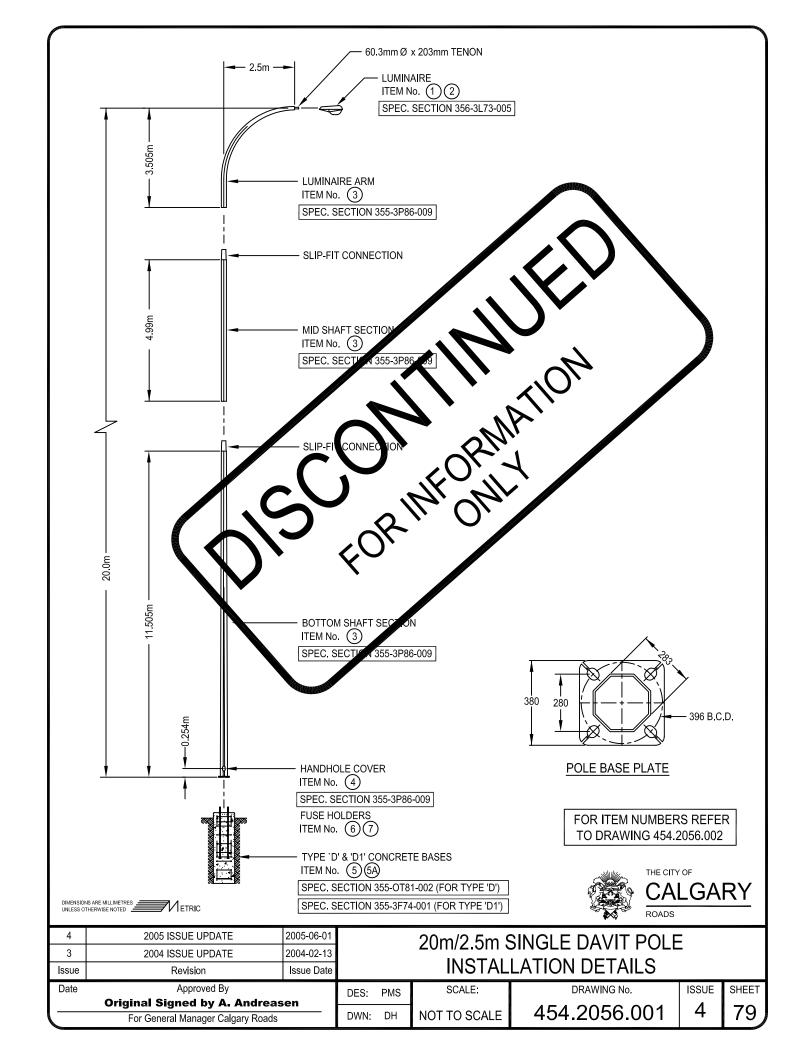


			MA	ΓERIAL LIST						
ITEM	QTY	STOCK NUMBER		DESCRIPTION						
1	1	143038	LUMINAIRE - HPSV	1000W - COBRAHEAD	(SEE NOTE 5 BELOW)	ROADS				
2	1	143993	LAMP - HPSV	1000W - CLEAR	(SEE NOTE 5 BELOW)	ROADS				
3	1	151326/156704/151327	POLE - GALVANIZED	20m x 2.5m - SING DAVIT		ROADS				
4	1	151819	COVER - HANDHOLE	(SUPPLIED MODE)		ROADS				
5	1	N/A	TYPE 'D' BASE - CONCF	RETE POUP D-IN-PLACE		CONTRACTOR				
5A	1	TBA	TYPE `D1' BASE - CONC	RETT RECAST		ROADS				
6	2	154245	FUSE HOLDER 600V	30A - INLINE		ROADS				
7	2	154247	FUSE 10A 250V	TYP BAR 10A		ROADS				
8										
9				11						
10				10,						

- 1. WHEN ASSEMBLED THE LOWER 5 METRE OF THE YOU MUST BE PLUME.
- 2. NO MORE THAN 2 SHIM SHALL BE 1950 IN ANY A CHOR BOLT.
- 3. THE ANCHOR NUT SHALL BE TICHTENED AS ---- SPEC. 352.01
- 4. THE TOP OF THE LUMINAIRE SHALL BE LEVEL AFTER ASSEMBLE
- 5. 1000W LUM AIRE IS TYP CAL. REFUS TREET LIGHTING DESIGN RAWINGS FOR SOCIETY JUMINAIRE TYPE WAY AGE REQUIRED.
- 6. ANCHOR BOLTS ARE SERPLIED CO ANCHOR NUTS ANCHERS, BELL ANCHORS AND BEVELLED NUTS.
- 7. POLE SUPPLED C/W UMMAIRE ARM

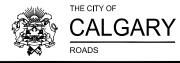


4	2005 ISSUE UPDATE	2005-06-01	20m/2.5m S			SINGLE DAVIT POLE			
3	2004 ISSUE UPDATE	2004-02-13							
Issue	Revision	Issue Date			MA	TERIALS LIST			
Date	e Approved By			PMS	SCALE:	DRAWING No.	ISSUE	SHEET	
	Original Signed by A. Andreasen					454 2050 002	1	ا مم	
	For General Manager Calgary Roads				NOT TO SCALE	454.2056.002	4	80	

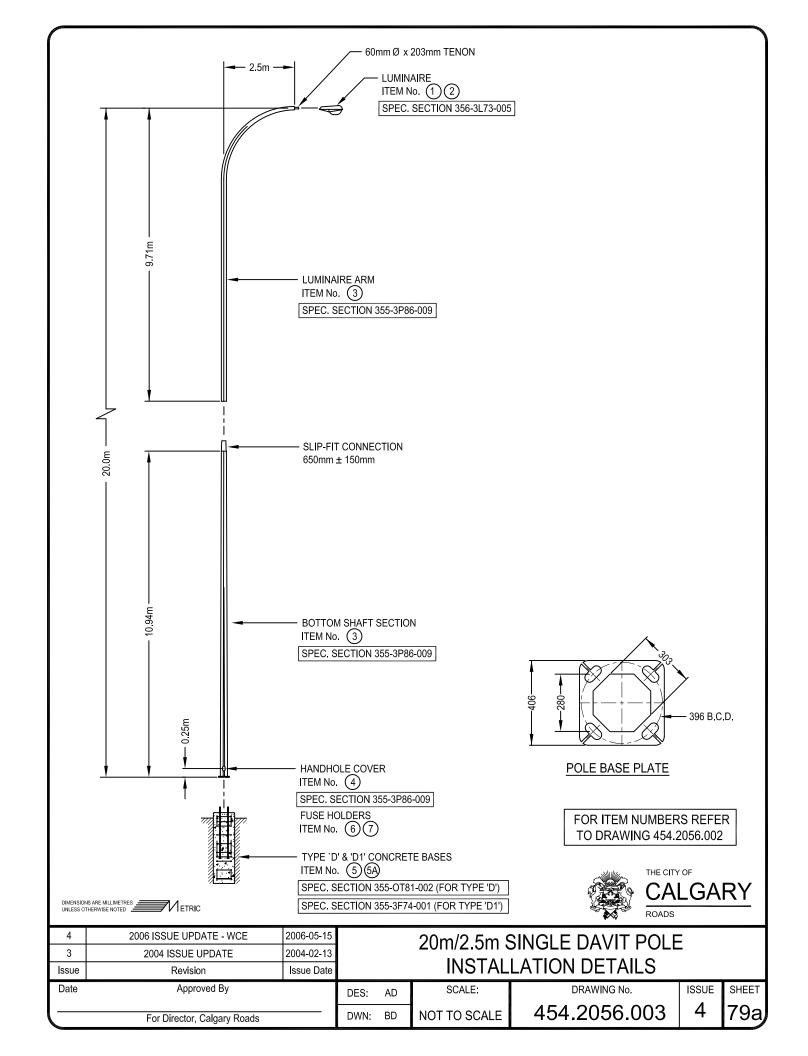

	MATERIAL LIST										
ITEM	QTY	STOCK NUMBER		DESCRIPTION		SUPPLIER					
1	1	143038	LUMINAIRE - HPSV	LUMINAIRE - HPSV 1000W - COBRAHEAD (SEE NOTE 5 BELOW)							
2	1	143993	LAMP - HPSV	1000W - CLEAR	(SEE NOTE 5 BELOW)	ROADS					
3	1	151326	POLE - GALVANIZED	20m x 2.5m - SINGLE DAVIT (E	ВОТТОМ)	ROADS					
4	1	151327	POLE - GALVANIZED	20m x 2.5m - SINGLE DAVIT (1	ГОР)	ROADS					
5	1	151819	COVER - HANDHOLE	(SUPPLIED W/POLE)		ROADS					
6	1	N/A	TYPE `D' BASE - CONCR	ETE POURED-IN-PLACE		CONTRACTOR					
6A	1	TBA	TYPE `D1' BASE - CONC	RETE PRECAST		ROADS					
7	2	154245	FUSE HOLDER 600V	30A - INLINE		ROADS					
8	2	154247	FUSE 10A 250V	TYPE BAF - 10A		ROADS					
9											
10											

- 1. WHEN ASSEMBLED THE LOWER 5 METRES OF THE POLE MUST BE PLUMB.
- 2. NO MORE THAN 2 SHIMS SHALL BE USED ON ANY ANCHOR BOLT.
- 3. THE ANCHOR NUTS SHALL BE TIGHTENED AS PER SPEC. 352.01.02.
- 4. THE TOP OF THE LUMINAIRE SHALL BE LEVEL AFTER ASSEMBLY.
- 5. 1000W LUMINAIRE IS TYPICAL. REFER TO STREET LIGHTING DESIGN DRAWINGS FOR SPECIFIC LUMINAIRE TYPE & WATTAGE REQUIRED.
- 6. ANCHOR BOLTS ARE SUPPLIED C/W ANCHOR NUTS, WASHERS, BELL ANCHORS AND BEVELLED NUTS.

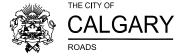





3	2006 ISSUE UPDATE - WCE 2004 ISSUE UPDATE	2006-05-15		20m/2.5m SINGLE DAVIT POLE					
Issue	Revision	Issue Date							
Date	Date Approved By			AD	SCALE:	DRAWING No.	ISSUE	SHEET	
	For Director, Calgary Roads		DWN:	BD	NOT TO SCALE	454.2056.004	4	80a	




MATERIAL LIST									
ITEM	QTY	STOCK NUMBER		DESCRIPTION		SUPPLIER			
1	2	143038	LUMINAIRE - HPSV	1000W - COBRAHEAD	(SEE NOTE 5 BELOW)	ROADS			
2	2	143993	LAMP - HPSV	1000W - CLEAR	(SEE NOTE 5 BELOW)	ROADS			
3	1	151326/156704/151328	POLE - GALVANIZED	20m x 2.5m - DOU" _E DAN	/IT	ROADS			
4	1	151819	COVER - HANDHOLE	(SUPPLIED / POLE)		ROADS			
5	1	N/A	TYPE `D' BASE - CONCRETE	POURED-IM LACE		CONTRACTOR			
5A	1	TBA	TYPE `D1' BASE - CONCRET	E PRISAST		ROADS			
6	4	154245	FUSE HOLDER 600V	30A - INLINE		ROADS			
7	4	154247	FUSE 10A 250V	TYAT BAX - 10A		ROADS			
8				N					
9				1					
10				, VO					

- 1. WHEN ASSEMBLED THE LOWER 5 METRES OF THE POLYMUST BE PLUMP
- 2. NO MORE THAN 2 SHIP S SHALL BE HOLD IN ANY A CHOR BOLT.
- 3. THE ANCHOR NUT SHALL BE TI HTENED AS ASSPEC, 352.0
- 4. THE TOP OF TYZ LUMINAIPE SHALL BE LEVEL AFTER ASSEMBLE
- 5. 1000W LUM NAIRE IS TYP CAL. REFLECTO TREET LIGHT OF DESIGN GRAWINGS FOR SCHIED UMINAIRE TYPE WANTAGE REQUIRED
- ANCI OR BOLTS ARE STRPLIED OF ANCHOR NUTS. WASHERS, BELL' ANCEORS AN BEVELLEUNUTS.
- 7. POLE SUPPLED C/W LUMINAIRE ARM.

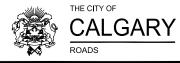


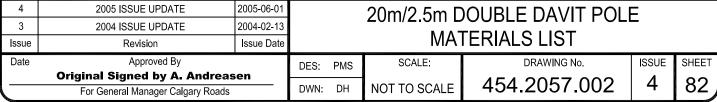


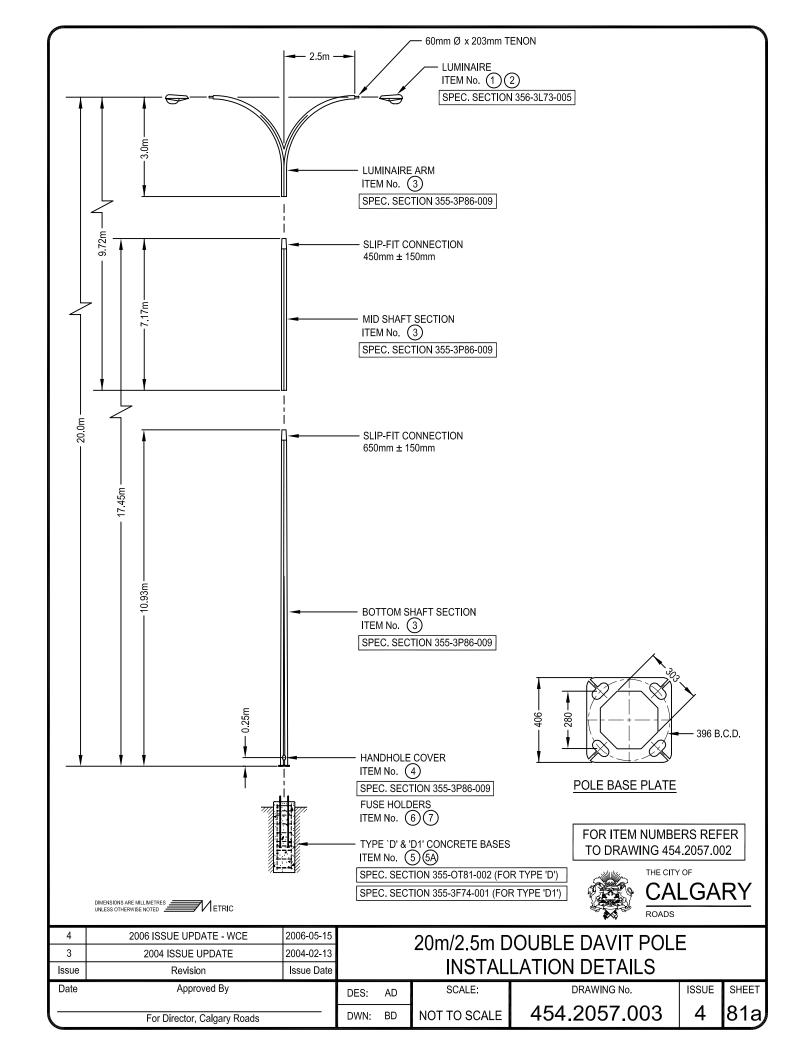



MATERIAL LIST										
ITEM	QTY	STOCK NUMBER		DESCRIPTION		SUPPLIER				
1	2	143038	LUMINAIRE - HPSV	1000W - COBRAHEAD	(SEE NOTE 5 BELOW)	ROADS				
2	2	143993	LAMP - HPSV	1000W - CLEAR	(SEE NOTE 5 BELOW)	ROADS				
3	1	SPECIAL ORDER	POLE - GALVANIZED	20m x 2.5m - DOUBLE DAVIT		ROADS				
4	1	151819	COVER - HANDHOLE	(SUPPLIED W/POLE)		ROADS				
5	1	N/A	TYPE `D' BASE - CONCRETE POURED-IN-PLACE			CONTRACTOR				
5A	1	TBA	TYPE `D1' BASE - CONCRETE PRECAST			ROADS				
6	4	154245	FUSE HOLDER 600V	30A - INLINE		ROADS				
7	4	154247	FUSE 10A 250V	TYPE BAF - 10A		ROADS				
8										
9										
10										

- 1. WHEN ASSEMBLED THE LOWER 5 METRES OF THE POLE MUST BE PLUMB.
- 2. NO MORE THAN 2 SHIMS SHALL BE USED ON ANY ANCHOR BOLT.
- 3. THE ANCHOR NUTS SHALL BE TIGHTENED AS PER SPEC. 352.01.02.
- 4. THE TOP OF THE LUMINAIRE SHALL BE LEVEL AFTER ASSEMBLY.
- 5. 1000W LUMINAIRE IS TYPICAL. REFER TO STREET LIGHTING DESIGN DRAWINGS FOR SPECIFIC LUMINAIRE TYPE & WATTAGE REQUIRED.
- 6. ANCHOR BOLTS ARE SUPPLIED C/W ANCHOR NUTS, WASHERS, BELL ANCHORS AND BEVELLED NUTS.
- 7. POLE IS SUPPLIED C/W LUMINAIRE ARM.

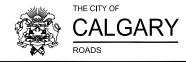

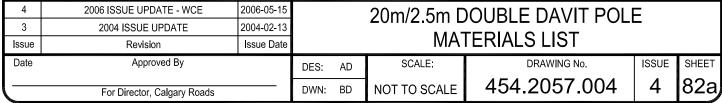

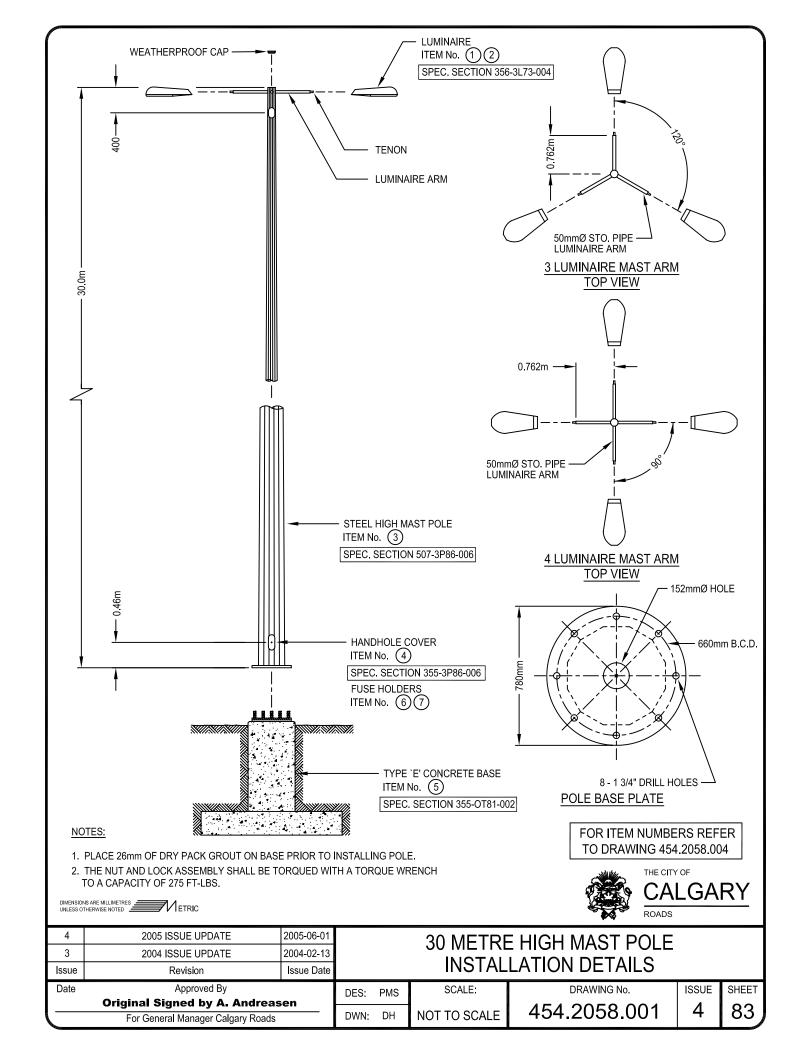

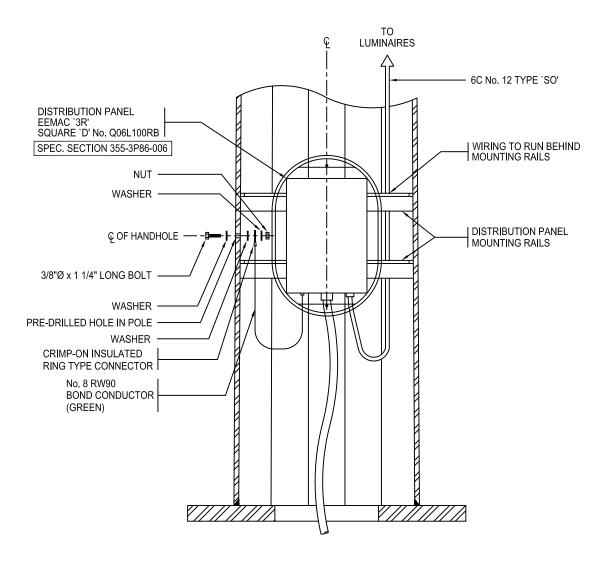


**DISTRIBUTION PANEL WIRING** 






4	2006 ISSUE UPDATE - WCE	2006-05-15			30 METR	E HIGH MAST POLE			
3	2004 ISSUE UPDATE	2004-02-13	\ \ / /   [						
Issue	Revision	Issue Date	WIRING DETAILS (OLD INSTALLATIONS ONLY						
Date	Approved By		DES:	AD	SCALE:	DRAWING No.	ISSUE	SHEET	
			DWN:			454.2058.002	1	84	
	For Director, Calgary Roads			BD	NOT TO SCALE	434.2030.002		04	

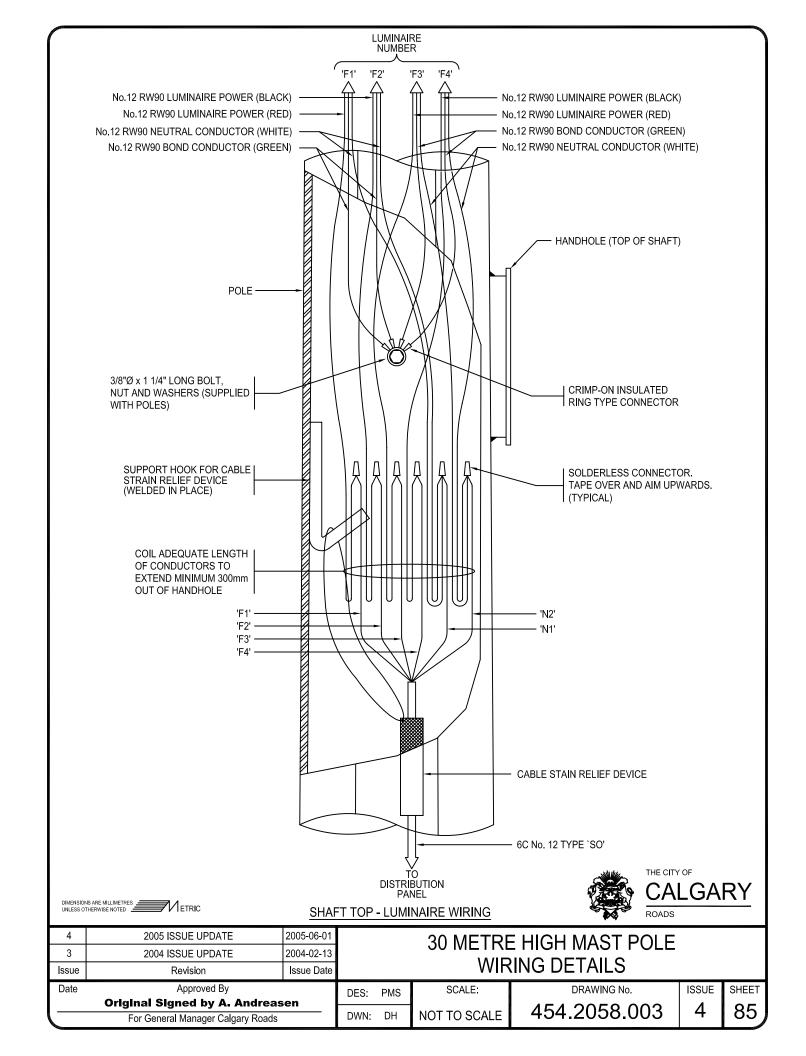


			MATER	AL LIST							
ITEM	QTY	STOCK NUMBER		DESCRIPTION							
1	4	158856	LUMINAIRE - HPSV	400W - COBRAHEAD	(SEE NOTE 5 BELOW)	ROADS					
2	4	143992	LAMP - HPSV	400W - CLEAR	(SEE NOTE 5 BELOW)	ROADS					
3	1	155240	POLE - GALVANIZED	30m - HIGH MAST		ROADS					
4	1	N/A	COVER - HANDHOLE	(SUPPLIED W/POLE)		ROADS					
5	1	N/A	TYPE 'E' BASE - CONCR	ETE POURED-IN-PLACE		CONTRACTOR					
6	1	SPECIAL ORDER	DISTRIBUTION PANEL			ROADS					
7											
8											
9											
10											
11											

# NOTES:

- 1. WHEN ASSEMBLED THE LOWER 5 METRES OF THE POLE MUST BE PLUMB.
- 2. NO MORE THAN 2 SHIMS SHALL BE USED ON ANY ANCHOR BOLT.
- 3. THE ANCHOR NUTS SHALL BE TIGHTENED AS PER SPEC. 352.01.02.
- 4. THE TOP OF THE LUMINAIRE SHALL BE LEVEL AFTER ASSEMBLY.
- 5. 1000W FLAT LENS LUMINAIRE IS TYPICAL. REFER TO STREET LIGHTING DESIGN DRAWINGS FOR SPECIFIC LUMINAIRE TYPE & WATTAGE REQUIRED.
- 6. ANCHOR BOLTS ARE SUPPLIED C/W ANCHOR NUTS, WASHERS, BELL ANCHORS AND BEVELLED NUTS.
- 7. POLE IS SUPPLIED C/W WEATHERPROOF TOP CAP AND LUMINAIRE ARMS.

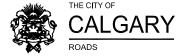

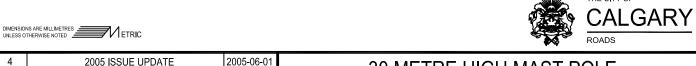

	For General Manager Calgary Roads		DWN:	DH	NOT TO SCALE	454.2058.004	4	86	
	Original Signed by A. Andreasen					151 2050 001	1 1	06	
Date	Approved By		DES:	PMS	SCALE:	DRAWING No.	ISSUE	SHEET	
Issue	Revision	Issue Date		MATERIALS LIST					
3	2004 ISSUE UPDATE	2004-02-13							
4	2005 ISSUE UPDATE	2005-06-01		30 METRE HIGH MAST POLE					








4	2005 ISSUE UPDATE	2005-06-01	30	ME	RE HIGH M	IAST POLE (RAISE/L	∩\//F	-R)	
3	2004 ISSUE UPDATE	2004-02-13	00	30 METRE HIGH MAST POLE (RAISE/LOWER) INSTALLATION DETAILS					
Issue	Revision	Issue Date							
Date	Approved By		DES:	PMS	SCALE:	DRAWING No.	ISSUE	SHEET	
	Original Signed by A. Andreasen					454 2050 004	1 1	07	
	For General Manager Calgary Roads			DH	NOT TO SCALE	454.2059.001	4	01	





4	2005 ISSUE UPDATE	2005-06-01	30	30 METRE HIGH MAST POLE (RAISE/LOWER)						
3	2004 ISSUE UPDATE	2004-02-13	00							
Issue	Revision	Issue Date		DEVICE DETAILS						
Date	Approved By		DES:	PMS	SCALE:	DRAWING No.	ISSUE	SHEET		
	Original Signed by A. Andreasen		DWN:			454 2050 002	1	00		
<u></u>	For General Manager Calgary Roads			DH	NOT TO SCALE	454.2059.002	+	00		

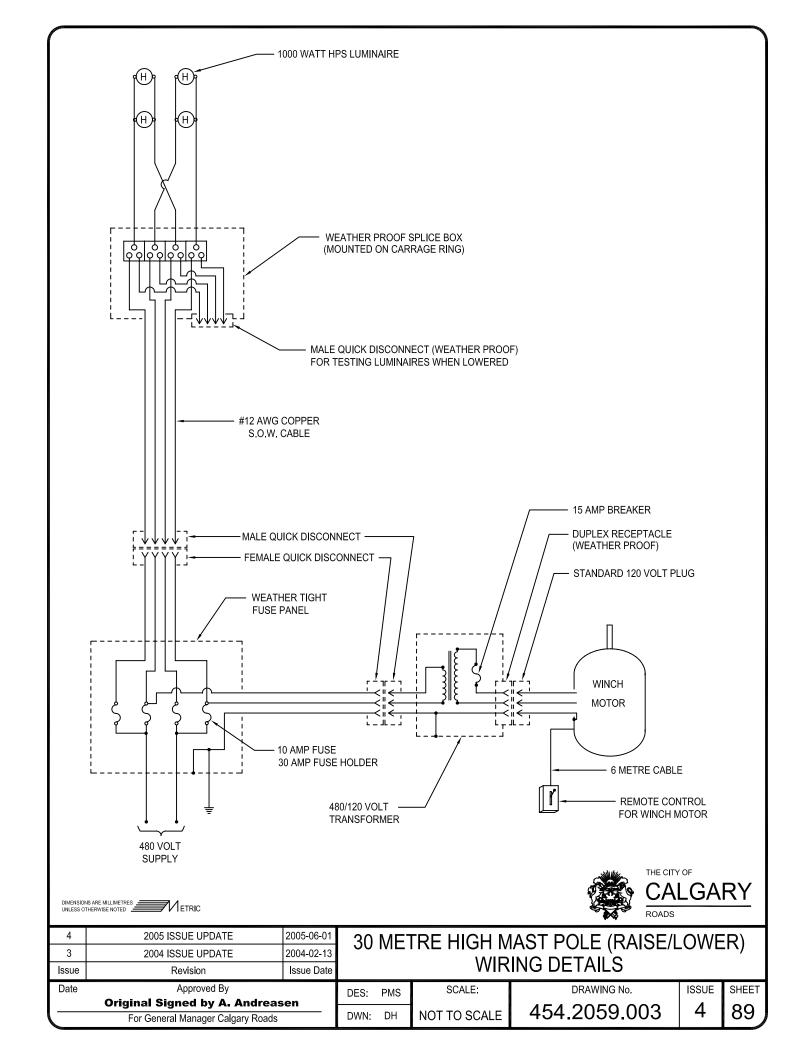








4	2005 ISSUE UPDATE	2005-06-01	30	30 METRE HIGH MAST POLE (RAISE/LOWER)						
3	2004 ISSUE UPDATE	2004-02-13	00							
Issue	Revision	Issue Date		MATERIALS LIST						
Date	Approved By		DES:	PMS	SCALE:	DRAWING No.	ISSUE	SHEET		
	Original Signed by A. Andreasen		DWN:			454.2059.004	1	00		
	For General Manager Calgary Roads			DH	NOT TO SCALE	434.2039.004	_	90		

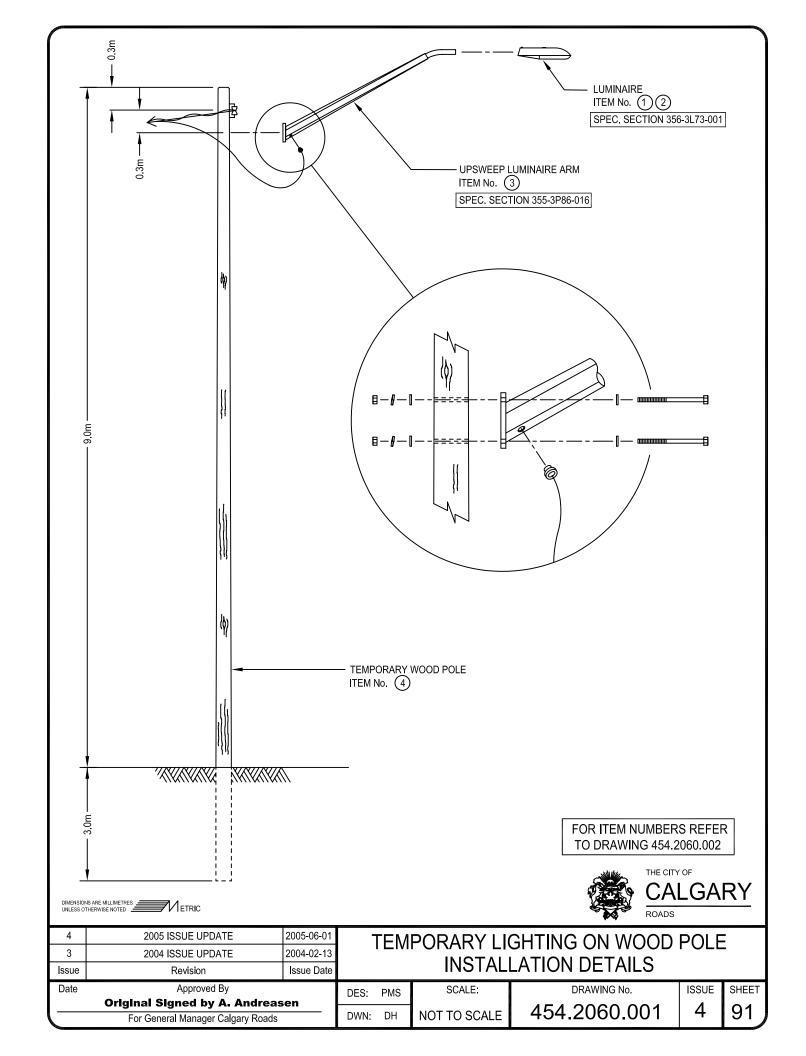

			MATERIAL LIST	
ITEM	QTY	STOCK NUMBER	DESCRIPTION	SUPPLIER
1	1	158573	LUMINAIRE - HPSV 150W - COBRAHEAD FLAT LENS	ROADS
2	1	143989	LAMP - HPSV 150W	ROADS
3	1	151364	UPSWEEP LUMINAIRE ARM W/ MOUNTING HARDWARE	ROADS
4	1	N/A	WOOD POLE 12m CLASS-3	CONTRACTOR
5				
6				
7				
8				
9				
10				
11				

# NOTES:

- 1. WHEN ASSEMBLED THE LOWER 5 METRES OF THE POLE MUST BE PLUMB.
- 2. NO MORE THAN 2 SHIMS SHALL BE USED ON ANY ANCHOR BOLT.
- 3. THE ANCHOR NUTS SHALL BE TIGHTENED AS PER SPEC. 352.01.02.




4	2005 ISSUE UPDATE	2005-06-01	-	TEMPORARY LIGHTING ON WOOD POLE					
3	2004 ISSUE UPDATE	2004-02-13							
Issue	Revision	Issue Date		MATERIALS LIST					
Date	Approved By		DES:	PMS	SCALE:	DRAWING No.	ISSUE	SHEET	
	Original Signed by A. Andreasen		DWN:			454.2060.002	<sub>1</sub>	വ	
	For General Manager Calgary Roads			DH	NOT TO SCALE	454.2000.002	+	32	

I.D. TAG DESIGNATIONS	CO	NDUCTOR COL	OUR CODING	)	
		1Ø CIRCUITS	A and C	RED	
LUM. CCTS. (A, B, ETC.)	LUMINAIRE	16 CIRCUITS	B and D	BLACK	
	CIRCUITS		A,D and G	RED	
	55	3Ø CIRCUITS	B,E and H	BLACK	
			C,F and I	BLUE	
P.E.C.	PHOTOELECTRIC	SWITCH LEG	RED		
	CELL	POWER	BLACK		
	NEUTRAL	WHITE			
	GROUND	GREEN			


### **NOTES**

- 1. SEE STANDARD SPECIFICATIONS & SPECIAL PROVISIONS FOR ADDITIONAL INFORMATION.
- CONDUCTORS SHALL BE IDENTIFIED IN ALL JUNCTION BOXES AND AT ALL ACCESS POINTS. IDENTIFICATION SHALL BE MADE USING TY-RAP IDENTIFICATION TAGS (T&B TY5532 OR APPROVED ALTERNATE) INDICATING PHASES. TAGS SHALL BE CLEARLY MARKED WITH A BLACK INDELIBLE PEN.



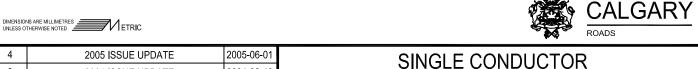

For General Manager Calgary Roads			DWN:	DH	NOT TO SCALE	454.2065.001	4	93		
	Original Signed by A. Andreasen					454 0005 004	<sub>1</sub>	١٨٨		
Date	Approved By		DES:	PMS	SCALE:	DRAWING No.	ISSUE	SHEET		
Issue	Revision	Issue Date		COLOUR CODING						
3	2004 ISSUE UPDATE	2004-02-13								
4	2005 ISSUE UPDATE	2005-06-01		SINGLE CONDUCTOR						

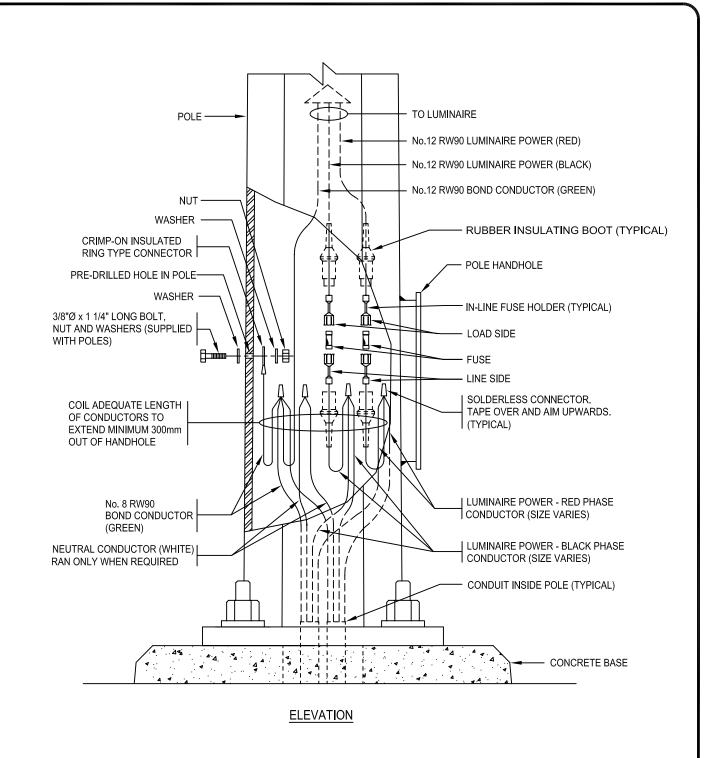


### **NOTES**

- REFER TO CONTRACT DRAWINGS AND DETAILED SPECIFICATIONS.
- 2. FUSE INSTALLATION IN JUNCTION BOXES SIMILAR.





4	2005 ISSUE UPDATE	2005-06-01		LUMINAIRE WIRING					
3	2004 ISSUE UPDATE	2004-02-13							
Issue	Revision	Issue Date		IN POLE HANDHOLE					
Date	Approved By		DES:	PMS	SCALE:	DRAWING No.	ISSUE	SHEET	
1	Original Signed by A. Andreas	sen	DWN:			454 2066 004	1	ا م	
	For General Manager Calgary Roads			DH	NOT TO SCALE	454.2066.001	🕶	94	

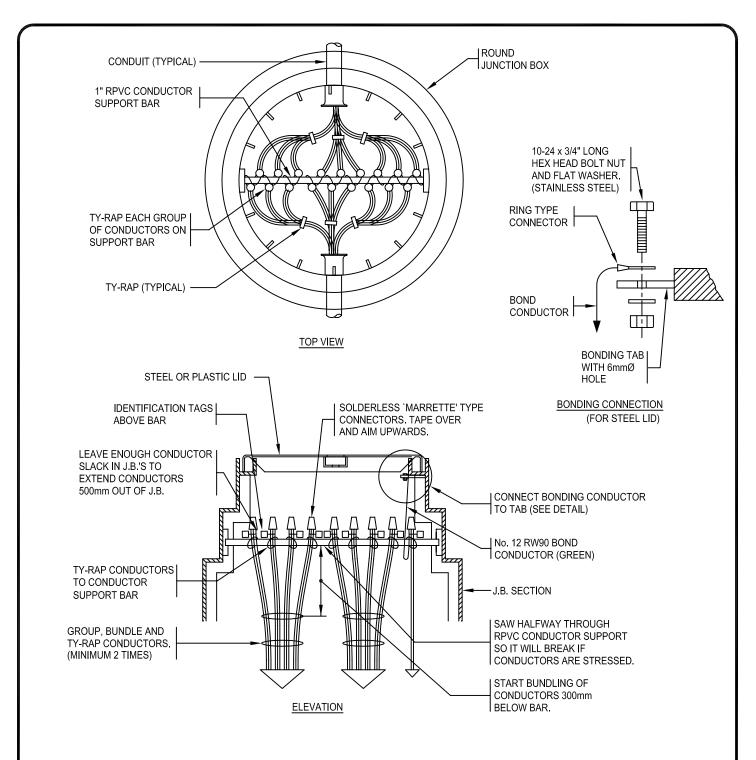


### **NOTES**


 SEE STANDARD SPECIFICATIONS & SPECIAL PROVISIONS FOR ADDITIONAL INFORMATION.





4	2005 ISSUE UPDATE	2005-06-01		WIRING IN ROUND					
3	2004 ISSUE UPDATE	2004-02-13							
Issue	Revision	Issue Date		PLASTIC JUNCTION BOXES					
Date	Approved By		DES:	PMS	SCALE:	DRAWING No.	ISSUE	SHEET	
	Original Signed by A. Andreasen				ł	454 2067 004	1	05	
	For General Manager Calgary Roads			DH	NOT TO SCALE	454.2067.001	4	95	

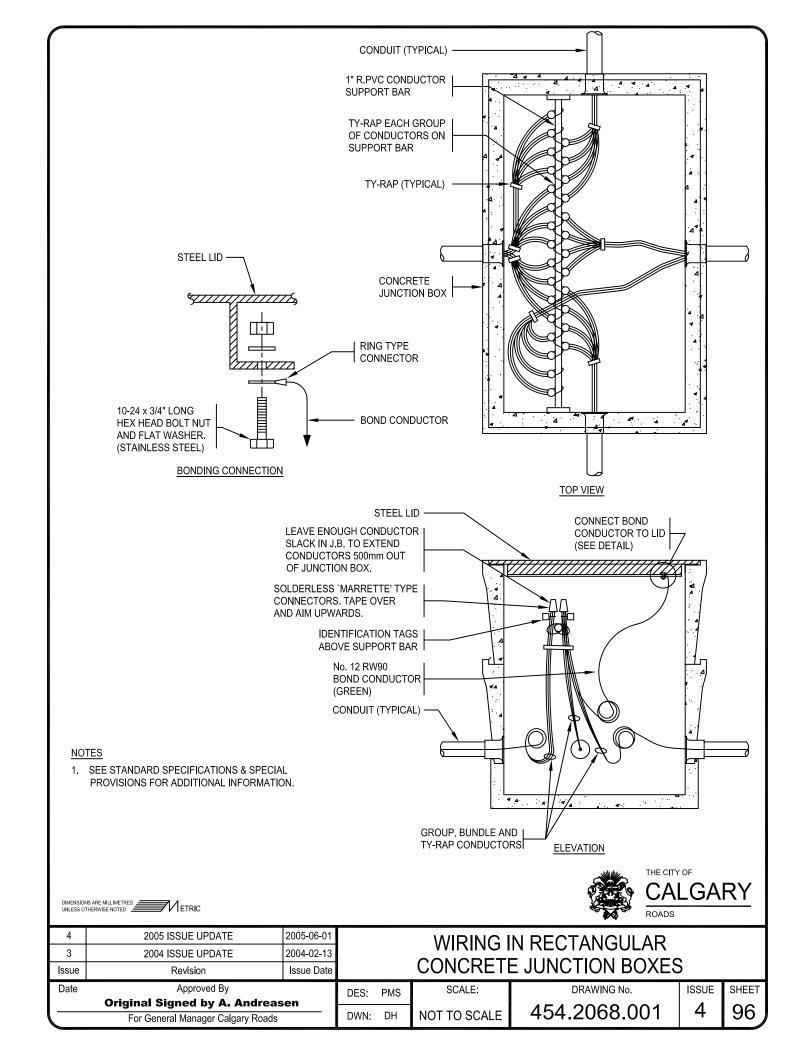


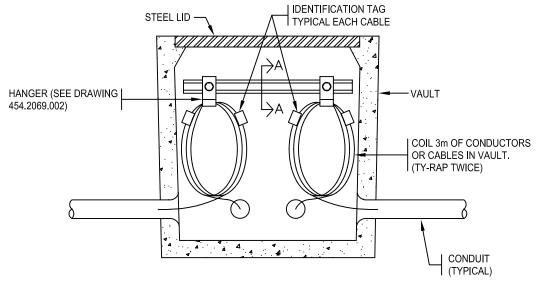

DETAIL OF CONDUCTORS OR

CABLES IN VAULTS

(TYPICAL 2 SIDES OF VAULT)

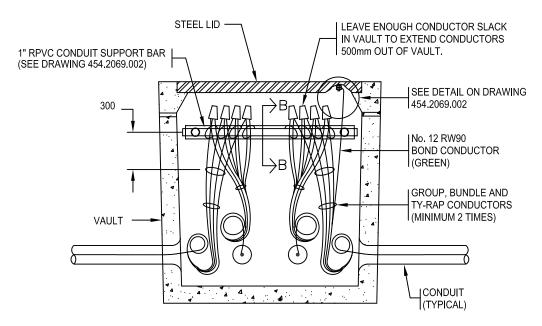

# DETAIL OF CONDUCTOR SPLICES IN VAULTS (TYPICAL 2 SIDES OF VAULT)


## <u>NOTES</u>


- SEE STANDARD SPECIFICATIONS & SPECIAL PROVISIONS FOR ADDITIONAL INFORMATION.
- 2. SEE DRAWING 454.2069.002 FOR ADDITIONAL NOTES AND DETAILS.




4	2005 ISSUE UPDATE	2005-06-01
3	2004 ISSUE UPDATE	2004-02-13
Issue	Revision	Issue Date
Date	Approved By	

2004 ISSUE OF DATE 2004				CONCILL VACET	J	
Revision	Issue Date					
Approved By		DES: PMS	SCALE:	DRAWING No.	ISSUE	SHEET
For General Manager Calgary Roads			N: DH NOT TO SCALE	151 2060 001	1	07
		DWN: DH		454.2069.001   4		91)

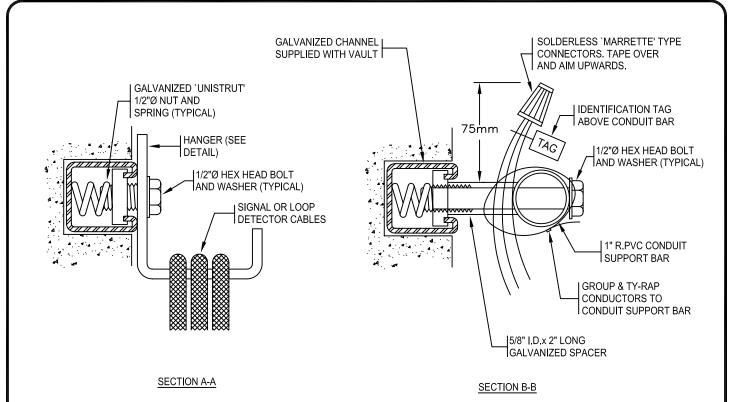

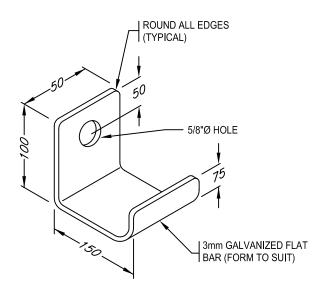


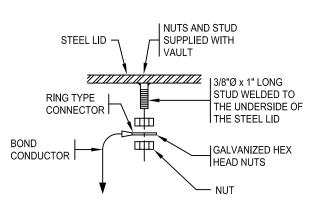


HANGER BONDING DETAIL


### NOTES

- SEE DRAWING 454,2069,001 FOR ADDITIONAL NOTES & DETAILS.
- 2. ALL BOLTS & WASHERS SHALL BE GALVANIZED.

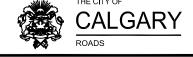


4	2005 ISSUE UPDATE	2005-06-01					_	
3	2004 ISSUE UPDATE	2004-02-13						
Issue	Revision	Issue Date						
Date	Approved By		DES:	PMS	SCALE:	DRAWING No.	ISSUE	SHEET
	Original Signed by A. Andreasen					454.2069.002	1	98
For General Manager Calgary Roads		DWN:	DH	NOT TO SCALE	434.2009.002	4	90	

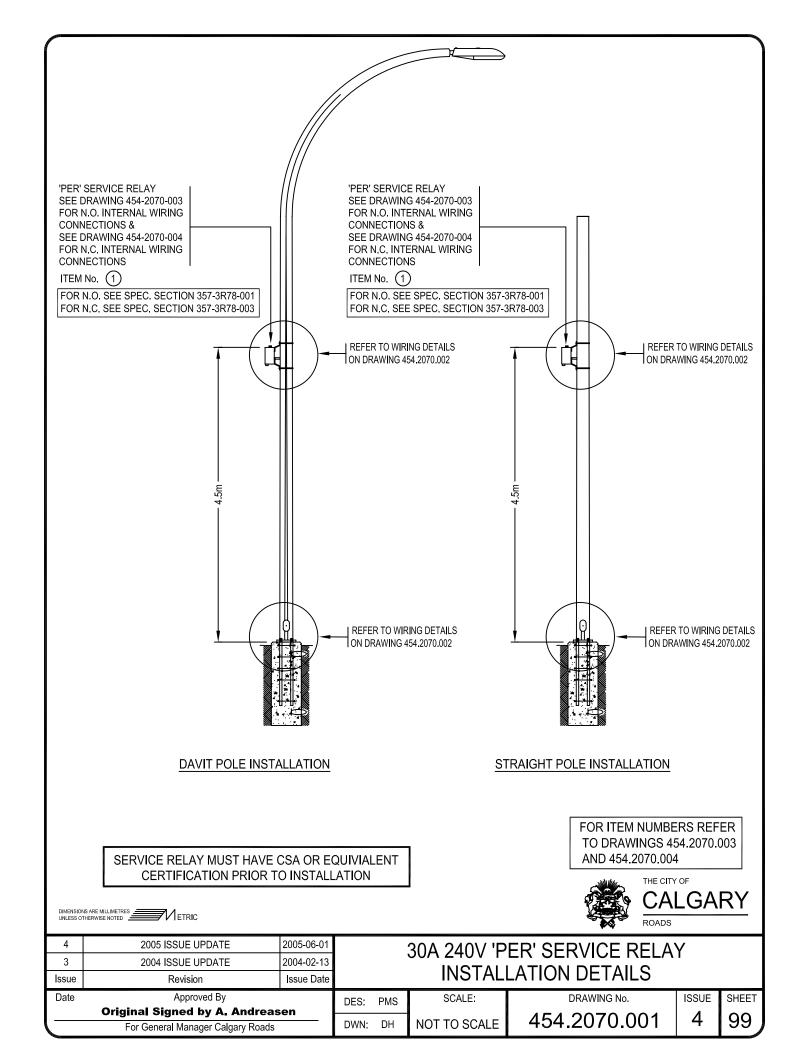

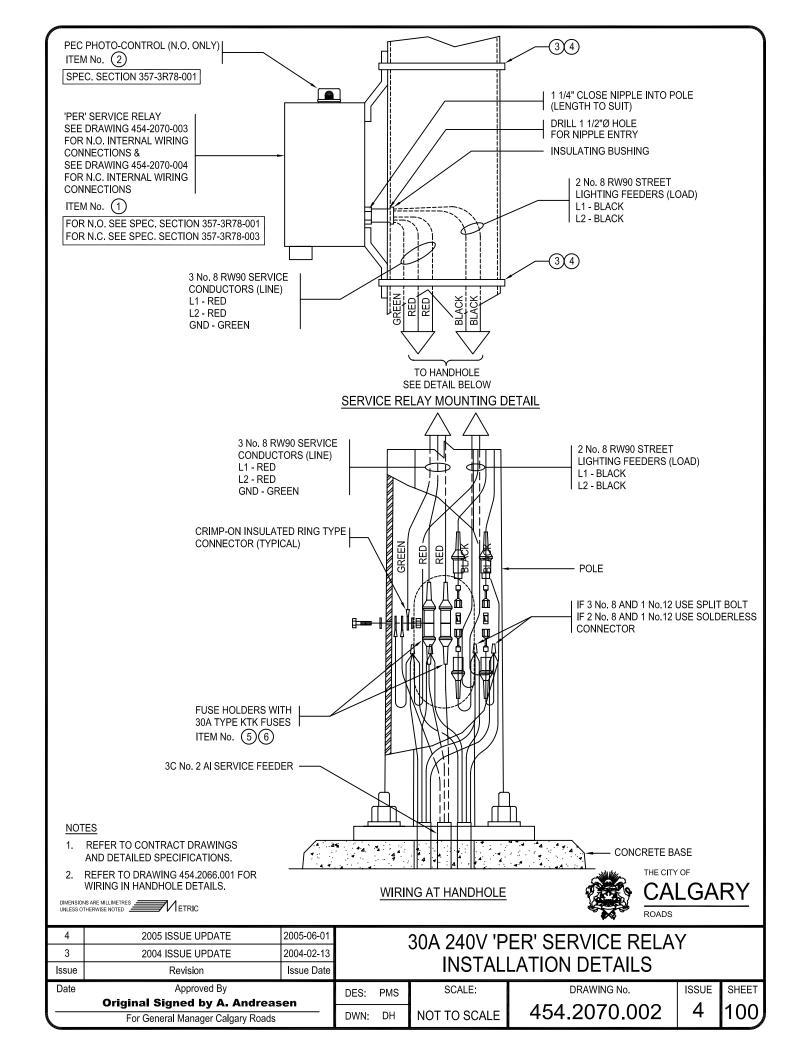

MATERIAL LIST						
ITEM	QTY	DESCRIF	PTION	CATALOGUE No.		
1	1	ENCLOSURE C/W GASKETTED DOOR	EEMAC-3R ENCLOSURE [254(H) x 254(W) x 152(D)]	N/A		
2	1	INTERMATIC INC SURGE ARRESTER	SURGE ARRESTER	AG2401C		
3	1	CUTLER-HAMMER - CONTACTOR	4 POLE, 30A CONTACTOR	CN35DN4AB *		
4	1	FUSETEK - FUSE HOLDER	2 POLE FUSE HOLDER	DF38-2 *		
5	2	LITTELFUSE - FUSE	CCMR SERIES, 30A 600V AC	CCMR-30 ★		
6	1	INTERMATIC INC PHOTOCONTROL RECEPT.	PHOTOCELL TWIST-LOCK SOCKET	K1221		
7	1	ENTRELEC TERMINAL BLOCK	18 - 6 AWG TB (3) C/W BAM END STOPS (2)	M10/10 *		
8	1	GROUND BAR KIT		N/A		
9	1	1" HIGH YELLOW REFLECTIVE BAND	3M DIAMOND GRADE	N/A		

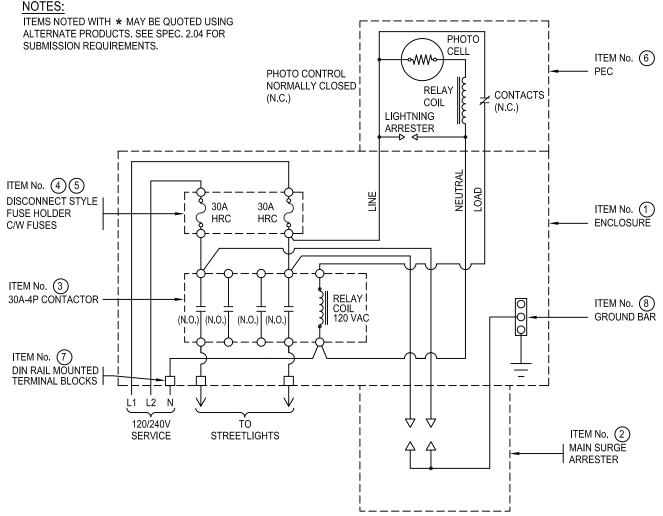

REFERENCE SPECIFICATION

357-3R78-001

DIMENSIONS ARE MILLIMETRES ETRIC

3

ssue

2005-06-01	2
2004-02-13	١
Issue Date	

30A 240V N.O. STREETLIGHT SERVICE UNIT MATERIALS LIST AND WIRING DETAILS

Date Approved By Original Signed by A. Andreasen For General Manager Calgary Roads

2005 ISSUE UPDATE

2004 ISSUE UPDATE

Revision


SCALE: DES: PMS DWN: DΗ NOT TO SCALE

DRAWING No. 454.2070.003 ISSUE SHEET 101

	MATERIAL LIST						
ITEM	QTY	DESCF	RIPTION	CATALOGUE No.			
1	1	ENCLOSURE C/W GASKETTED DOOR	EEMAC-3R ENCLOSURE	N/A			
2	1	INTERMATIC INC SURGE ARRESTER	SURGE ARRESTER	AG2401C			
3	1	CUTLER-HAMMER - CONTACTOR	4 POLE, 30A CONTACTOR	C3OCNM04A02AO			
4	2	FUSETEK - FUSE HOLDER	2 POLE FUSE HOLDER	DF38-2 *			
5	2	LITTELFUSE - FUSE	CCMR SERIES, 30A 600V AC	CCMR-30 *			
6	4	ENTRELEC TERMINAL BLOCK	18 - 6 AWG TB (4) C/W BAM END STOPS (2)	M10/10 *			
7	1	GROUND BAR KIT		N/A			
8	1	1" HIGH YELLOW REFLECTIVE BAND	3M DIAMOND GRADE	N/A			

### NOTES:

ITEMS NOTED WITH \* MAY BE QUOTED USING ALTERNATE PRODUCTS. SEE SPEC. 2.04 FOR SUBMISSION REQUIREMENTS.

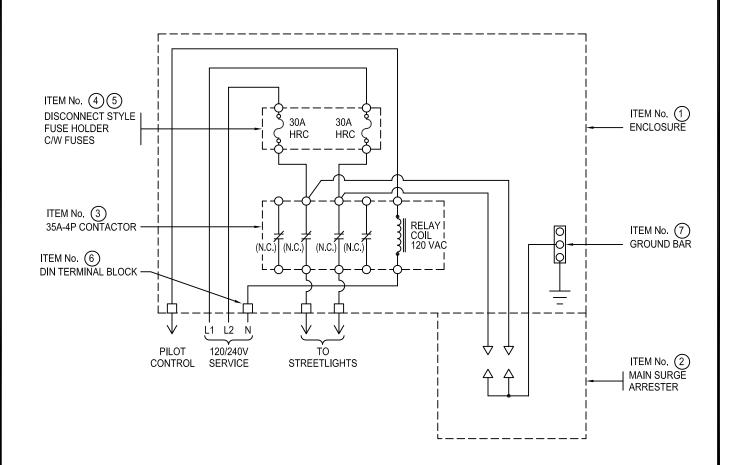



REFERENCE SPECIFICATION 3


357-3R78-003


	THE CITY OF
	CALGARY
A Ma	ROADS


4	2005 ISSUE UPDATE	2005-06-01	30	30A 240V N.C. STREETLIGHT SERVICE UNIT					
3	2004 ISSUE UPDATE	2004-02-13	3						
Issue	Revision	Issue Date	MATERIALS LIST AND WIRING DETAILS						
Date	Date Approved By		DES:	PMS	SCALE:	DRAWING No.	ISSUE	SHEET	
	Original Signed by A. Andreasen  For General Manager Calgary Roads					454 2070 004	1 1	102	
<u></u>			DWN:	DH	NOT TO SCALE	454.2070.004	+	1102	

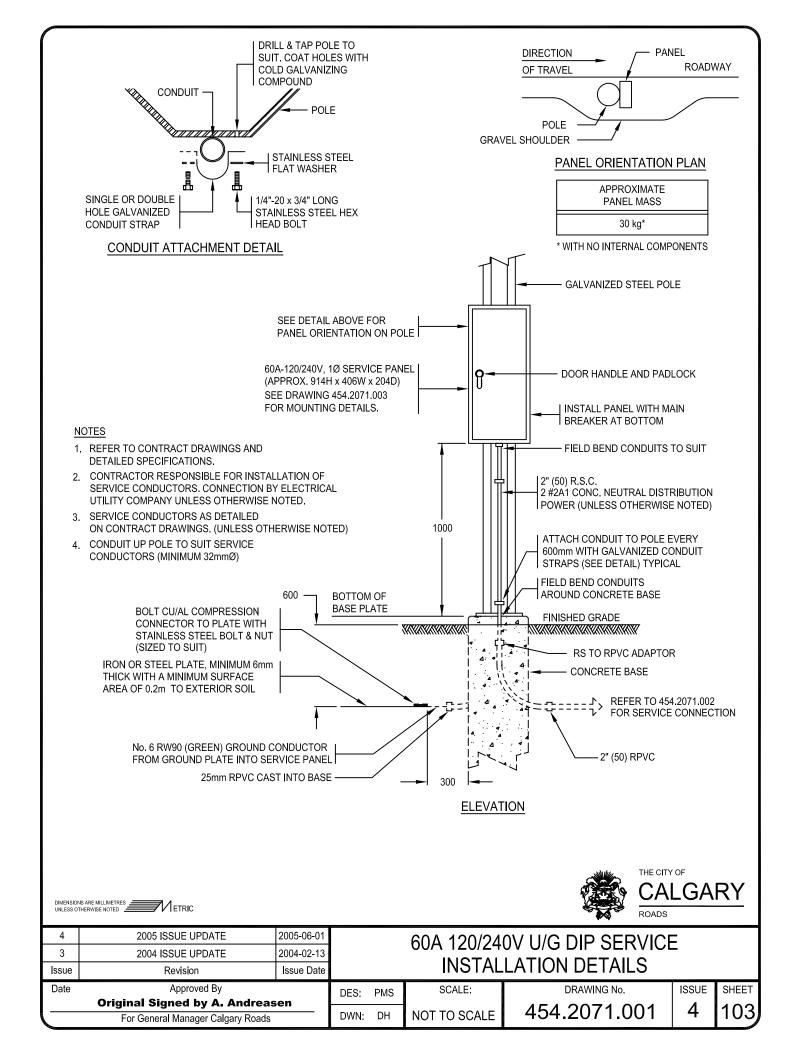


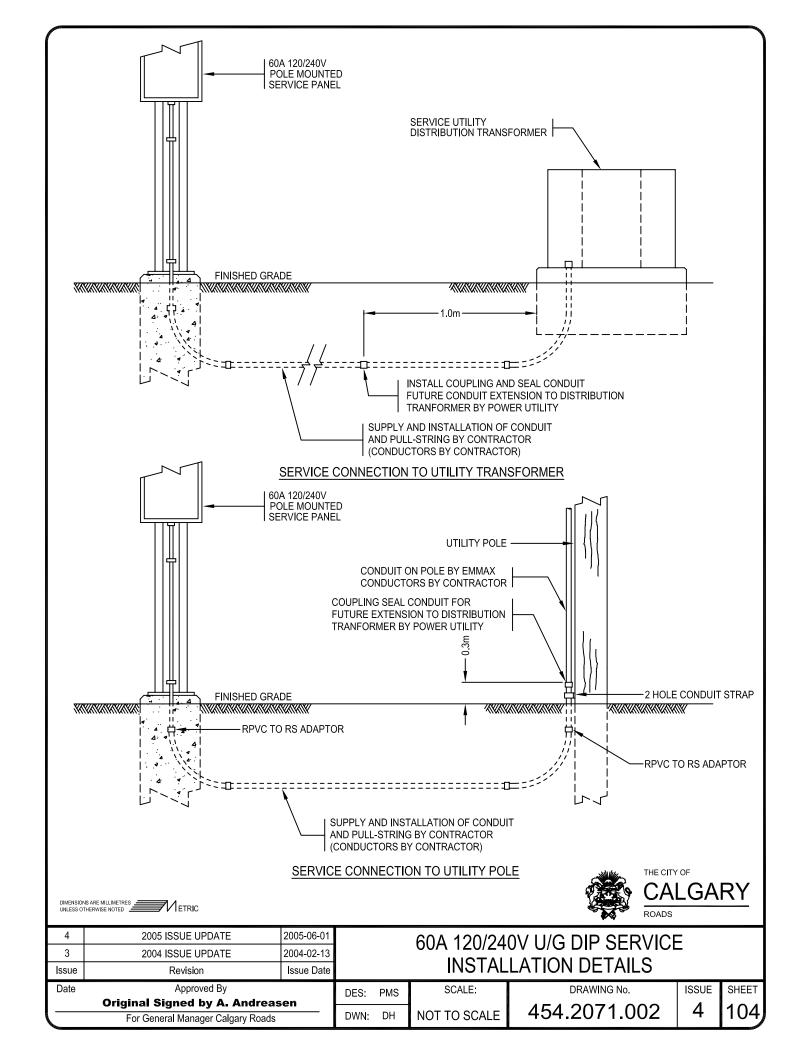


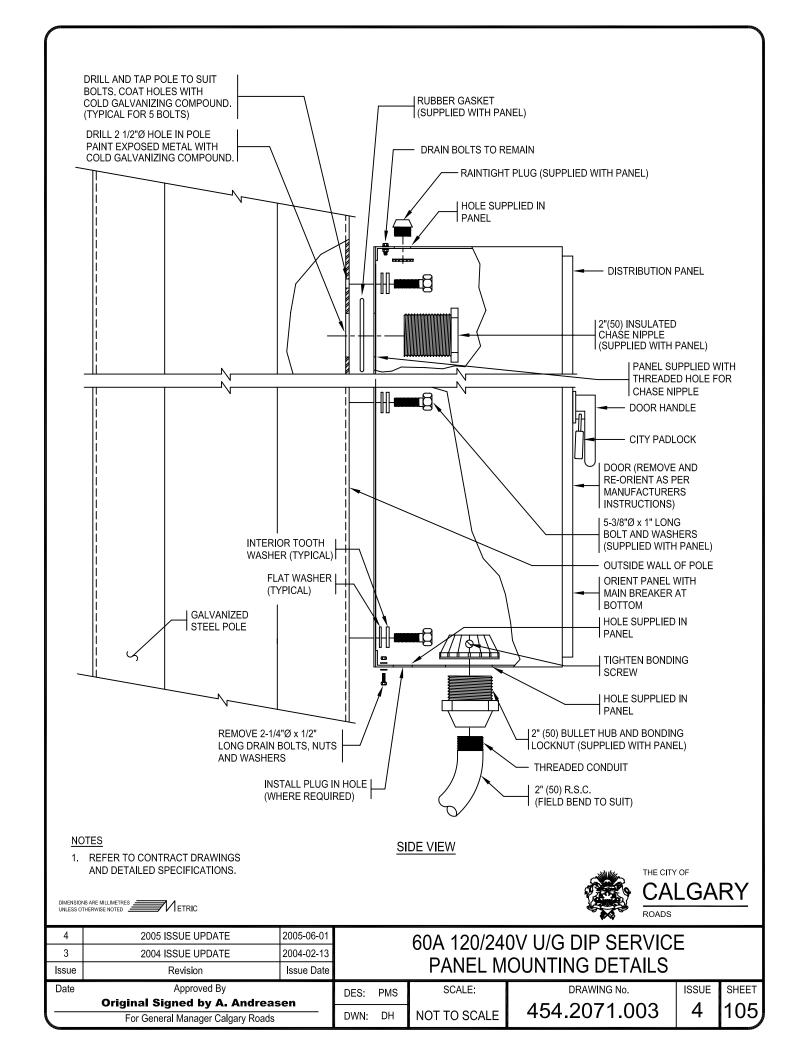


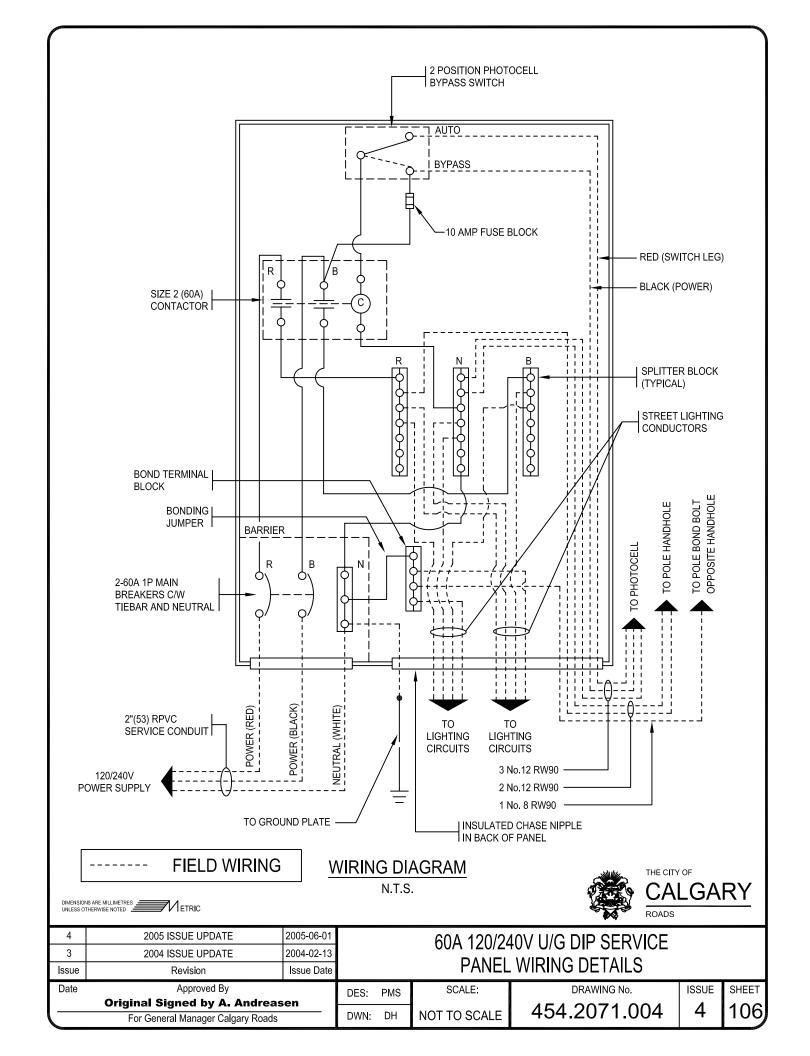


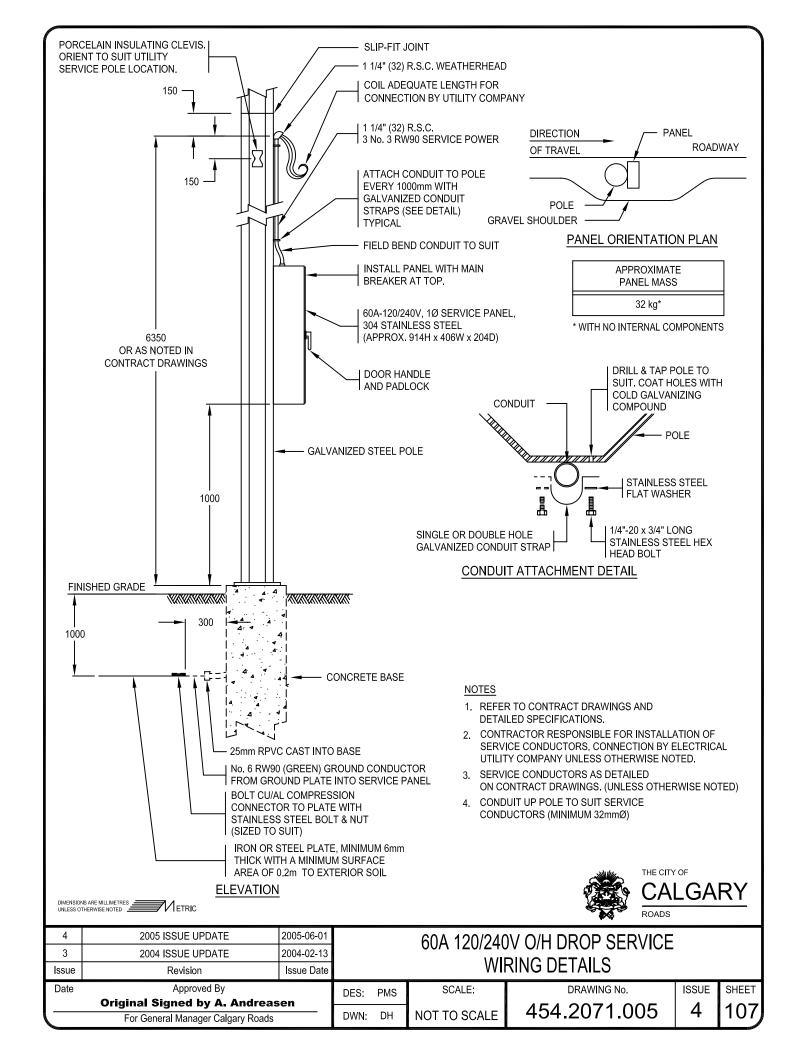


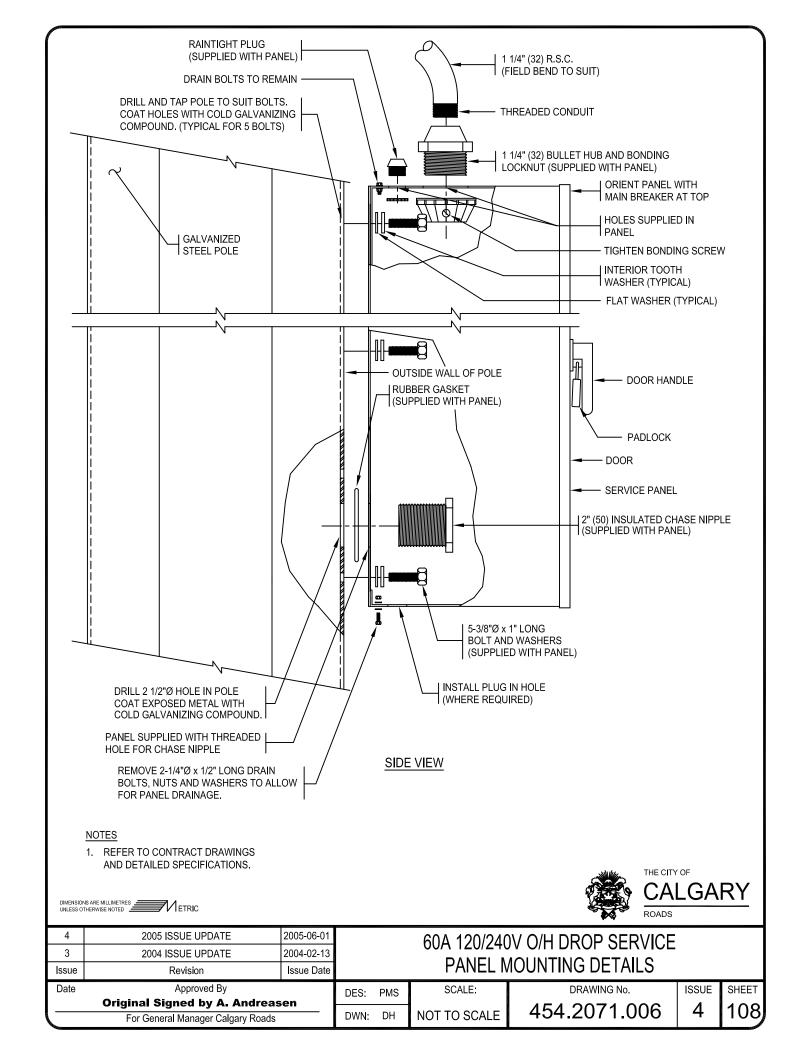


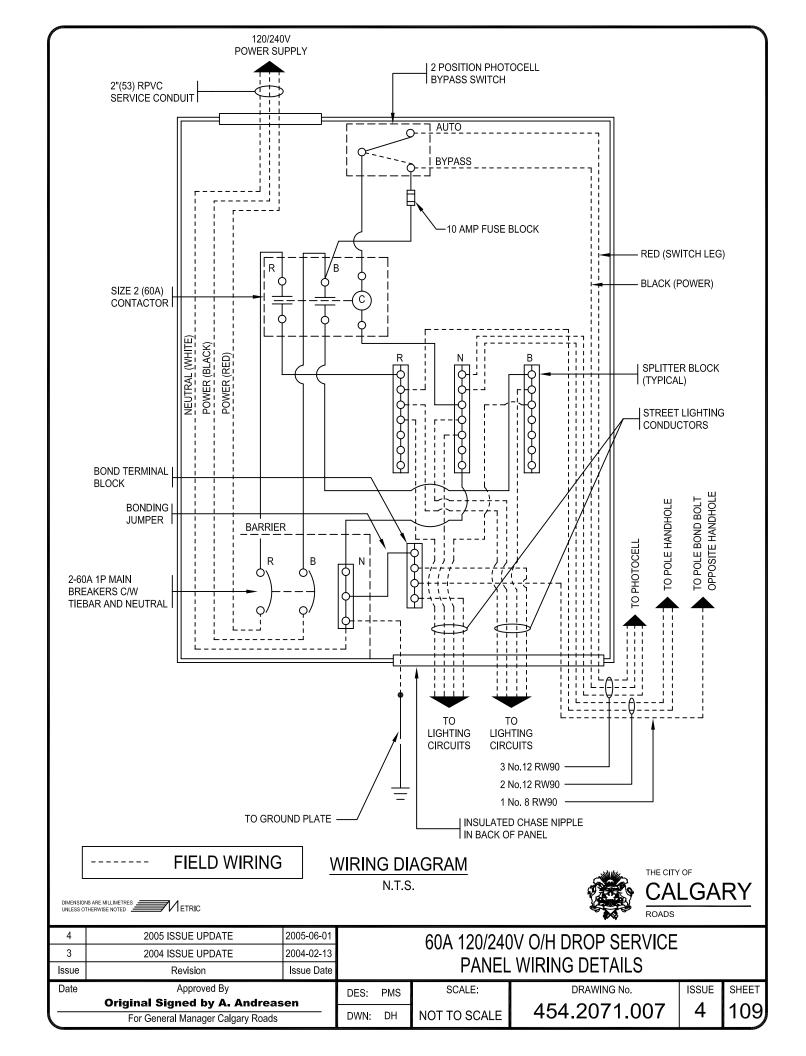


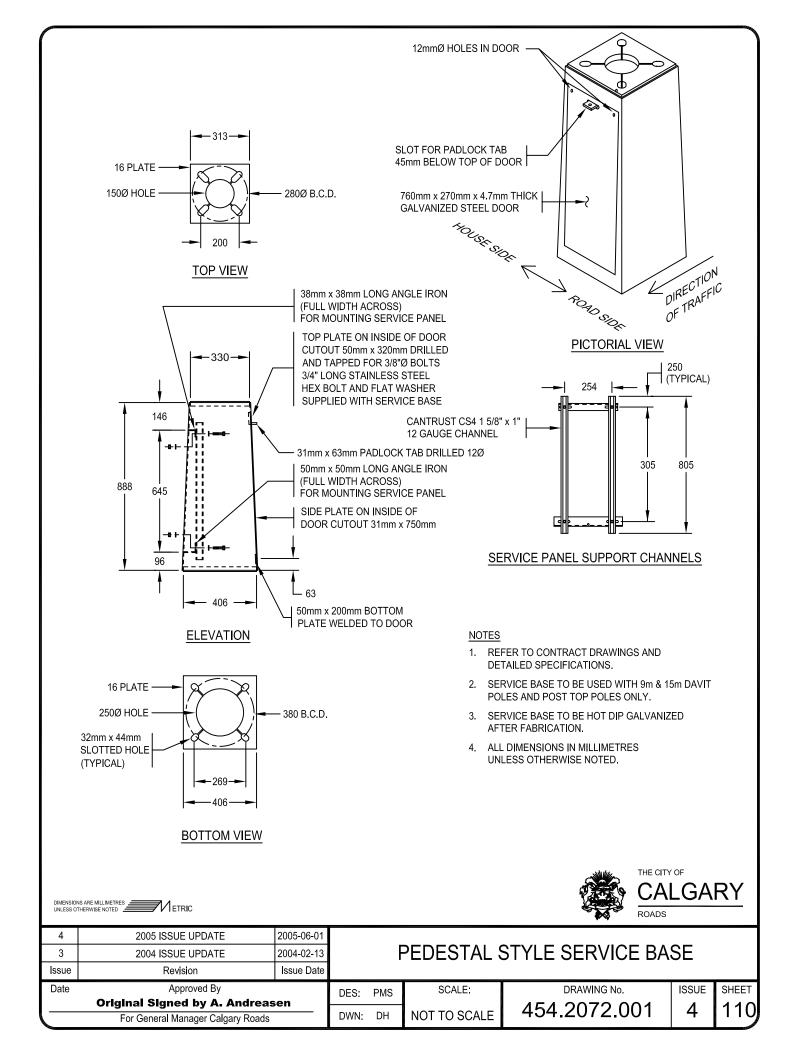


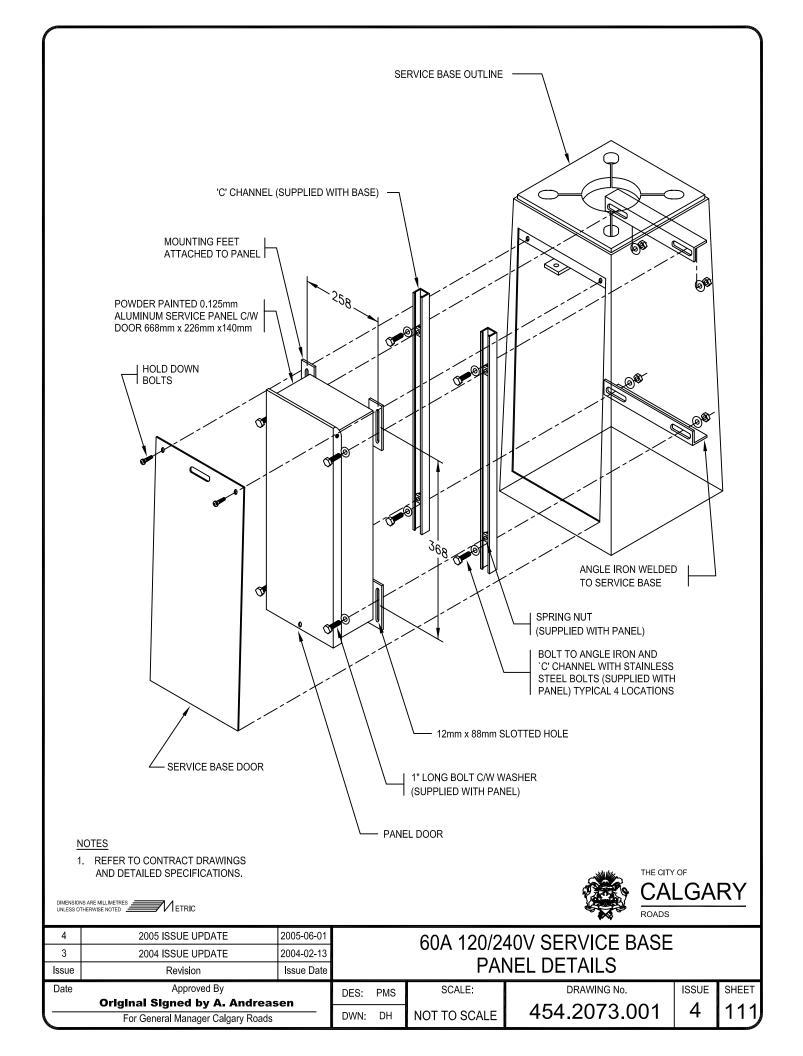


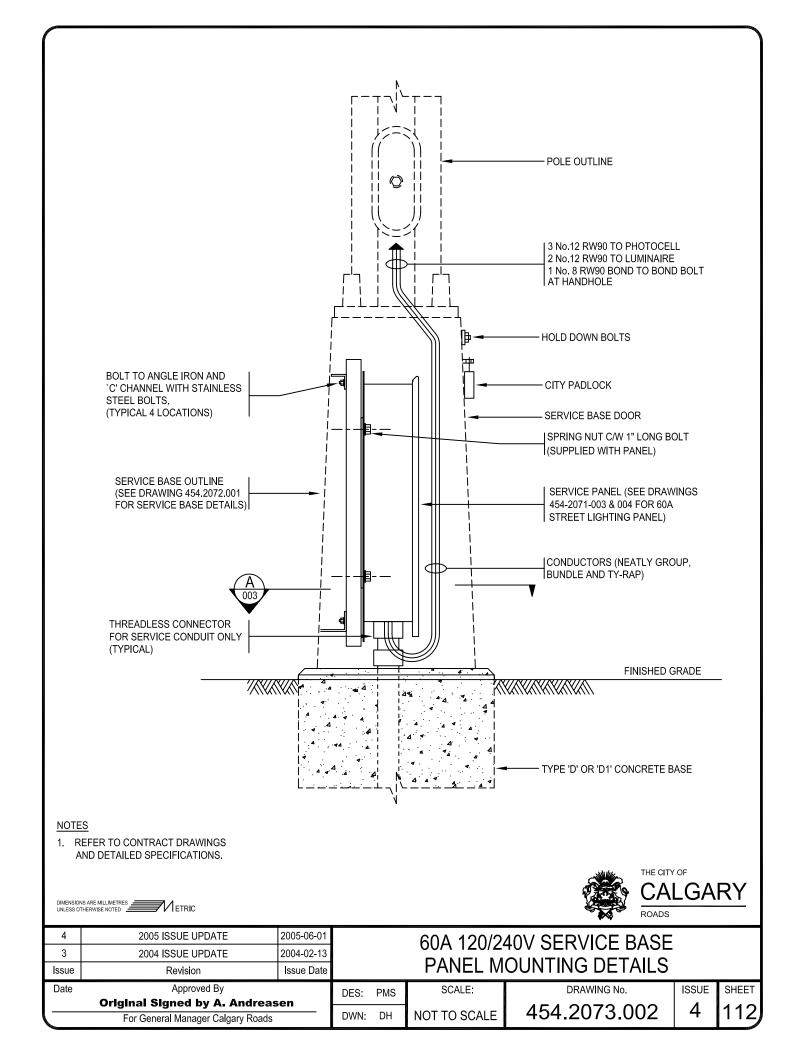


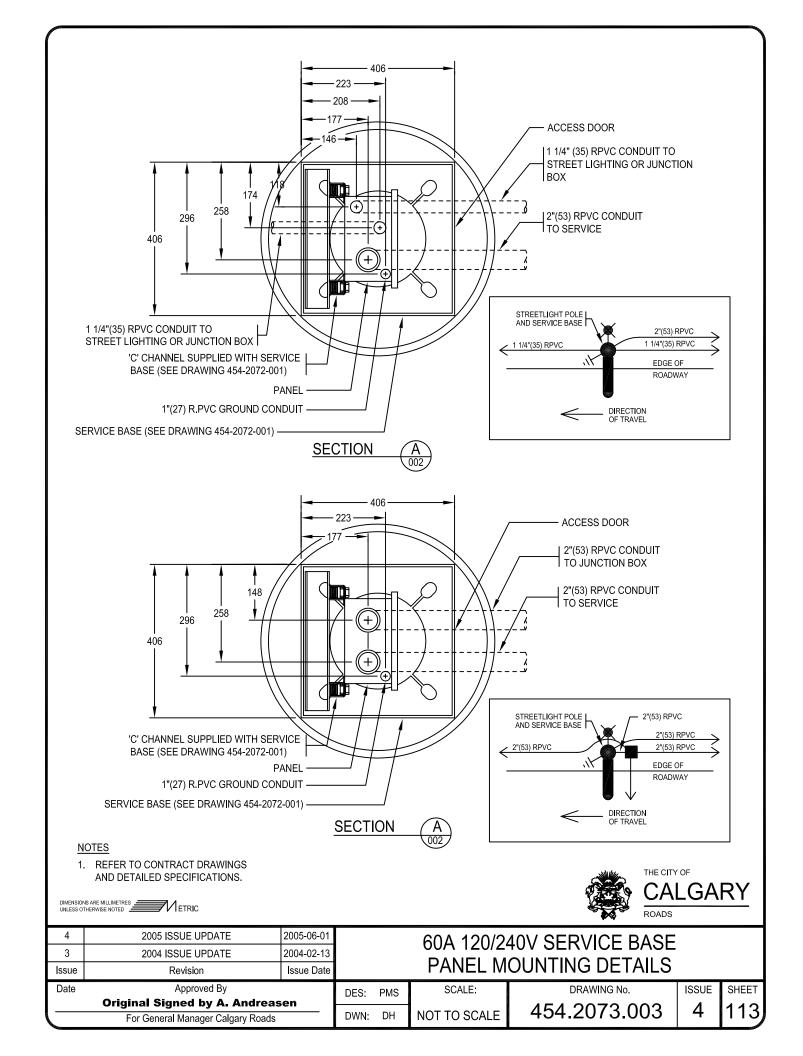

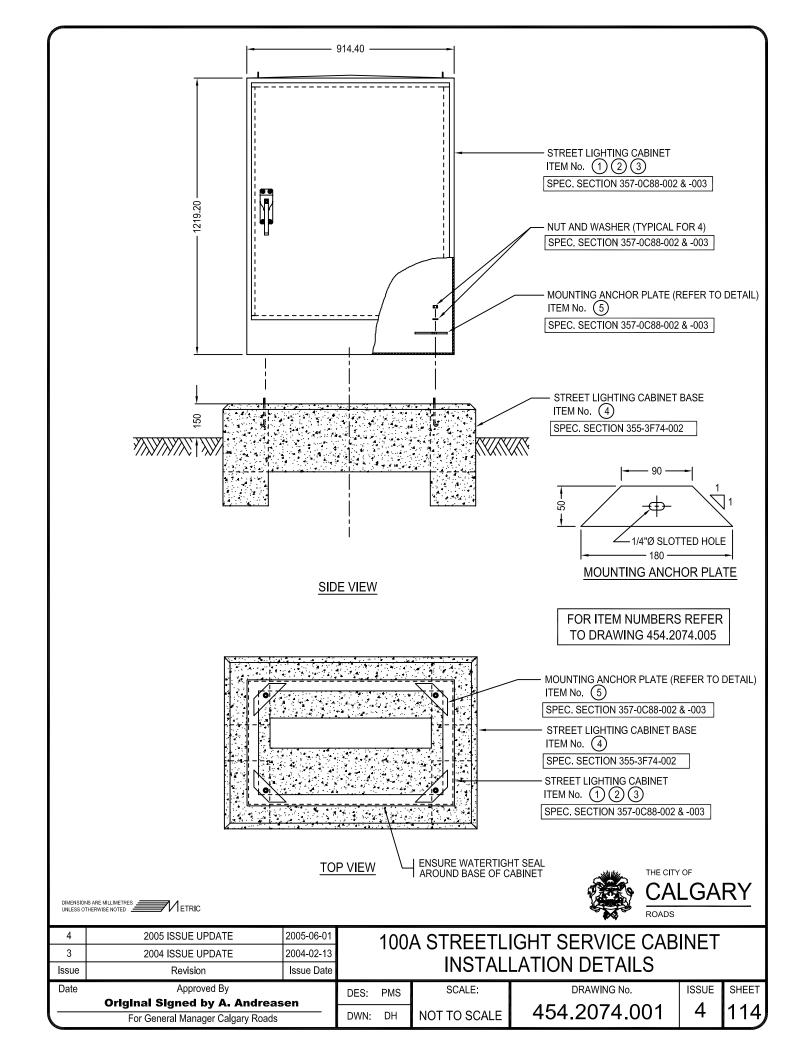

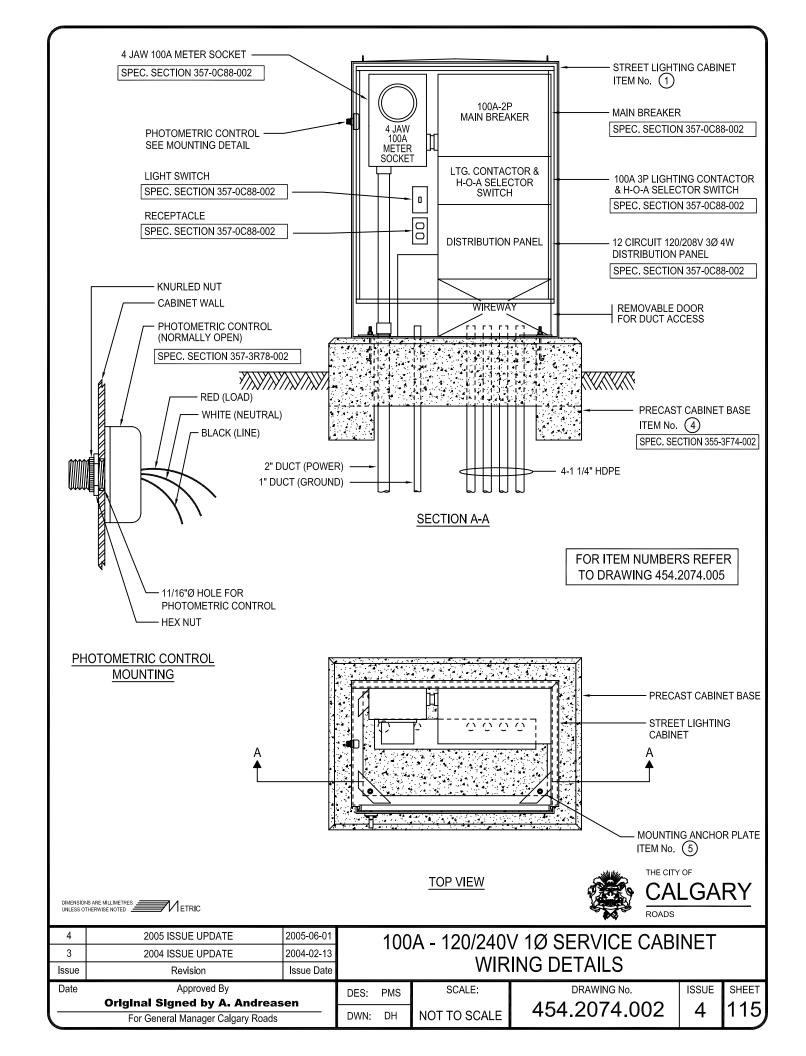

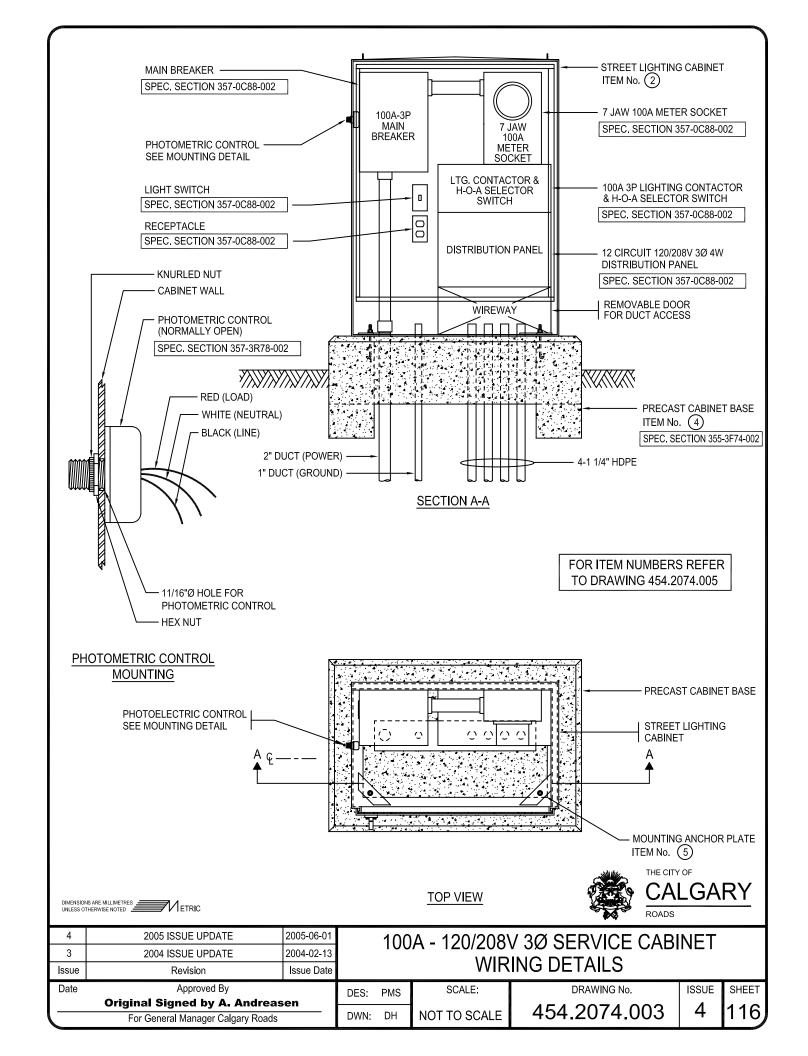

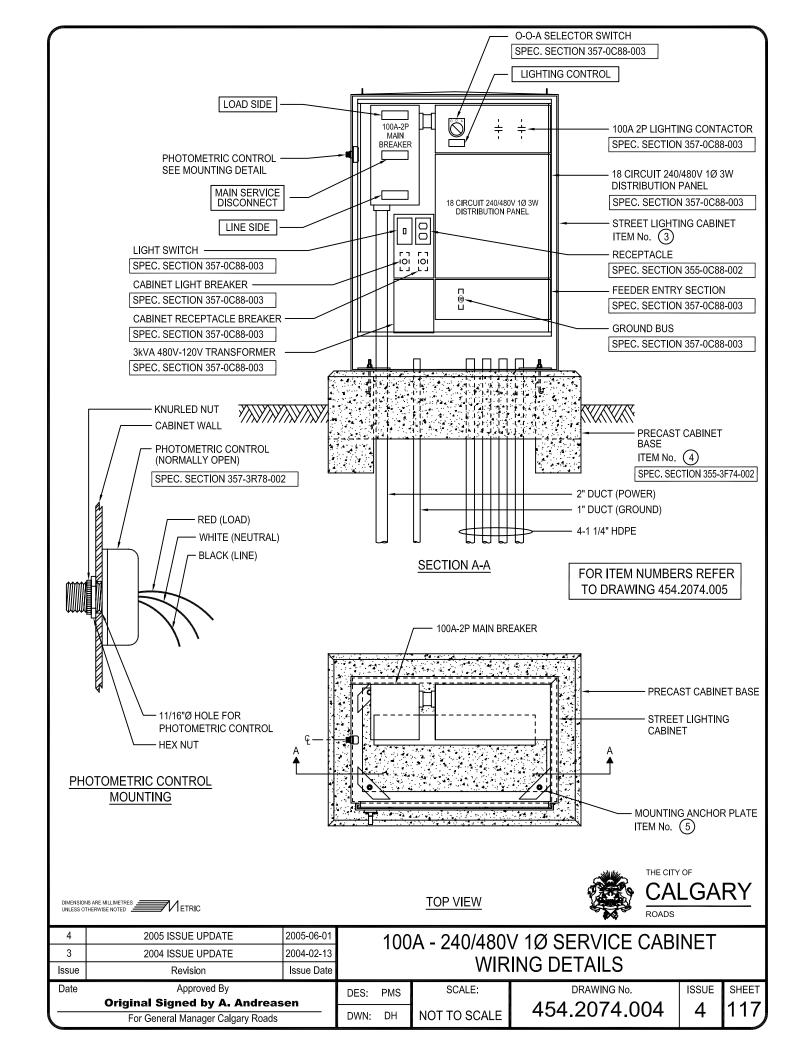


			MATERIAL LIST	
ITEM	QTY	STOCK NUMBER	DESCRIPTION	SUPPLIER
1	1	151350	STREET LIGHTING CABINET - 100A 120/240V 1Ø	ROADS
2	1	151350	STREET LIGHTING CABINET - 100A 120/208V 3Ø	ROADS
3	1	151350	STREET LIGHTING CABINET - 100A 240/480V 1Ø	ROADS
4	1	139573	PRECAST STREET LIGHTING CABINET BASE	ROADS
5	4	-	MOUNTING ANCHOR PLATE - SUPPLIED WITH CABINET	_
6				
7				
8				
9				
10				
11				




3 2004 ISSUE UPDATE 2004-02-13
100/

100A STREETLIGHT SERVICE CABINET
MATERIALS LIST

3	2004 ISSUE UPDATE	2004-02-13	MATERIAL CLICT					
Issue	Revision	Issue Date	MATERIALS LIST					
Date	Approved By			PMS	SCALE:	DRAWING No.	ISSUE	SHEET
Original Signed by A. Andreasen						454.2074.005	1	110
For General Manager Calgary Roads			DWN:	DH	NOT TO SCALE	434.2074.003	4	

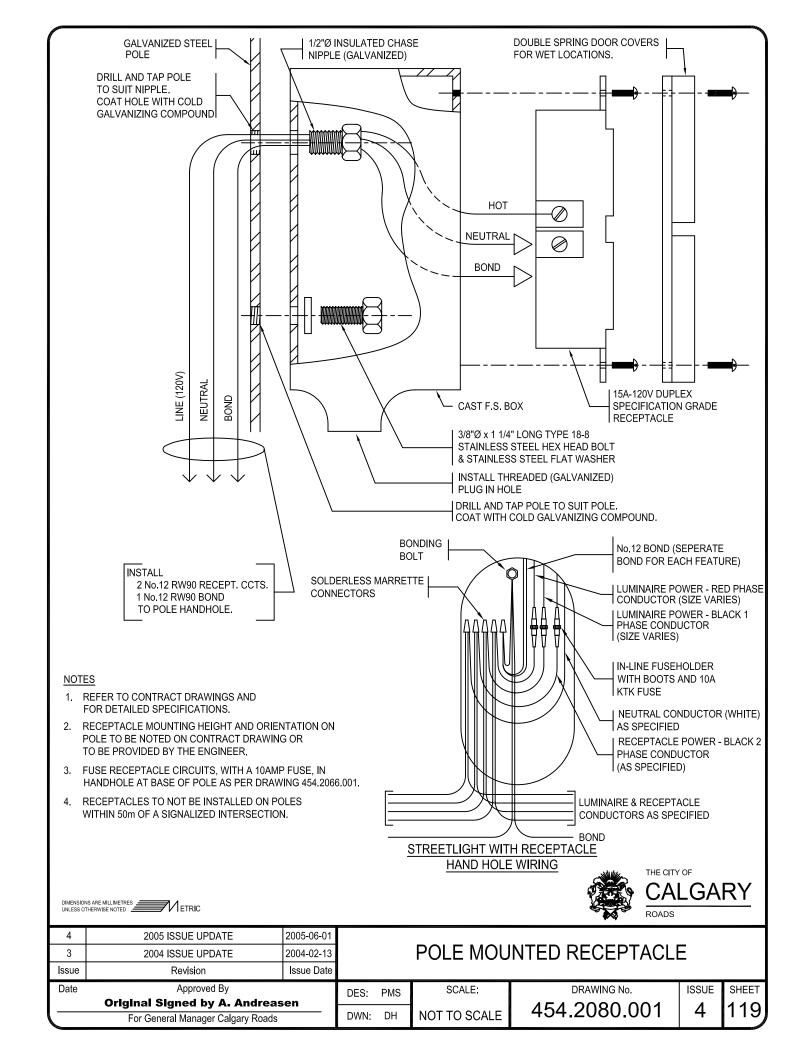

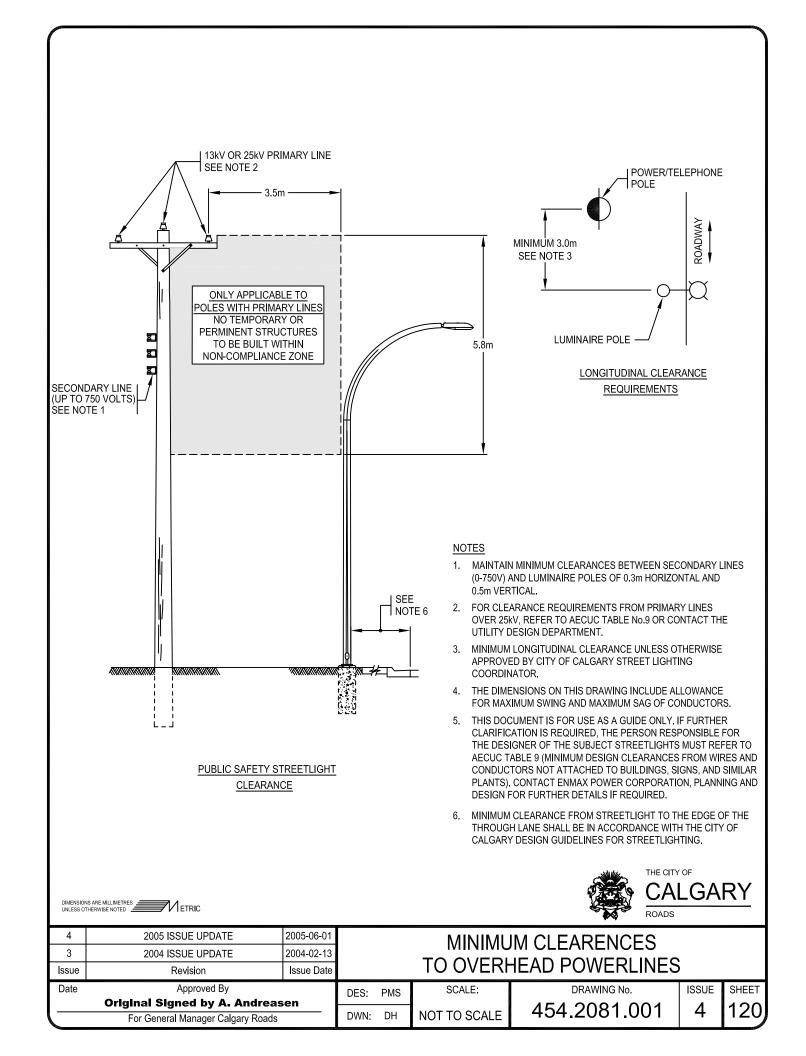

#### **APPENDIX A**

#### **CITY SUPPLIED MATERIALS**

FOR RECEIPT OF REGULAR
EMAIL UPDATES TO THE
CITY SUPPLIED MATERIALS LIST,
PLEASE CONTACT PATRICK LEE @

phone: 403-268-4513 email: patrick.lee@calgary.ca

Price List ID	Family Code	Price List Status	Price List Effective Date	Item ID	Description
P01STHRD04	STREETS	Active	2005-01-03	122068	Holder Fuse HRC 30amp RS32H
P01STHRD04	STREETS	Active	2004-01-02	138493	Nut Galvanized Hexagon No. 7
P01STHRD04	STREETS	Active	2004-01-02	138494	Nut Galvanized Lock No. 7
P01STHRD04	STREETS	Active	2004-01-02	138496	Nut Conv Thread Bevel Edge Galvanized Lock 1-1/4in x 1in
P01STHRD04	STREETS	Active	2004-01-02	138497	Nut Hexagon Conventional Thread Galvanized 1-1/4in x 3-1/2in
P01STHRD04	STREETS	Active	2004-01-02	138499	Nut Conventional Thread Bevel Edge Anchor 1-1/4in
P01STHRD04	STREETS	Active	2004-01-02	138504	Nut Galvanized Hexagon Anchor 1in
P01STHRD04	STREETS	Active	2004-01-02	138508	Nut Galvanized International Thread Lock 1-1/4in
P01STHRD04	STREETS	Active	2004-01-02	138509	Nut Galvanized International Thread Hexagon 1-1/4in
P01STHRD04	STREETS	Active	2004-01-02	138510	Nut Galvanized International Thread Anchor 1-1/4in
P01STHRD04	STREETS	Active	2004-01-02	138584	Washer Round Dywidag 2-3/4in x 1/8in x 1-1/4in Hole
P01STHRD04	STREETS	Active	2004-01-02	138585	Washer Plate Dywidag 1-1/4in 3in x 3in x 1in c/w 1-1/2in Hole
P01STHRD04	STREETS	Active	2005-01-03	139452	Shim Pole U Shape 2in x 1in Hole
P01STPOL04	STPOLES	Active	2005-01-03	139556	Pole Fiberglass Direct Buried 33ft
P01STHRD04	STREETS	Discontinued	2005-01-03	139568	Base Concrete Precast Streetlight Control Cabinet
P01STHRD04	STREETS	Discontinued	2004-01-02	139569	Base Concrete Precast Round 5m 16ft Pole
P01STHRD04	STREETS	Active	2005-01-03	139573	Base Concrete Precast Streetlight Control Cabinet
P01STHRD04	STREETS	Discontinued	2004-01-02	139574	Base Concrete Precast SL 1M RD PRECAST-RD-5M-1700-TYPE-A
P01STHRD04	STREETS	Active	2004-01-02	139575	Base Concrete Precast SL PRECAST-RD-12M-2100-TYPE-B
P01STHRD04	STREETS	Active	2005-01-03	139576	Base Concrete Precast SL PRECAST-RD-15M-2400-TYPE-C
P01STHRD04	STREETS	Active	2005-01-03	139578	Base Concrete Precast-RD-9M-1900-Type-B1
P01STHRD04	STREETS	Discontinued	2004-01-02	139579	Base Concrete Service Precast-RD-9M-1900-Type-B1-S
P01STHRD04	STREETS	Active	2005-01-03	139606	Duct Streetlight HDPE 1-1/4in
P01STHRD04	STREETS	Active	2005-01-03	139607	Coupler Compression PVC 1-1/4in 420-02-125

Price List ID	Family Code	Price List Status	Price List Effective Date	Item ID	Description
P01STHRD04	STREETS	Active	2005-01-03	139949	Fuse Bussman 30amp ATQR30
P01STHRD04	STREETS	Active	2004-01-02	139950	Fuse HRC 30A NSC30
P01STHRD04	STREETS	Active	2005-01-03	139951	Fuse HRC 60A
P01STHRD04	STREETS	Active	2005-01-03	139952	Fuse HRC-I 30amp Class J
P01STHRD04	STREETS	Active	2004-01-02	139954	Fuse Little 2A-3AG
P01STHRD04	STREETS	Active	2005-01-03	139985	Fuse Fast Acting 10amp KTK10
P01STHRD04	STREETS	Active	2005-01-03	139988	Fuse BAF-2-AMP
P01STHRD04	STREETS	Active	2004-07-02	139989	Fuse Switch Block Phenolic 352
P01STHRD04	STREETS	Active	2005-01-03	139990	Fuse Switch Block End Piece Phenolic 330
P01STHRD04	STREETS	Active	2004-07-02 140120		Holder Fuse Form II 100 Amp
P01STHRD04	STREETS	Active	2004-07-02	140765	Service Unit 240V Relay Normally Open 2 Pole 30 Amp
P01STHRD04	STREETS	Active	2005-01-03	140766	Service Unit 208V Relay Normally Closed 2 Pole 30 Amp
P01STHRD04	STREETS	Active	2005-01-03	140897	Photo Control Hot Day NORMALLY-OPEN
P01STHRD04	STREETS	Active	2005-01-03	140898	Adapter Photocell Twist-Lock
P01STHRD04	STREETS	Active	2005-01-03	140899	Photo Control NORMALLY-CLOSED
P01STHRD04	STREETS	Active	2005-01-03	141208	Conduit Rigid 1-1/4in
P01STHRD04	STREETS	Active	2005-01-03	141337	Cable Grip Single Eye Kellam-073-04-1282
P01STHRD04	STREETS	Active	2005-01-03	141913	Protector Streetlight Surge Secondary
P01STLUM04	STLUMIN	Active	2004-01-02	143025	Luminaire HPSV Cobrahead 100watt M2RR10S7P1GMS2206
P01STLUM04	STLUMIN	Discontinued	2005-01-03	143026	Luminaire Walkway HPS 100W RC2 PC 120/208/240 Black CP8314
P01STLUM04	STLUMIN	Active	2005-01-03	143028	Luminaire Mercury Vapor Colonial 250watt CL1251
P01STLUM04	STLUMIN	Active	2005-01-03	143032	Luminaire HPSV Post Top Traditional 150Watt
P01STLUM04	STLUMIN	Active	2005-01-03	143033	Luminaire HPSV Cobrahead 250watt M2RR25S0P1GMS2112
P01STLUM04	STLUMIN	Active	2005-01-03	143034	Luminaire Metal Halide Chinatown c/w Pole & Shroud 250watt

Price List ID	Family Code	Price List Status	Price List Effective Date	Item ID	Description
P01STLUM04	STLUMIN	Active	2005-01-03 143035 L		Luminaire Metal Halide Roundpack 11Ave 1000watt CCS29
P01STLUM04	STLUMIN	Active	2005-01-03	143036	Luminaire HPSV Expressway 400watt MV400HP24WCVGB
P01STLUM04	STLUMIN	Active	2005-01-03	143037	Luminaire HPSV Cobrahead 400watt M4RR4OS7G1GMS3309
P01STLUM04	STLUMIN	Active	2005-01-03	143038	Luminaire HPSV Cobrahead 1000watt OVL915W83E43-COC
P01STLUM04	STLUMIN	Active	2005-01-03	143039	Luminaire HPSV Square Pack 250watt CS-7252-CN9C0C
P01STLUM04	STLUMIN	Active	2005-01-03	143040	Luminaire HPSV Cobrahead 200watt OVZ20SCG2E-COC
P01STLUM04	STLUMIN	Active	2004-07-02	143041	Luminaire HPSV Ornamental Round 100watt RPI00H924BG3
P01STLUM04	STLUMIN	Active	2004-01-02	143042	Luminaire Metal Halide Quadpack 1000watt
P01STLUM04	STLUMIN	Active	2005-01-03	143043	Luminaire HPSV Cobrahead 150watt M2RR15S7P1GMS2206
P01STLUM04	STLUMIN	Active	2005-01-03 143044		Luminaire HPSV Wall Cube 250watt 553250LXL-3
P01STLUM04	STLUMIN	Discontinued	2004-07-02	143045	Luminaire HSP 100W RC3 AC 120/280/240 Black CP6112
P01STLUM04	STLUMIN	Active	2005-01-03	143046	Luminaire HPSV Square Pack 150watt CS72329-BZ-COC
P01STLUM04	STLUMIN	Active	2004-01-02	143047	Luminaire HPSV Post Top Contemporary 100watt CC-S-LY
P01STLUM04	STLUMIN	Active	2004-01-02	143048	Luminaire Metal Halide Roundpack 7Ave 1000w MAR-54-1000-208
P01STLUM04	STLUMIN	Active	2004-01-02	143049	Luminaire Metal Halide Olympic Way 175watt
P01STLUM04	STLUMIN	Active	2004-01-02	143050	Luminaire Metal Halide Post Top Traditional 250watt PD1805
P01STLUM04	STLUMIN	Active	2005-01-03	143051	Luminaire HPSV Tear Drop Black 150watt URB15S41AL2MC0C
P01STLUM04	STLUMIN	Active	2004-01-02	143052	Luminaire HPSV Tear Drop Bridge Green 150watt
P01STLUM04	STLUMIN	Active	2005-01-03	143053	Luminaire MH Tear Drop Black 250watt 208v URC25M2OAL2MC0C
P01STLUM04	STLUMIN	Active	2005-01-03	143054	Luminaire HPSV Globe Clear 150Watt
P01STLUM04	STLUMIN	Active	2004-01-02	143056	Luminaire HPSV Flat Lens 150watt 0VH15SCV3D-Cal-Roads
P01STLUM04	STLUMIN	Active	2004-01-02	143057	Luminaire HPSV Flat Lens 400watt OVF40SCF3D-COC
P01STLUM04	STLUMIN	Active	2004-01-02	143058	Luminaire HPSV Flat Lens 200watt 0VH20V3D-C0C
P01STLUM04	STLUMIN	Active	2004-01-02	143059	Luminaire LPSV 135watt SOX240 SP213LD1MB-O2

Price List ID	Family Code	Price List Status	Price List Effective Date	Item ID	Description
P01STLUM04	STLUMIN	Active	2005-01-03	143060	Luminaire LPSV 135watt SOX208
P01STLUM04	STLUMIN	Active	2004-01-02	143061	Luminaire HPSV Flat Lens 100watt 0VH1OSCV3D-Cal-Roads
P01STLMP04	STLAMP	Active	2004-01-02	143065	Refractor HPSV Cobrahead 250watt J904010 84060
P01STLMP04	STLAMP	Active	2004-01-02	143066	Refractor HPSV Expressway 4098A 400 Watt 4098-B-BULK
P01STLMP04	STLAMP	Active	2005-01-03	143067	Refractor HPSV Cobrahead 400watt Z364247 4066
P01STLMP04	STLAMP	Active	2004-01-02	143069	Refractor Mercury Vapor Colonial 250watt L08X2
P01STLMP04	STLAMP	Active	2004-01-02	143070	Refractor HPSV Cobrahead 250/400watt YD1438
P01STLMP04	STLAMP	Active	2004-01-02	143071	Ring Holding Metal Stylvue 1000watt L05YC2
P01STLMP04	STLAMP	Active	2004-01-02	143073	Refractor HPSV Cobrahead 1000watt 51415 3513017OO2
P01STLMP04	STLAMP	Active	2004-01-02	143074	Refractor HPSV Cobrahead 1000watt 464D472 YD326O
P01STLMP04	STLAMP	Active	2004-01-02	143075	Refractor Metalarc Stylvue L08X3 1000watt L088XT
P01STLMP04	STLAMP	Active	2005-01-03	143076	Refractor HPSV Post Top Traditional 150watt K118-EAR-11
P01STLMP04	STLAMP	Active	2005-01-03	143078	Refractor HPSV Walkway 100watt
P01STLMP04	STLAMP	Active	2005-01-03	143978	Lamp Mercury Vapor Clear 250watt H37KC250DX 12/case
P01STLMP04	STLAMP	Active	2004-01-02	143979	Lamp Mercury Vapor Clear 400watt H33CD-400 10/case
P01STLMP04	STLAMP	Active	2004-01-02	143982	Lamp Mercury Vapor White 125watt 65423-0 24/case
P01STLMP04	STLAMP	Active	2005-01-03	143983	Lamp Metal Halide Clear 175watt Universal 64471-1
P01STLMP04	STLAMP	Active	2005-01-03	143984	Lamp Metal Halide Clear 250watt Universal M250-U
P01STLMP04	STLAMP	Active	2005-01-03	143986	Lamp Metal Halide Clear 1000watt Universal 64468-0 6/case
P01STLMP04	STLAMP	Active	2004-01-02	143987	Lamp HPSV 70watt 67512-3
P01STLMP04	STLAMP	Active	2005-01-03	143988	Lamp HPSV 100watt 67514-3
P01STLMP04	STLAMP	Active	2005-01-03	143989	Lamp HPSV Clear 55volt 150watt 67516-3
P01STLMP04	STLAMP	Active	2005-01-03	143990	Lamp HPSV 200watt 67576-1 20/case
P01STLMP04	STLAMP	Active	2005-01-03	143991	Lamp HPSV Clear 250watt LU250 20/case

Price List ID	Family Code	Price List Status	Price List Effective Date	Item ID	Description	
P01STLMP04	STLAMP	Active	2005-01-03	143992	Lamp HPSV 400watt 67533-1 20/case	
P01STLMP04	STLAMP	Active	2005-01-03	143993	Lamp HPSV 1000watt 67307-0 6/case	
P01STLMP04	STLAMP	Active	2004-01-02	144070	Lamp LPSV SOX135	
P01STHRD04	STREETS	Active	2005-01-03	147104	Primer Zinc Rich MIOZINC-MC2.8	
P01STHRD04	STREETS	Active	2005-01-03	147132	Thinner Primer Zinc Chromate	
P01STHRD04	STREETS	Active	2005-01-03	147201	Paint Pole Green Lustre Moisture 3.5	
P01STHRD04	STREETS	Active	2004-01-02	150886	Bolt Anchor Galv GR150 Conventional Thread 1-1/4in x 60	
P01STHRD04	STREETS	Active	2005-01-23	150889	Bolt Anchor Galvanized 1in x 66in	
P01STHRD04	STREETS	Active	2005-01-23	150890	Bolt Anchor Galvanized 1in x 40in	
P01STHRD04	STREETS	Active	2005-01-03	150891	Bolt Anchor Galvanized 1-1/4in x 40in	
P01STHRD04	STREETS	Active	2005-013	151006	Bolt Anchor 1in x 36in-NC A193-B7	
P01STHRD04	STREETS	Active	2005-01-03	151018	Bolt Anchor Galv GR150 International Thread 1-1/4in x 70	
P01STHRD04	STREETS	Active	2004-07-02	151019	Bolt Anchor Galv GR150 International Thread 1-1/4in x 60	
P01STHRD04	STREETS	Discontinued	2004-01-02	151023	Bolt Anchor Galv Dywidag No7 x 40in Grade 60 B07U04010	
P01STHRD04	STREETS	Active	2004-01-02	151026	Rebar Steel Square Tie 15M-5-65/100FT-POLE	
P01STHRD04	STREETS	Active	2004-01-02	151028	Rebar Steel Metric 15M-5-100FT-POLE 20/bundle	
P01STHRD04	STREETS	Active	2004-01-02	151029	Rebar Steel Metric 20M-6-100FT-POLE 20/bundle	
P01STHRD04	STREETS	Active	2004-01-02	151031	Rebar Steel Dowell 25M-8-100FT-POLE	
P01STHRD04	STREETS	Active	2005-01-03	151037	Rebar Steel Cage 20M-POLE-BASE	
P01STHRD04	STREETS	Active	2004-01-02	151153	Bracket Lighting Expressway 400 Watt	
P01STPOL04	STPOLES	Active	2005-02-01	151241	Pole Painted Square 30ft 30FT-SQUARE	
P01STPOL04	STPOLES	Discontinued	2004-01-02	151245	Pole Galvanized Double Davit 65 x 6ft	
P01STPOL04	STPOLES	Active	2004-01-02	151246	Pedestal J	
P01STPOL04	STPOLES	Active	2005-01-03	151252	Pole Painted Traditional 16ft 5m	

Price List ID	Family Code	Price List Status	Price List Effective Date	Item ID	Description
P01STPOL04	STPOLES	Active	2005-01-03	151258	Pole Painted Contemporary 16ft
P01STPOL04	STPOLES	Active	2004-01-02	151265	Pole Galvanized Double Davit 30 x 6ft
P01STPOL04	STPOLES	Discontinued	2004-01-02	151267	Pole Galvanized Straight 27ft
P01STHRD04	STREETS	Active	2005-01-03	151268	Adapter Base Transformer
P01STPOL04	STPOLES	Active	2004-01-02	151269	Pole Painted Olympic Way
P01STPOL04	STPOLES	Active	2004-01-02	151285	Pole Painted Traditional 21ft
P01STHRD04	STREETS	Active	2005-01-03	151301	Base Cover Decorative for 5m 16ft Traditional Pole
P01STPOL04	STPOLES	Active	2004-01-02	151303	Pole Painted Louise Bridge 7m
P01STPOL04	STPOLES	Active	2005-01-03	151304	Pole Painted Step Black 7m
P01STPOL04	STPOLES	Active	2004-12-01	151305	Pole Painted Tear Drop Straight 7.8m
P01STPOL04	STPOLES	Active	2005-01-03	151311	Pole Fiberglass Black 5m
P01STPOL04	STPOLES	Active	2004-01-02	151316	Pole Painted Step Green 7m +G487
P01STPOL04	STPOLES	Active	2004-01-02	151320	Pole Galvanized Bottom Davit Shaft 9m x 2.5m
P01STPOL04	STPOLES	Active	2004-12-01	151321	Pole Galvanized Single Davit Top Streetlight 9m x 2.5m
P01STPOL04	STPOLES	Discontinued	2004-12-01	151322	Pole Galvanized Double Davit Top Streetlight 9m x 2.5m
P01STPOL04	STPOLES	Active	2005-01-03	151323	Pole Galvanized Bottom Davit Shaft Streetlight 15m x 2.5m
P01STPOL04	STPOLES	Active	2005-01-03	151324	Pole Galvanized Single Davit Top Streetlight 15m x 2.5m
P01STPOL04	STPOLES	Discontinued	2005-01-03	151325	Pole Galvanized Double Davit Top Streetlight 15m x 2.5m
P01STPOL04	STPOLES	Active	2005-01-03	151326	Pole Galvanized Bottom Davit Shaft Streetlight 20m x 2.5m
P01STPOL04	STPOLES	Active	2005-01-03	151327	Pole Galvanized Single Davit Top Streetlight 20m x 2.5m
P01STPOL04	STPOLES	Active	2004-01-02	151328	Pole Galvanized Double Davit Top Streetlight 20m x 2.5m
P01STHRD04	STREETS	Active	2005-01-03	151350	Cabinet Control 32 x 48 x 22in
P01STHRD04	STREETS	Active	2005-01-03	151364	Upsweep Pole Steel/Wood 8FT
P01STHRD04	STREETS	Active	2005-01-03	151393	Upsweep Traditional Underbrace 2M

Price List ID	Family Code	Price List Status	Price List Effective Date	Item ID	Description
P01STHRD04	STREETS	Active	2005-01-03	151404	Anchor Bell International Thread 1-1/4in
P01STPOL04	STPOLES	Active	2005-01-03	151808	Pole Tapered Round 12m
P01STPOL04	STPOLES	Discontinued	2004-01-02	151809	Pole Painted Chinatown Red 16ft
P01STPOL04	STPOLES	Active	2004-01-02	151814	Pole Painted Black 12ft
P01STPOL04	STPOLES	Active	2004-01-02	151815	Pole Painted Black Aluminum Ornamental 11.5ft
P01STPOL04	STPOLES	Active	2004-01-02	151816	Pole Painted Black Aluminum Ornamental 23ft
P01STHRD04	STREETS	Active	2005-01-03	151819	Cover handhole Galvanized/Aluminum Pole/Davit
P01STHRD04	STREETS	Active	2005-01-03	154245	Holder Fuse 600V Amerace 65U
P01STHRD04	STREETS	Active	2005-01-03	154247	Fuse Bussman 10amp 250volt BAF10
P01STPOL04	STPOLES	Active	2005-01-03 155240 Pole Galvanized High Mas		Pole Galvanized High Mast Streetlight 30m
P01STHRD04	STREETS	Active	2005-01-03 155509 Section Top/Bottom J		Section Top/Bottom Junction Box 25010
P01STHRD04	STREETS	Active	2005-01-03	155510	Lid Steel Junction Box 25310
P01STHRD04	STREETS	Active	2005-01-03	155511	Plate Drain Junction Box 25800
P01STHRD04	STREETS	Active	2005-01-03	155528	Box Concrete Junction c/w-Steel-Lid 9217
P01STHRD04	STREETS	Active	2005-01-03	155544	Reflector House Side-Shield
P01STHRD04	STREETS	Active	2005-01-03	155580	Base Breakaway 15m Davit 13in BCD C/W Skirts 4100
P01STHRD04	STREETS	Active	2005-01-03	155653	Paint Pole Ameron Green PSX700
P01STLUM04	STLUMIN	Active	2005-01-03	156687	Luminaire HPSV High Mast Area Cooper HMX91-S-C-V-D-W
P01STPOL04	STPOLES	Active	2005-01-03	156704	Pole Galvanized Mid Section Streetlight 20m x 2.5m
P01STPOL04	STPOLES	Active	2005-01-03	157201	Pole Painted Step Black Single Davit 8.125m
P01STPOL04	STPOLES	Active	2005-01-03	157202	Pole Painted Step Black Double Davit 8.125m
P01STLUM04	STLUMIN	Active	2005-01-03	157225	Luminaire HPSV Tear Drop Black 250watt 208V URC25S20AL2MCOC
P01STLUM04	STLUMIN	Active	2005-01-03	157327	Luminaire 100W HPS Domus Style
P01STPOL04	STPOLES	Active	2005-01-03	157396	Pole Painted Step Green 7m

Price List ID	Family Code	Price List Status	Price List Effective Date	Item ID	Description
P01STLUM04	STLUMIN	Active	2005-01-03	157760	Luminaire HBM-310HPS-MS2-RC-240volt-CWA-GLS
P01STLUM04	STLUMIN	Active	2005-01-03	157761	Luminaire HBM-310HPS-MC2F-RC-240volt-CWA-GLS
P01STLMP04	STLAMP	Active	2005-01-03	157762	Lamp High Pressure Sodium 310watt 100volt C310S67
P01STHRD04	STREETS	Active	2005-01-03	158131	Padlock Keyed Alike Master No150
P01STLUM04	STLUMIN	Active	2005-01-03	158236	Luminaire Traditional Post Top HPS 100w
P01STLUM04	STLUMIN	Active	2005-01-03	158237	Luminaire Lantern Post Top Black CP6112-HPS100-RC3-240
P01STLUM04	STLUMIN	Active	2005-01-03	158238	Luminaire Walkway Style c/w 3in Adaptor CP8323-HPS100RC2-240
P01STHRD04	STREETS	Active	2005-01-03	158354	Anchor Rod Coupler 1in x 4in-NC
P01STHRD04	STREETS	Active	2005-01-03	158355	Nut Anchor Bolt 1in-NC
P01STHRD04	STLUMIN	Active	2005-01-03 158572 Luminaire Flat Lens Unpainted		Luminaire Flat Lens Unpainted 100watt OVF-10S-CV-2D-U
P01STHRD04	STLUMIN	Active	2005-01-03 158573 Luminaire Flat Lens		Luminaire Flat Lens Cobrahead 150watt HPS AEL-115-15S-R
P01STHRD04	STLUMIN	Active	2005-01-03	158605	Luminaire HPS 480 PS-P HSF HS 750watt CCS29A3
P01STHRD04	STLAMP	Active	2005-01-03	158606	Lamp 480volt LU750
P01STHRD04	STLUMIN	Active	2005-01-03	158855	Luminaire Flat Lens Cobrahead 200watt HPS AEL-125-20S-R
P01STHRD04	STLUMIN	Active	2005-01-03	158856	Luminaire Flat Lens Cobrahead 400watt HPS AEL-115-40S-R
P01STHRD04	STREETS	Active	2005-01-03	159290	Cabinet Streetlight Service 100 Amp 240/480volt 1ph
P01STHRD04	STREETS	Active	2005-01-03	159308	Breakaway Base 9m Davit 11in BCD c/w Skirts
P01STHRD04	STLAMP	Active	2005-01-03	159333	Lamp M1000/U/BT37
P01STHRD04	STLAMP	Active	2005-01-03	159355	Refractor HPS Domus Style 100watt Lumec/114830
P01STHRD04	STLUMIN	Active	2005-03-01	158856	Luminaire 150watt HPS Domus Style
P01STLUM04	STLUMIN	Active	2004-03-09	143026R	Luminaire HPSV Walkway 100watt P17M10S7G1LMS5GR048
P01STLUM04	STLUMIN	Active	2004-01-02	143033R	Luminaire HPSV Cobrahead 250watt M2RR25S0P1GMS2112
P01STLUM04	STLUMIN	Active	2004-01-02	143034R	Luminaire Metal Halide Chinatown c/w Pole & Shroud 250 Watt

Price List ID	Family Code	Price List Status	Price List Effective Date	Item ID	Description
P01STLUM04	STLUMIN	Active	2005-01-03	143035R	Luminaire Metal Halide Roundpack 11Ave 1000watt CCS29
P01STLUM04	STLUMIN	Active	2005-01-03	143036R	Luminaire HPSV Expressway 400watt HL2AHSBG1
P01STLUM04	STLUMIN	Active	2005-01-03	143037R	Luminaire HPSV Cobrahead 400watt M4RR4OS7G1GMS3309
P01STLUM04	STLUMIN	Active	2005-01-03	143038R	Luminaire HPSV Cobrahead 1000watt 0V50100C48ARC0C
P01STLUM04	STLUMIN	Active	2005-01-03	143040R	Luminaire HPSV Cobrahead 200watt M2RR20S0P1GMS2285
P01STLUM04	STLUMIN	Active	2004-07-02	143041R	Luminaire HPSV Ornamental Round 100watt RPI00H924BG3
P01STLUM04	STLUMIN	Active	2004-07-04	143043R	Luminaire HPSV Cobrahead 150watt M2RR15S7P1GMS2206
P01STLUM04	STLUMIN	Active	2004-01-02	143047R	Luminaire HPSV Post Top Contemporary 100watt CC-S-LY
P01STLUM04	STLUMIN	Active	2005-01-03	143051R	Luminaire HPSV Tear Drop Black 150watt URB15S41AL2MC0C
P01STLUM04	STPOLES	Active	2005-07-05	160360	Pole Galvanized Double Davit Bottom Streetlight 9m x 2.5m
P01STLUM04	STPOLES	Active	2005-07-05	160361	Pole Galvanized Double Davit Top Streetlight 9m x 2.5m
P01STLUM04	STPOLES	Active	2005-07-05	160362	Pole Galvanized Double Davit Bottom Streetlight 15m x 2.5m
P01STLUM04	STPOLES	Active	2005-07-05	160363	Pole Galvanized Double Davit Middle Streetlight 15m x 2.5m
P01STLUM04	STPOLES	Active	2005-07-05	160364	Pole Galvanized Double Davit Top Streetlight 15m x 2.5m

### **APPENDIX B**

#### **APPROVED PRODUCTS LIST**

**NO CONTENT AT THIS ISSUE** 


### **APPENDIX C**


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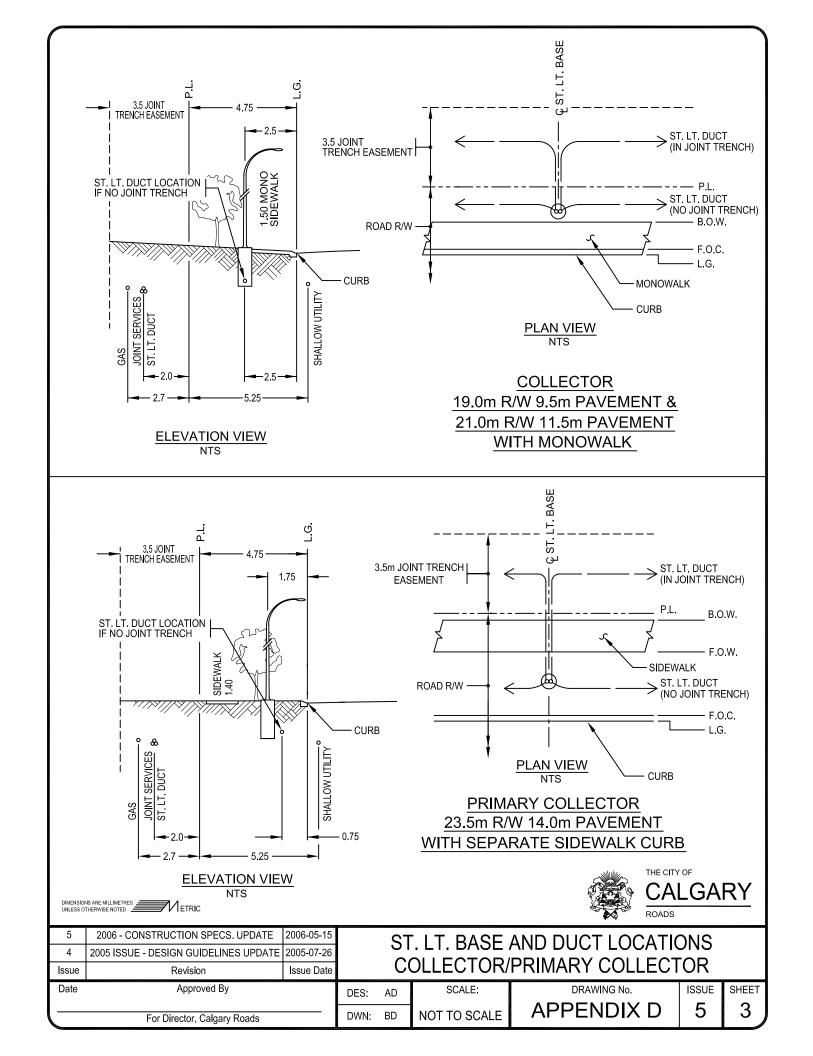
WORK IN PROGRESS NO CONTENT AT THIS ISSUE


#### **APPENDIX D**


### STREETLIGHTING LINE ASSIGNMENTS




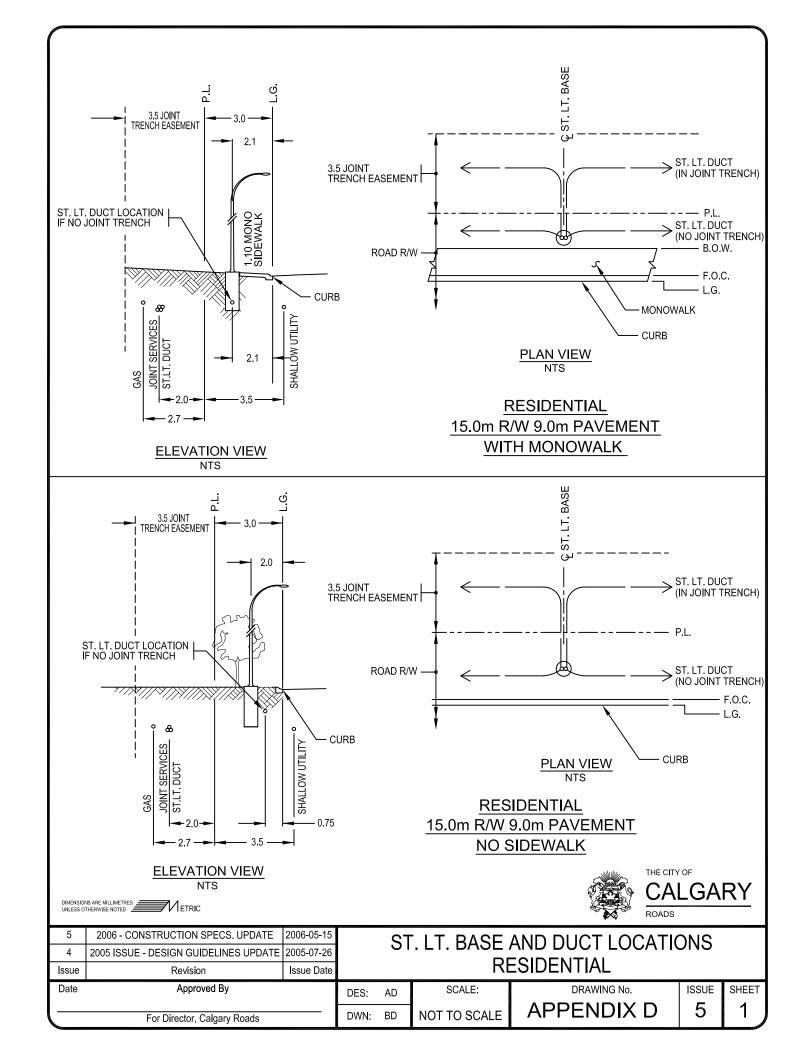


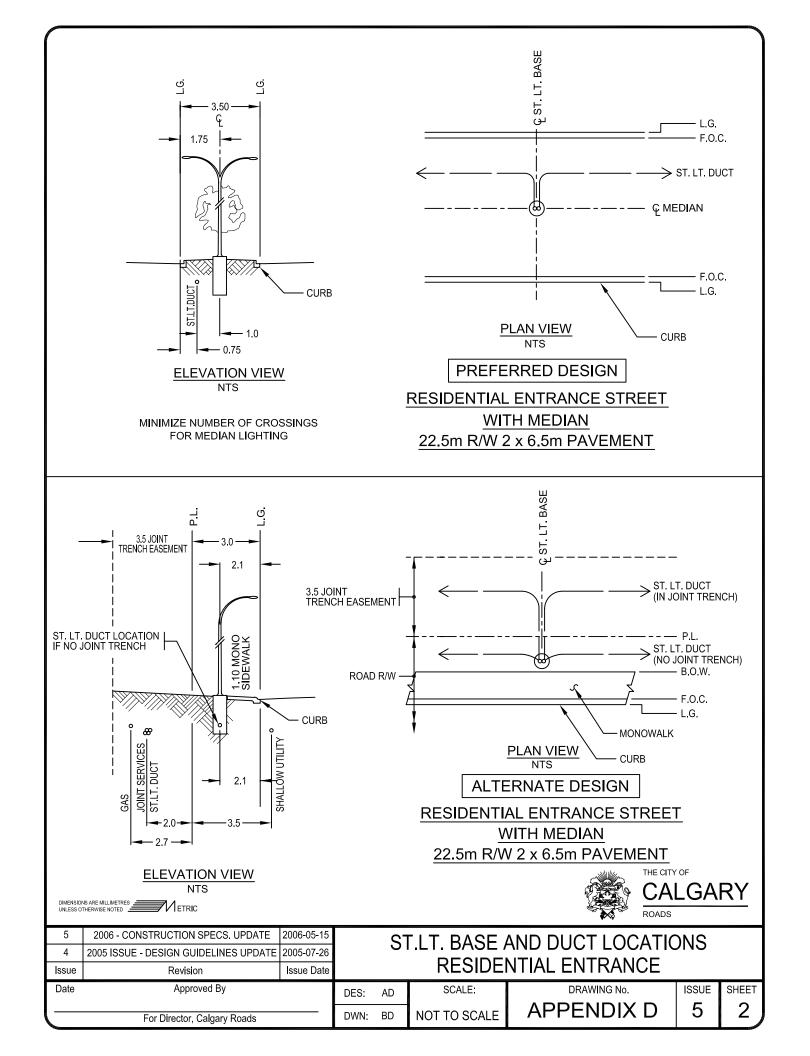

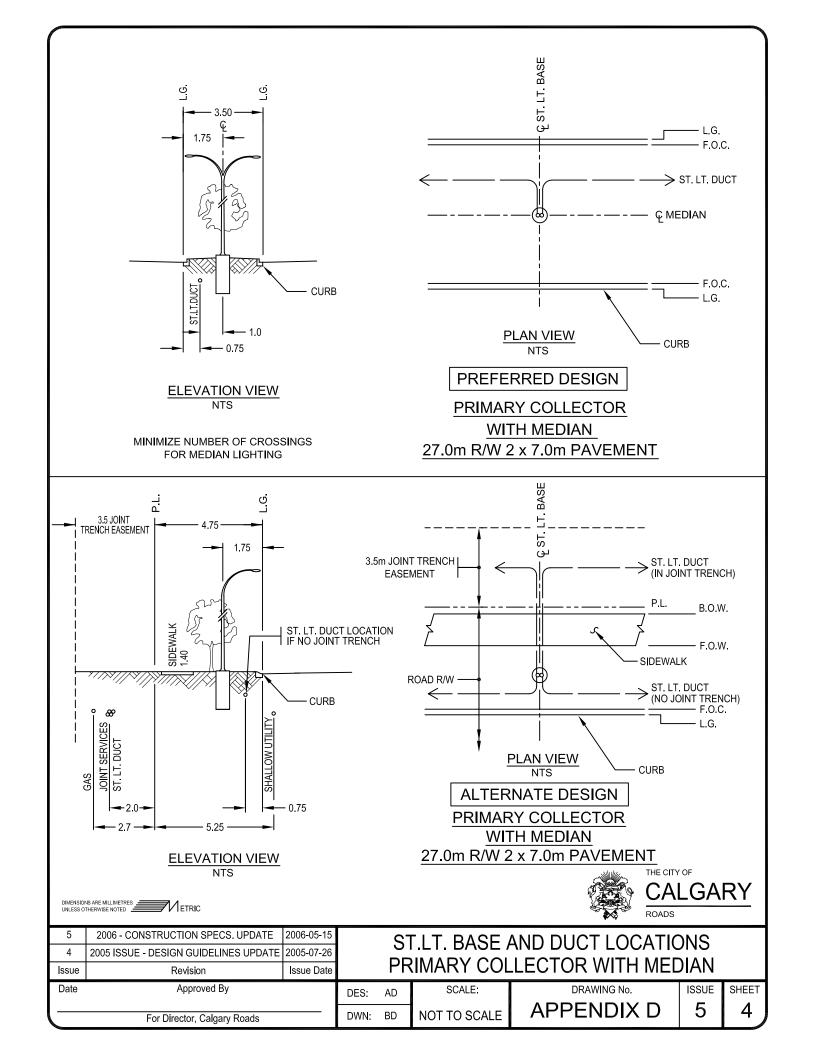

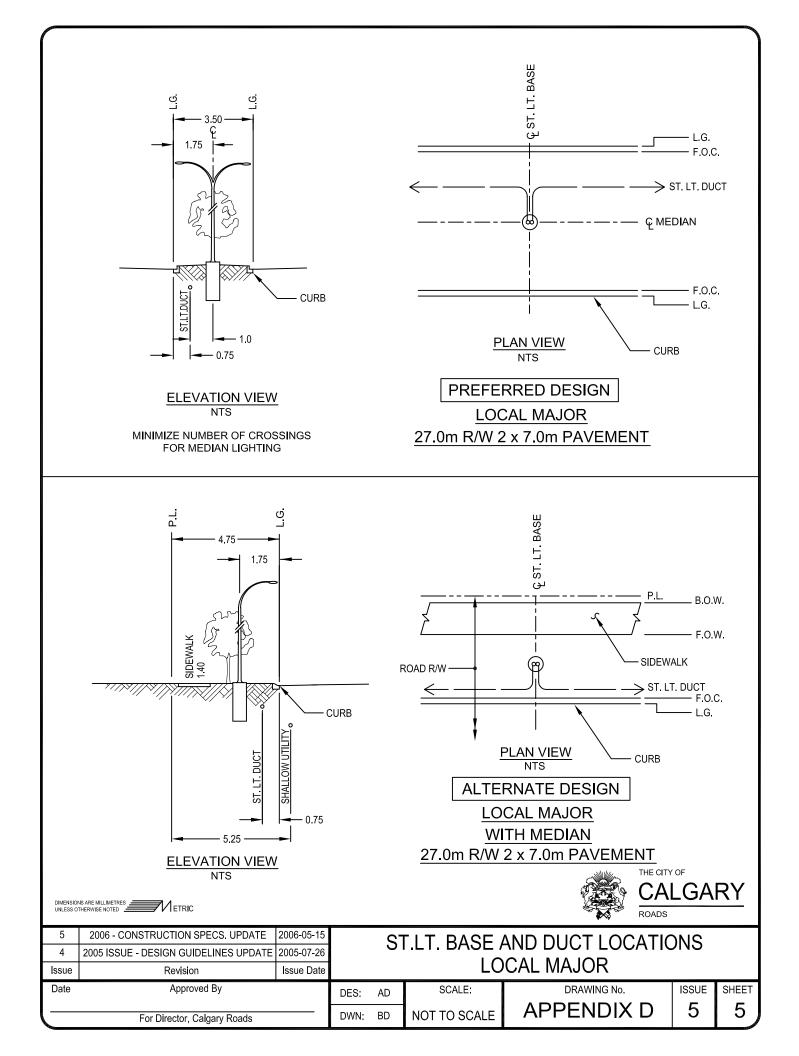

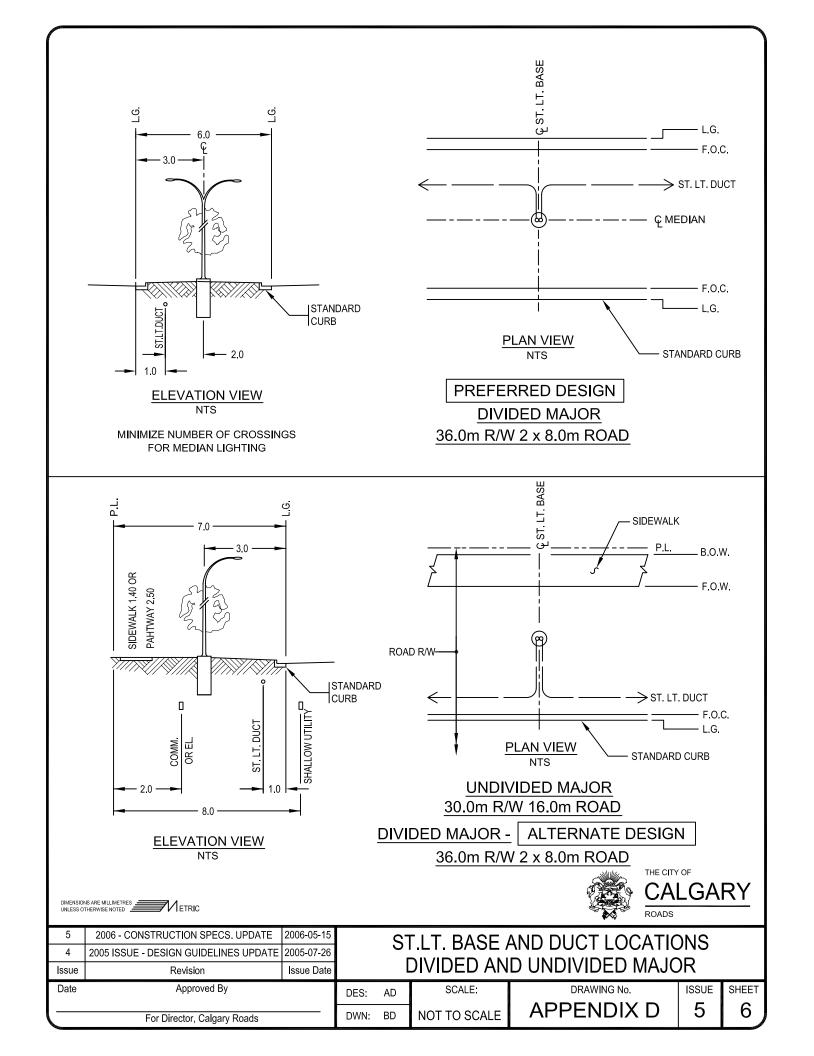

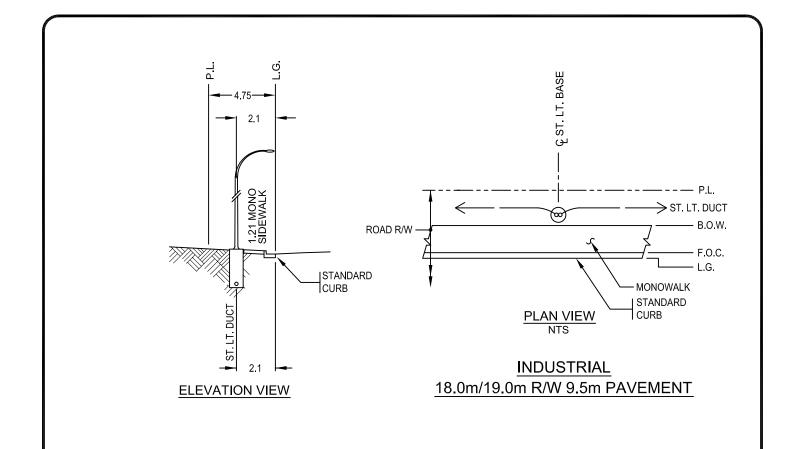



5	2006 - CONSTRUCTION SPECS. UPDATE	2006-05-15		T2	IT BAG
4	2005 ISSUE - DESIGN GUIDELINES UPDATE	2005-07-26	01. L1. D/		
Issue	Revision	Issue Date			
Date	Approved By		DES:	AD	SCALE:

For Director, Calgary Roads

DIMENSIONS ARE MILLIMETRES ETRIC

ST. LT. BASE AND DUCT LOCATIONS INDUSTRIAL


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DWN: BD


DRAWING No.

APPENDIX D

SHEET 5

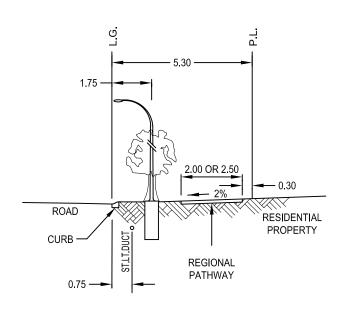

OPTION "A" FRONT YARD

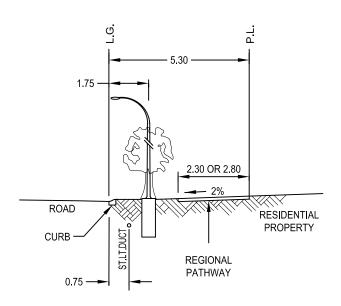

OPTION "B" SIDE OR REAR YARD



UNLESS OTHERWISE NOTED	<b>V</b> ETRIC

5

	2.0m LOCAL PATHWAY & 2.5m REGIONAL PATHWAY
2006-05-15	2.011 LOCAL FATTIWAT & 2.311 NEGIONAL FATTIWAT
Issue Date	ON RESIDENTIAL, COLLECTOR OR LOCAL MAJOR ROADS
	2006-05-15 Issue Date

 Issue
 Revision
 Issue Date
 ON RESIDENTIAL, COLLECT

 Date
 Approved By
 DES: BD
 SCALE: NOT TO SCALE

 For Director, Calgary Roads
 DWN: BD
 NOT TO SCALE


APPENDIX D


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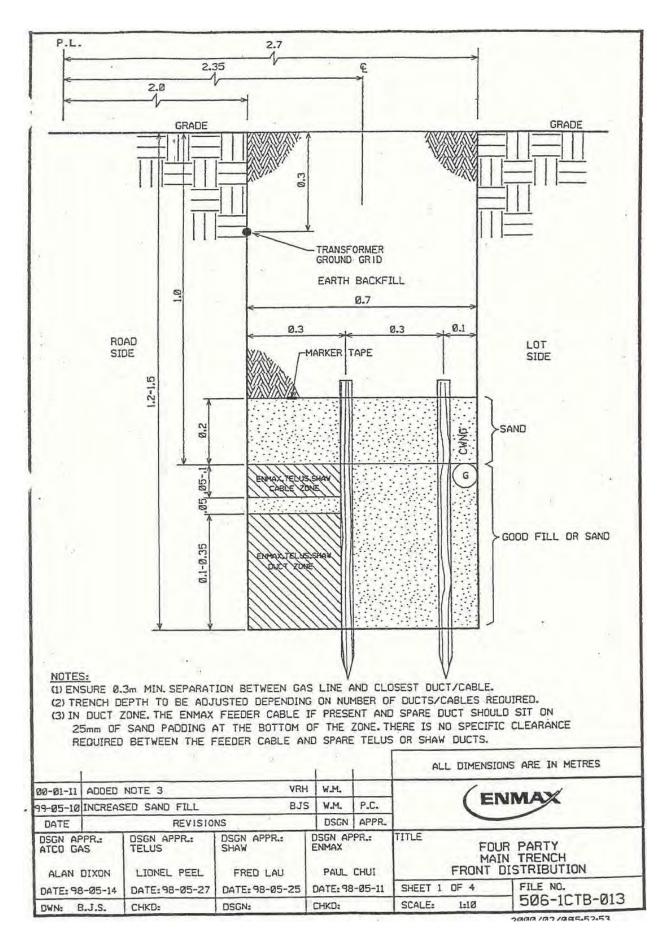
SHEET 8

#### <u>APPENDIX E</u>

#### **4-PARTY TRENCH REFERENCE DRAWINGS**



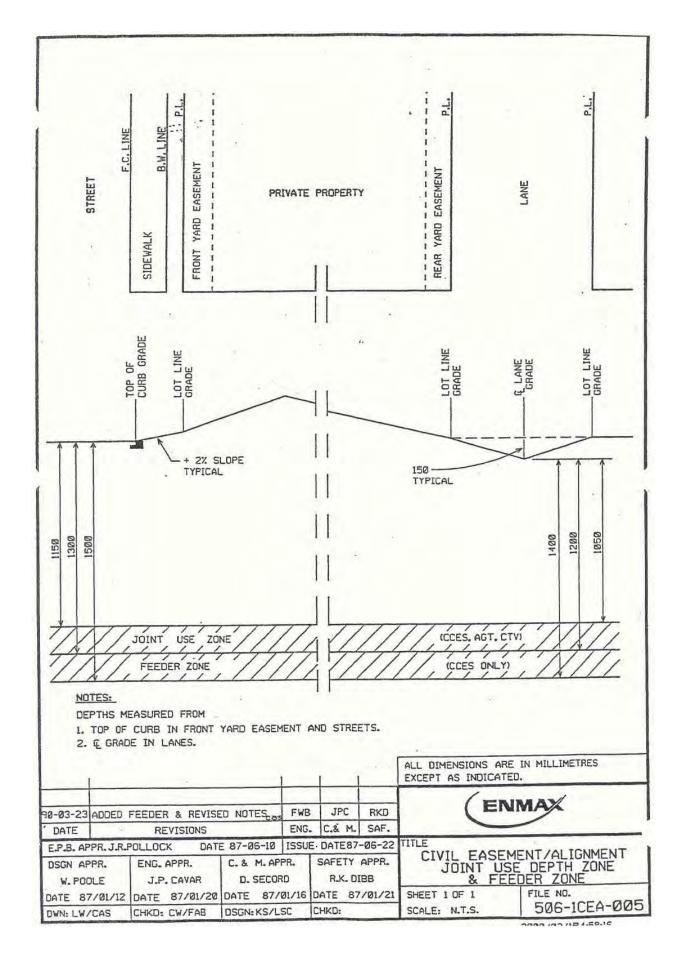

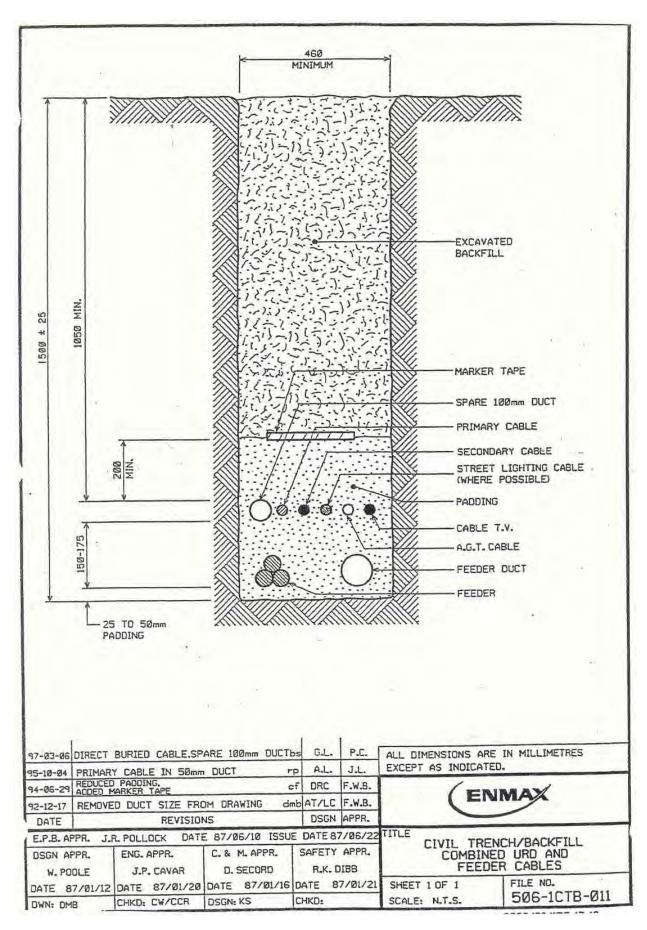

#### **APPENDIX F**


#### **ELECTRICAL ENERGY SUPPLY PROCEDURES**

### Draft- Streetlight Power Installation Flowchart

Calgary Roads or Designate submits preliminary design to EPC for supply to the Planning Department -


Customer Design (Henry Bandura)

call 514-3700

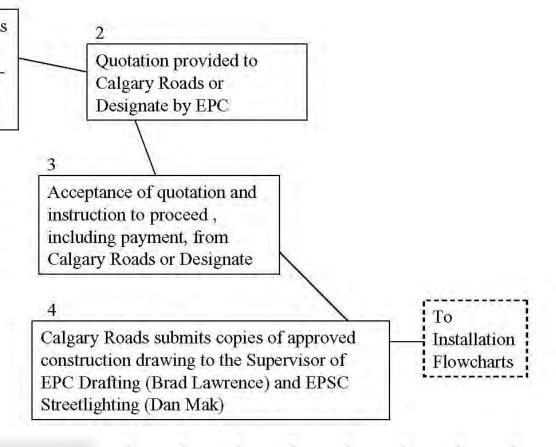


2004


# Draft - Streetlight Installations - UG Supply

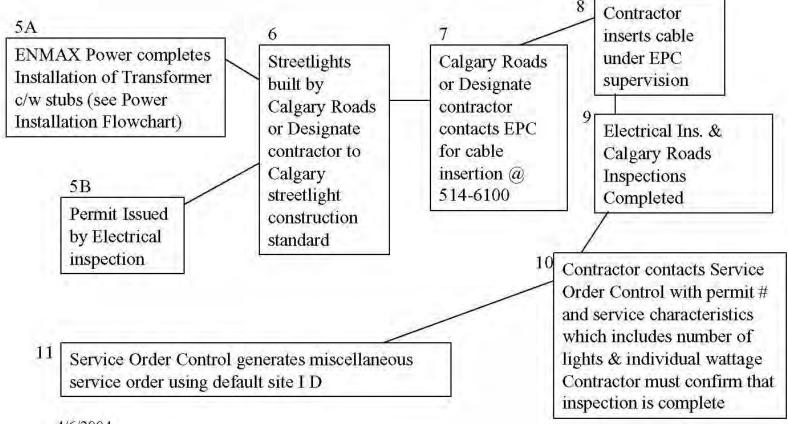

# Draft - Streetlight Installations - UG Supply

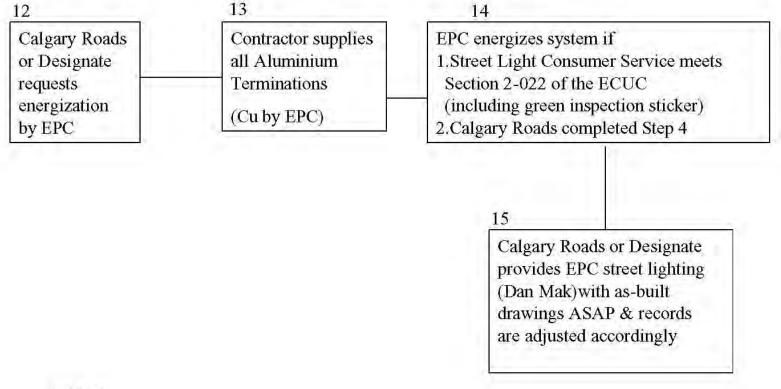


# Draft - Streetlight Installations - O/H Supply

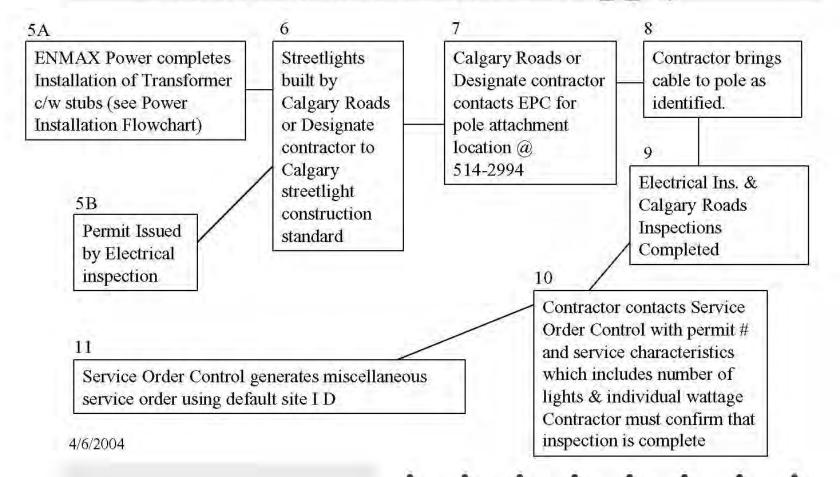


2004

## Draft - Streetlight Installations - O/H Supply

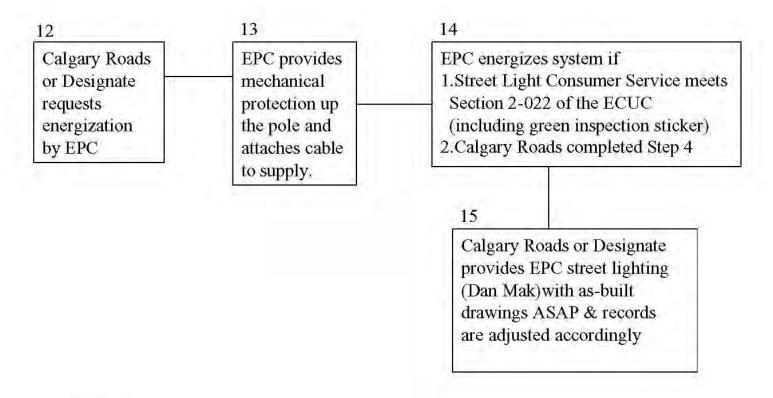

## Streetlight Disconnect Process

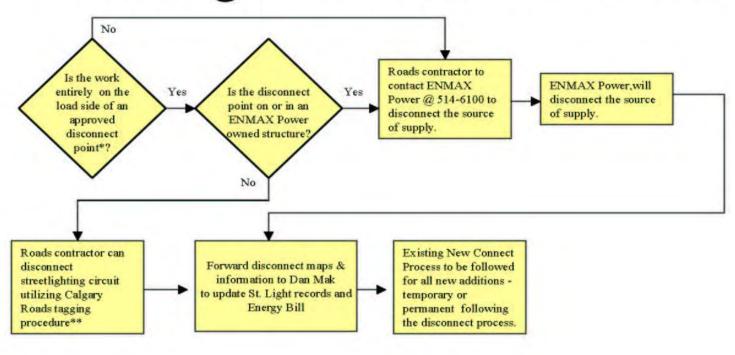

<sup>\*</sup> as approved by the Calgary Electrical Inspection Branch

<sup>\*\*</sup> currently under development by Calgary Roads

Streetlight Installations Clarification of Demarcation Points ENMAX Power Corp and Calgary Roads

## Scenario #1

Overhead Electrical Supply to Overhead Streetlighting – Rack Mounted Distribution Secondaries on Joint Use Poles

ENMAX Power will own, operate and maintain the secondary circuit running on the poles to the point of attachment of the City's cable jumper connection for the streetlight relay. Qualified personnel will do all construction, including installation and maintenance of luminaires to ECUC standards. Demarcation point is the relay connection to rack mounted secondary conductor.

## Scenario #2

Overhead Electrical Supply to Overhead Streetlighting – Dedicated Triplex(or equivalent) Distribution Secondaries on Joint Use Poles with Transformer In-line

Calgary Roads will own the secondary circuit. ENMAX Power will install, operate and maintain the entire secondary circuit on the joint use poles. Qualified personnel will do all construction and maintenance to ECUC standards. Demarcation point is the secondary bushing of the overhead transformer.

## Scenario #3

Overhead Electrical Supply to Overhead Streetlighting – Dedicated Triplex (or equivalent) Distribution Secondaries on Joint Use Poles with Transformer Off-line

ENMAX Power will own the first service span of the secondary circuit from the transformer pole. Calgary Roads will own the remaining secondary. ENMAX Power will operate and maintain the entire secondary circuit on the joint use poles. Qualified personnel will do all construction and maintenance to ECUC standards. Demarcation point is 1 secondary span from the overhead transformer.

## Scenario #4

Overhead Electrical Supply to Overhead Streetlighting – Dedicated Triplex(or equivalent) Distribution Secondaries to Dedicated Streetlight Poles

ENMAX Power will own the first service span to the streetlight service pole. Calgary Roads will own, operate and maintain the remaining secondary. Qualified personnel will do all construction and maintenance after the first secondary span to the standard determined by Calgary Roads. Demarcation point is the connection point to the weatherhead at the service pole. This applies for permanent or temporary services.

## Scenario #5 Overhead Electrical Supply to Underground Streetlighting

Demarcation Point is the secondary bushing of the transformer. Calgary Roads will supply and install secondary cable and duct to the base of the pole with enough additional cable to go up the pole and attach to the transformer secondary. ENMAX Power will provide mechanical protection from the base of the pole. ENMAX Power will attach the streetlight circuit to the pole and make the connection to the utility low voltage circuit or transformer.

## Scenario #6 Underground Electrical Supply to Underground Streetlighting

Demarcation Point is the secondary bushing of the transformer. ENMAX Power will install stubs to transformer. Calgary Roads will supply and install secondary cable and duct to the transformer. ENMAX Power will witness the pulling of the cable into the transformer by Calgary Roads. ENMAX Power will terminate the cable)(EPC supplies copper terminations, aluminum terminations by contractor). ENMAX Power will attach the terminated cable to the secondary bushings of the transformer.

## Scenario #7 Underground Electrical Supply to Overhead Streetlighting

Demarcation Point is the secondary bushing of the transformer. ENMAX Power will install stubs to the transformer. Calgary Roads will supply and install secondary cable and duct to the transformer. ENMAX Power will witness the pulling of the cable into the transformer by Calgary Roads. Calgary Roads will terminate their cable. ENMAX Power will attach the terminated cable to the secondary bushings of the transformer.

## Scenario #8 Network Vault Installations


ENMAX Power will own, operate and maintain the secondary circuits in the ENMAX Power manholes or vaults to the point of attachment provided for the secondary streetlight cable which will supply the relay or secondary power source. ENMAX Power personnel will do all the construction including the installation of the secondary streetlight power cables and their connection to the ENMAX Power secondary circuits in the manholes or vaults. ENMAX Power will NOT permit the installation of relays or other auxiliary equipment within the ENMAX Power system. All streetlight secondary cable is to be supplied by the CITY and installed by ENMAX Power at the City's cost.


The demarcation point for the streetlight or City conduit is the exterior surface of the last ENMAX Power structure on the cable run. Coring of the ENMAX Power structure must be approved in advance by ENMAX Power and the work performed by ENMAX Power.


The demarcation point for the streetlighting circuit is the start of the dedicated streetlighting secondary cable. In certain cases the streetlight secondary cable may pass between ENMAX Power manholes or vaults utilizing ENMAX Power conduit. The demarcation point of the conduit is the duct which is solely occupied by streetlighting and connects at one end to a solely owned and operated City facility.


(Please note – "Secondary" / "Secondary Circuit" etc. refer to low voltage circuits operating at the utilization voltage of the streetlights)


Please refer to attached sketches.

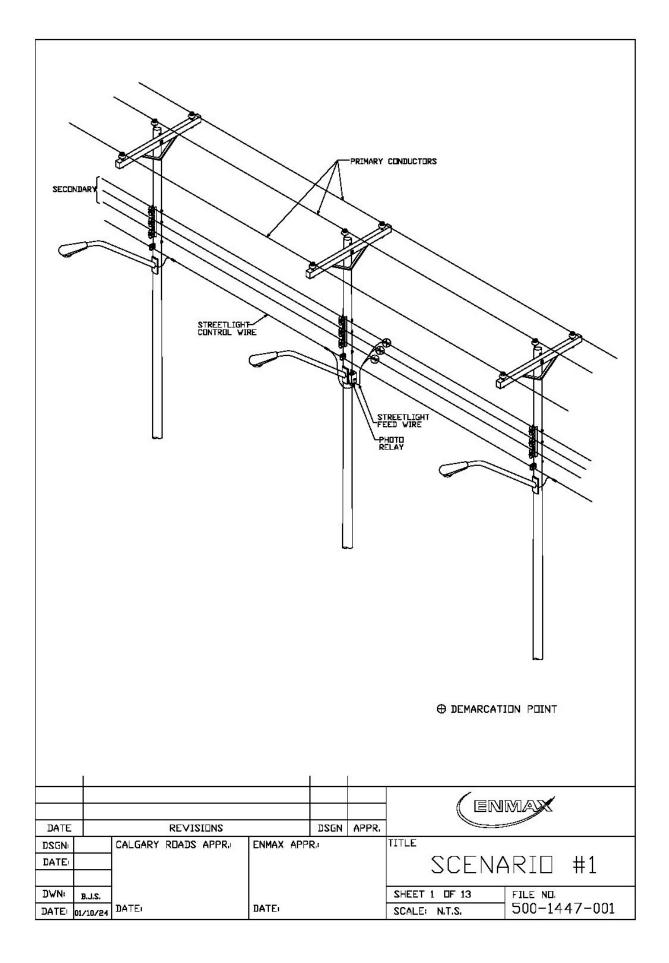


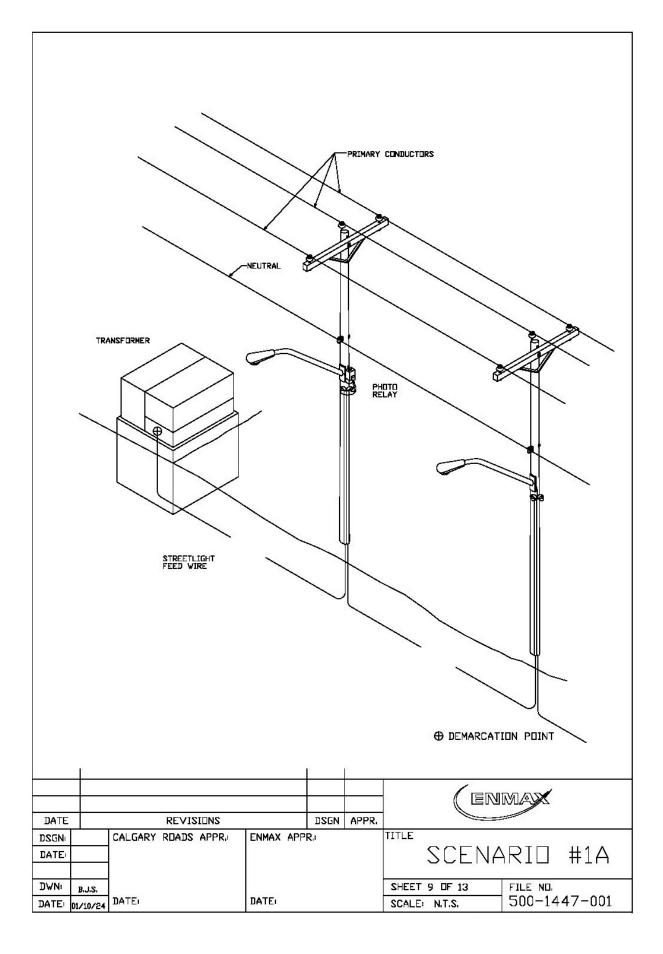


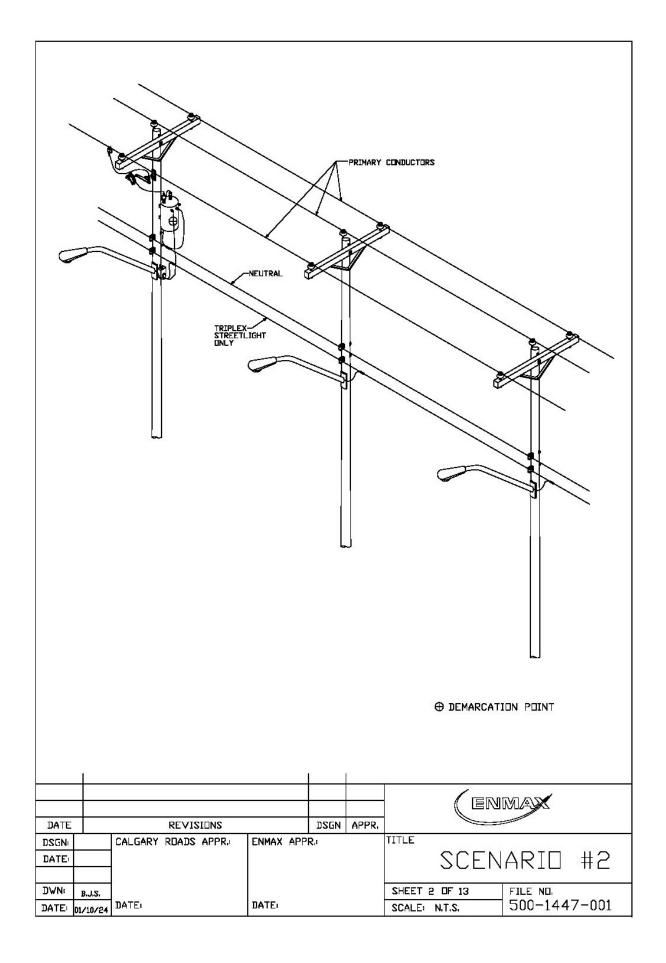


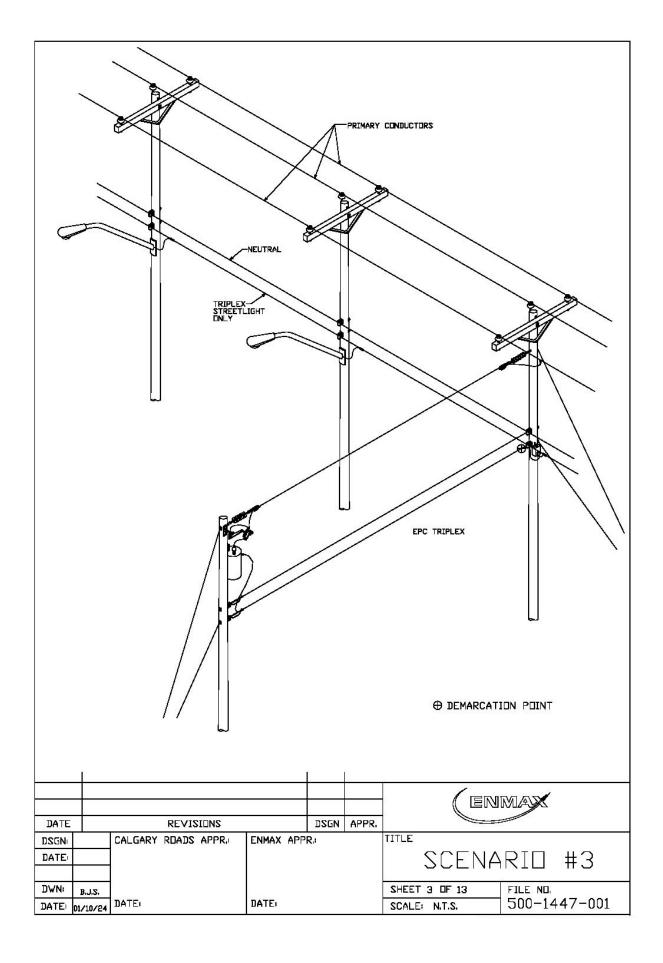


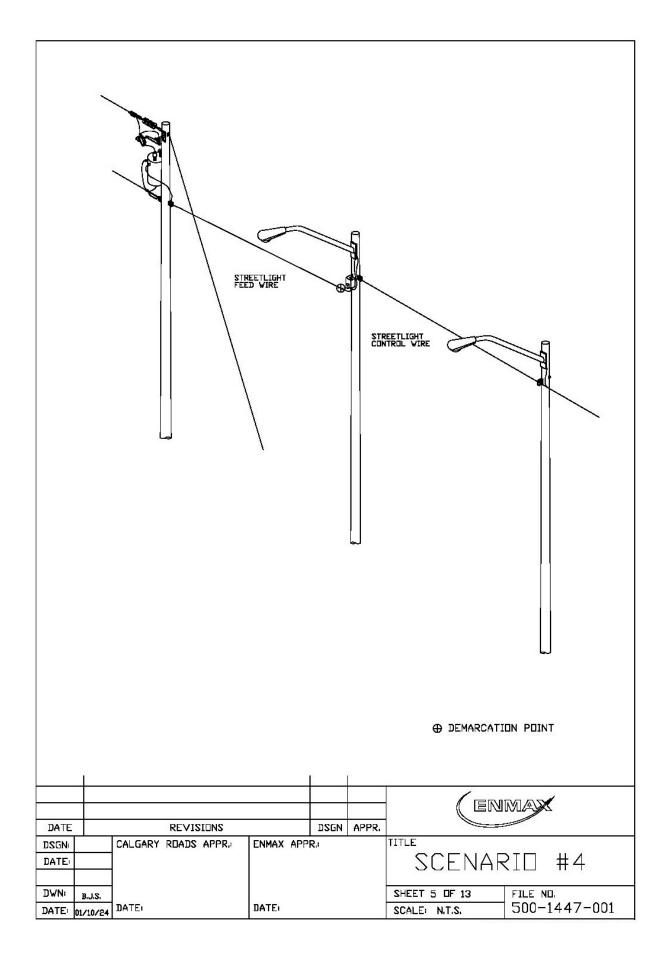


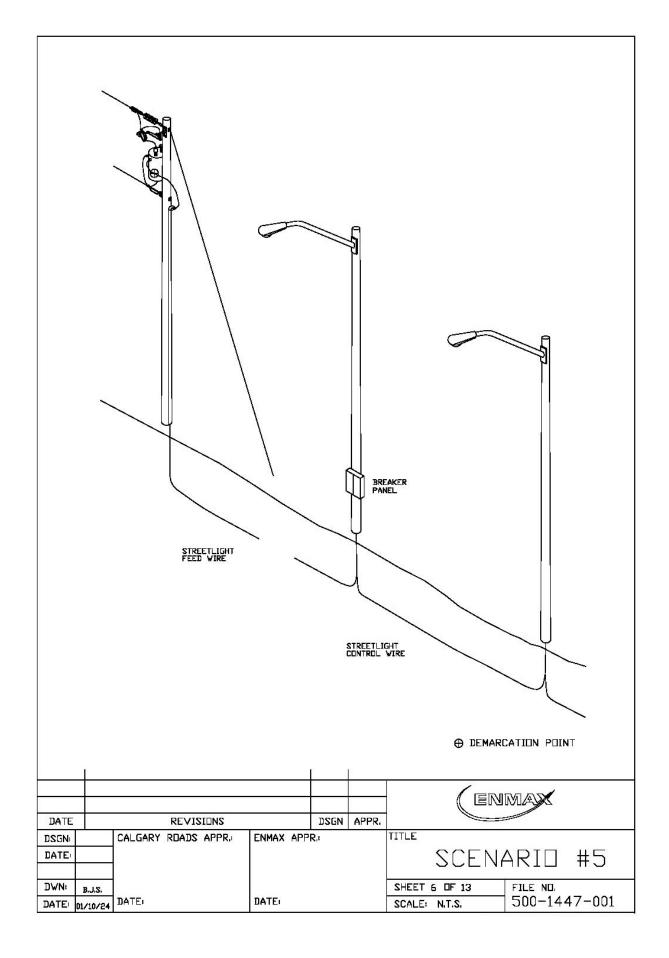


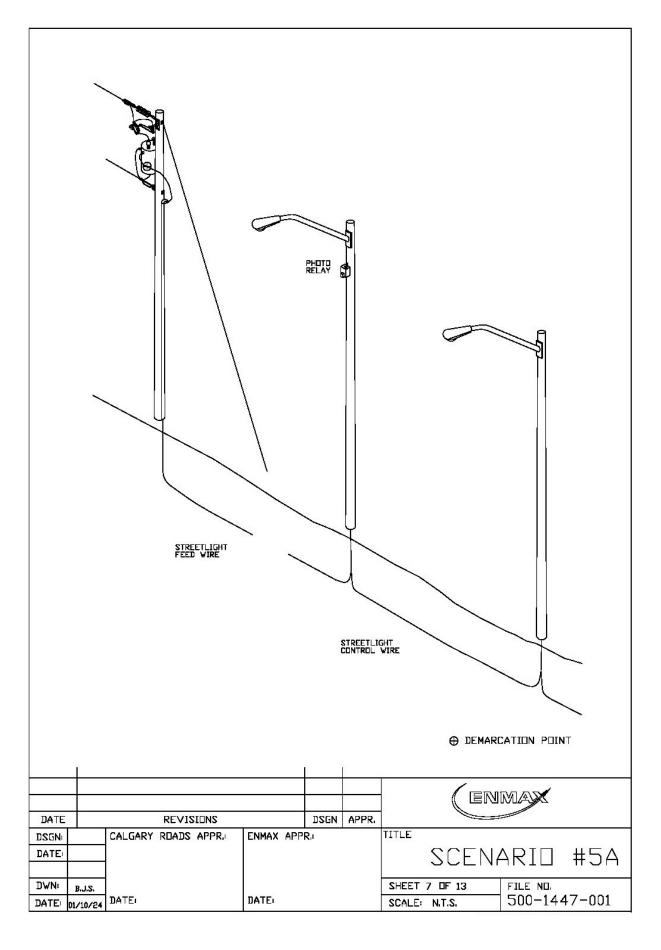


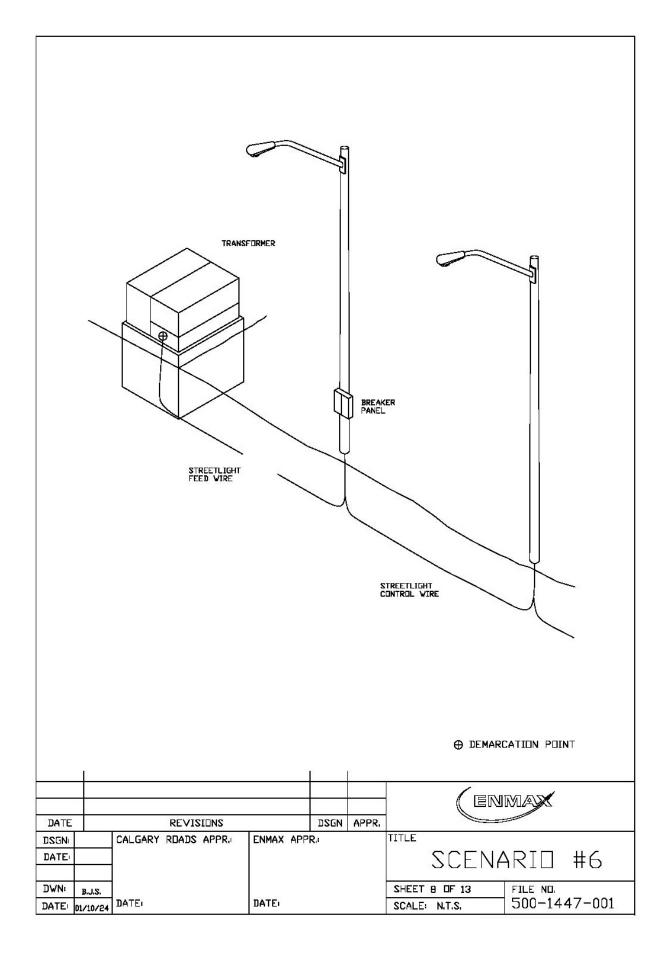

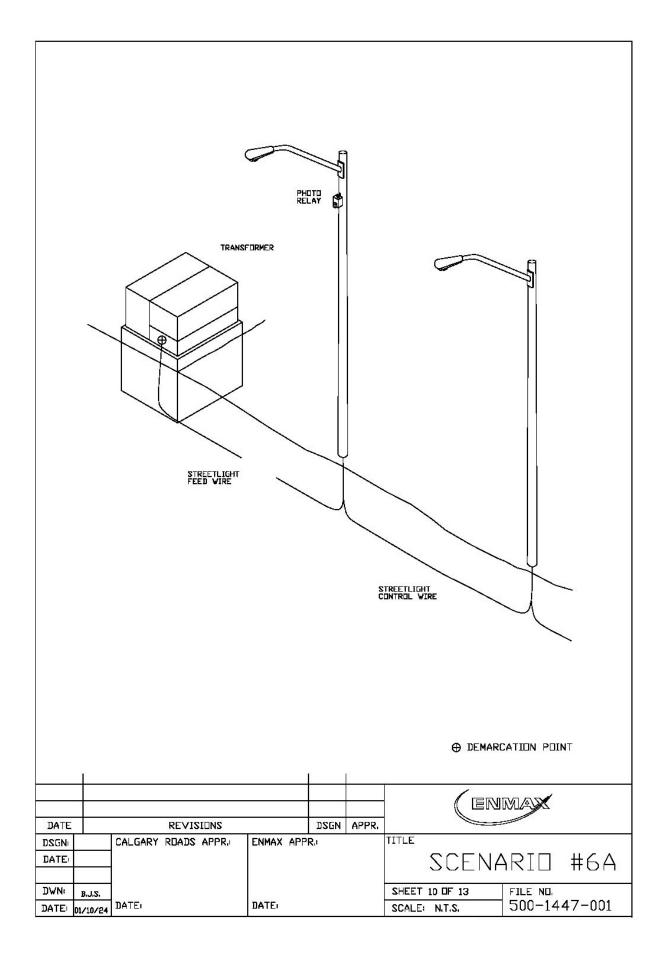

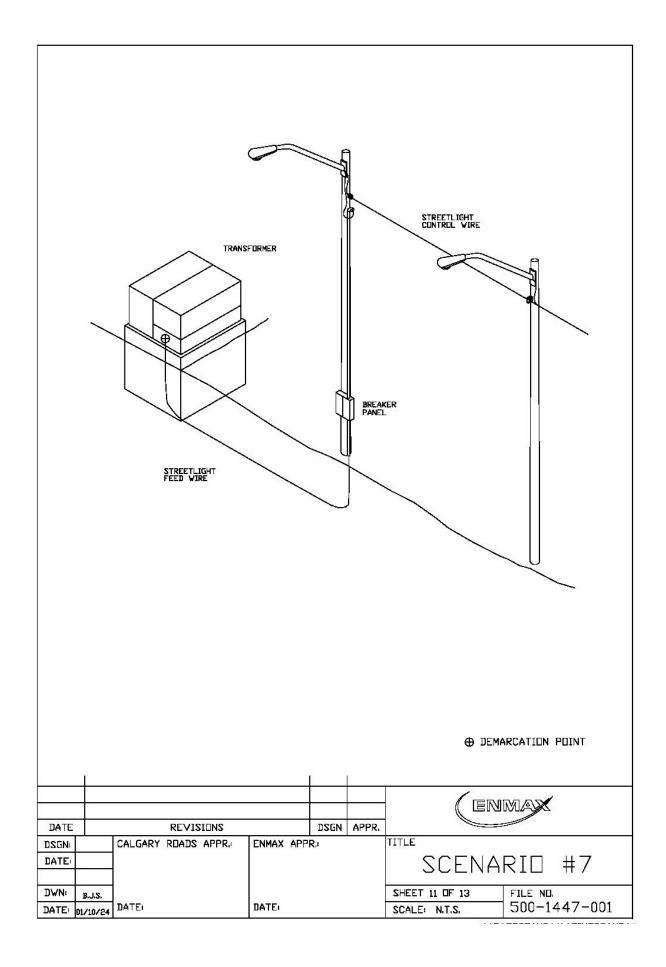

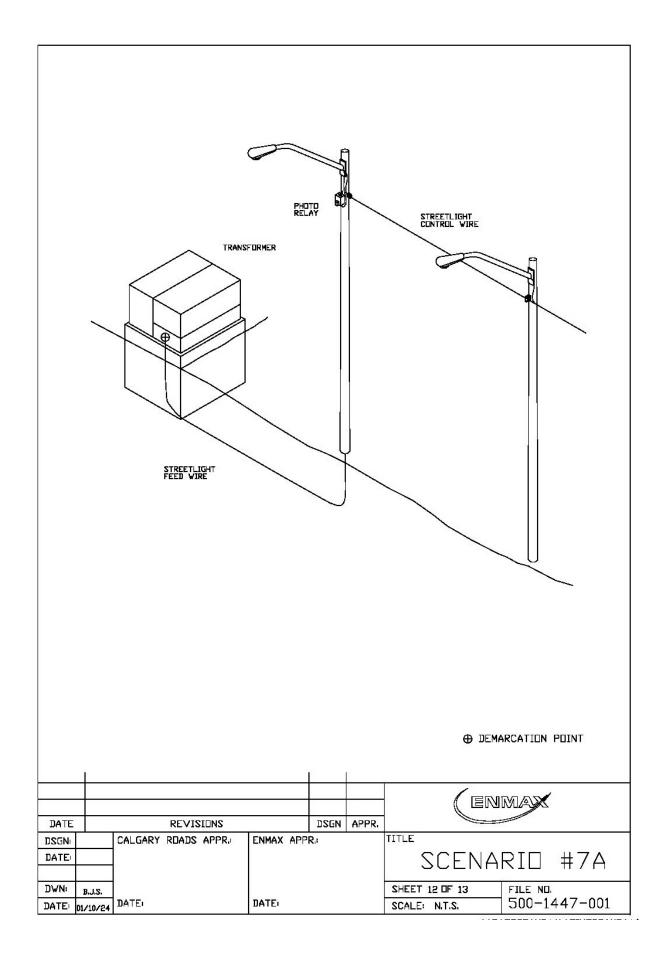

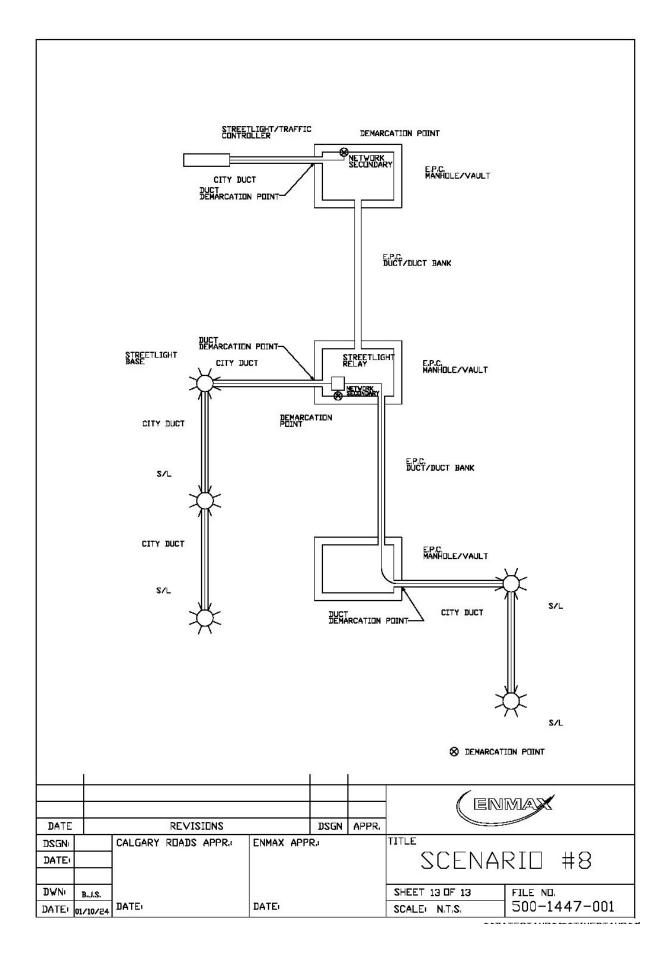



## **APPENDIX G**


## STREETLIGHTING DESIGN & CONSTRUCTION PROCESS DIAGRAMS


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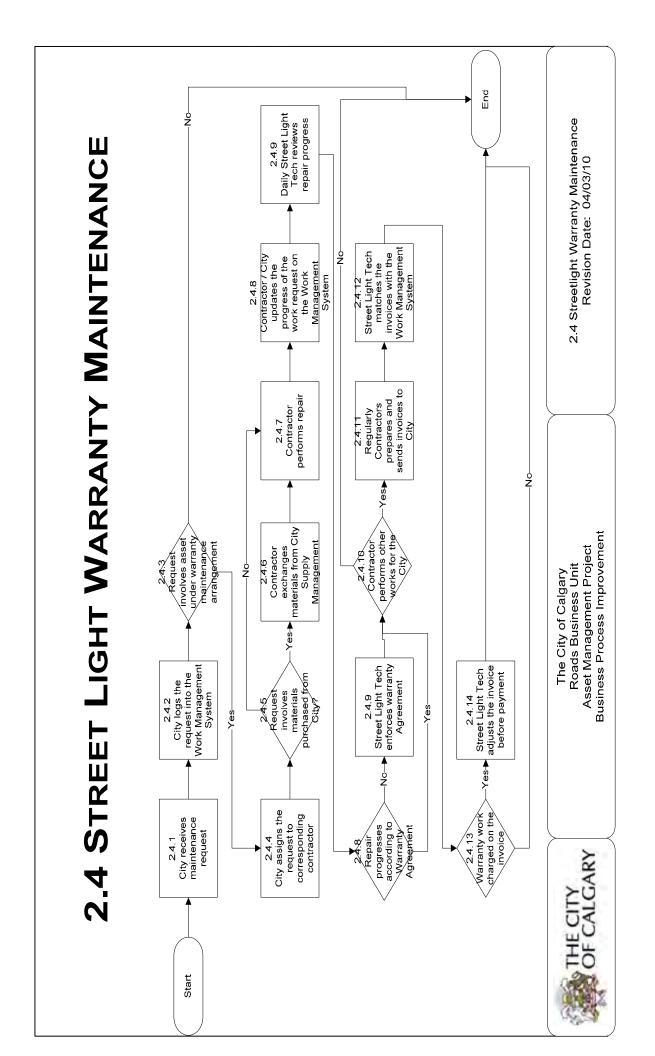
## STREET LIGHT INSTALLATION PROCESS ASSET MANAGEMENT PROJECT ROADS BUSINESS UNIT THE CITY OF CALGARY



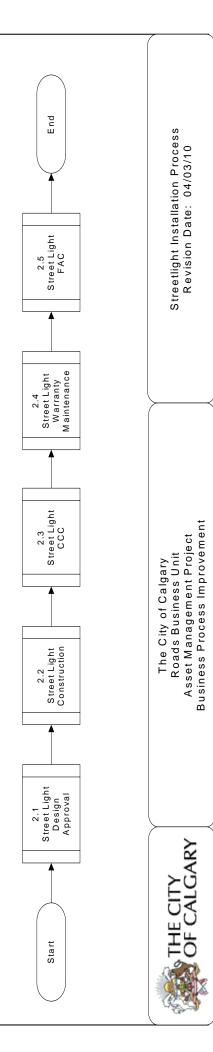


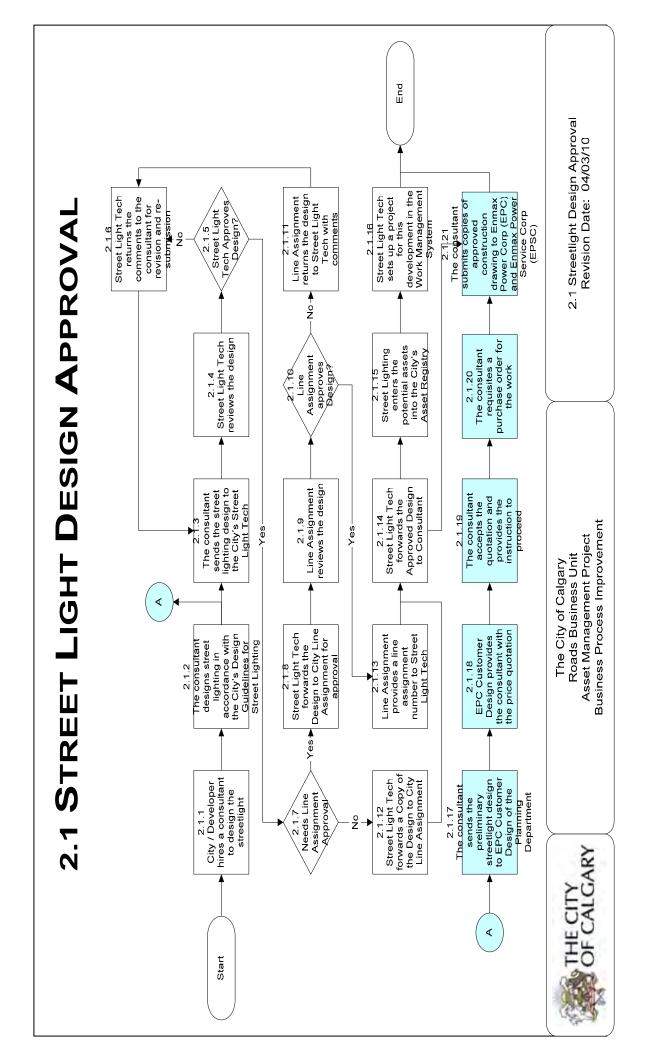

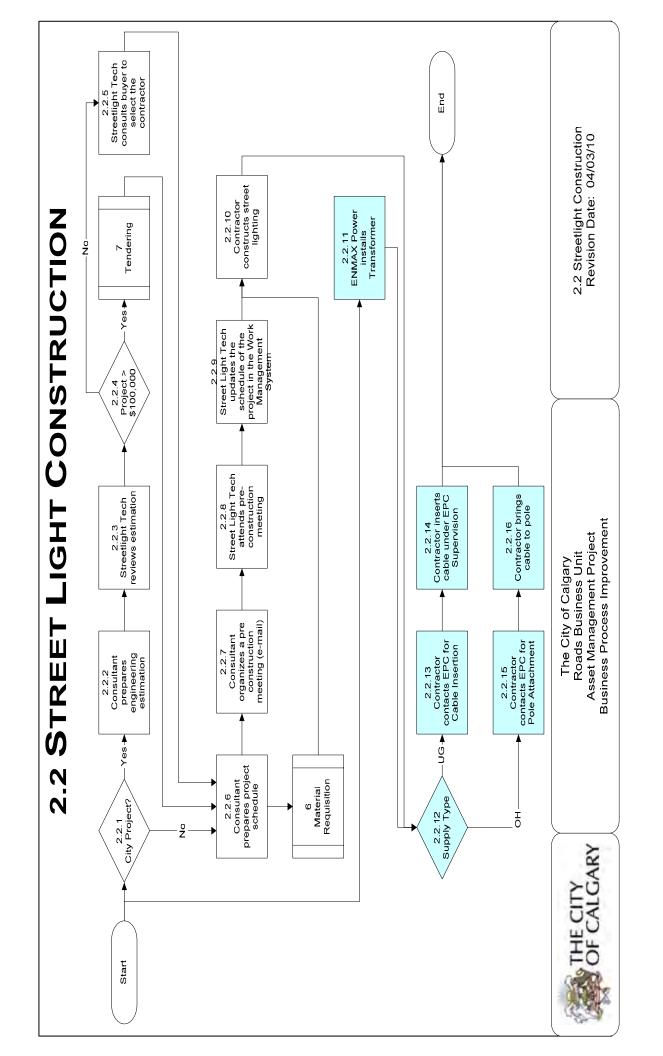

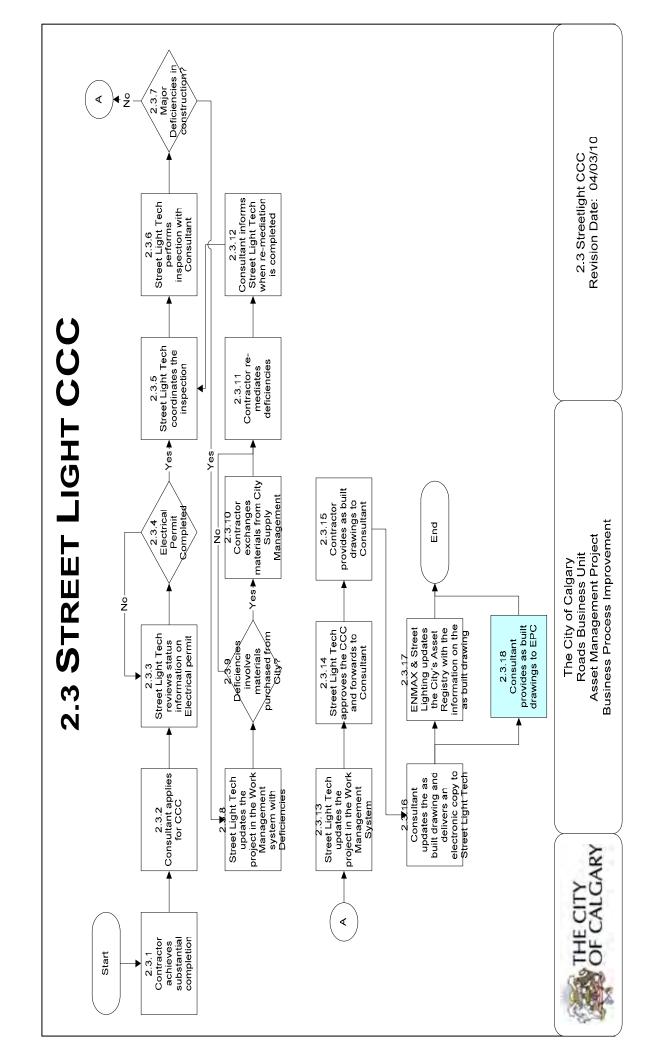

## 2.5 STREET LIGHT FAC

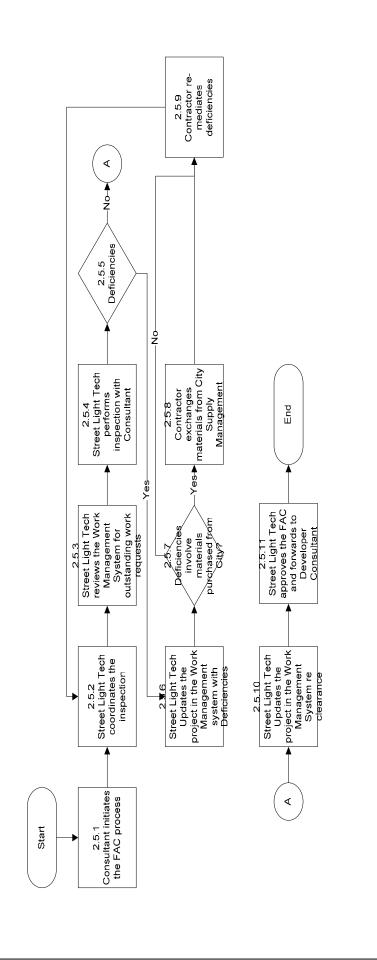


The City of Calgary
Roads Business Unit
Asset Management Project
Business Process Improvement

2.5 Streetlight FAC Revision Date: 04/03/10



## 3.0 STREETLIGHT ELECTRICAL PERMIT ASSET MANAGEMENT PROJECT ROADS BUSINESS UNIT THE CITY OF CALGARY

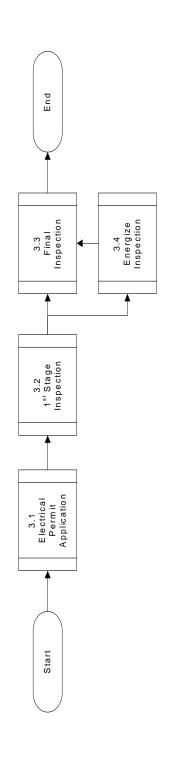


THE CITY OF CALGARY

The City of Calgary Roads Business Unit Asset Management Project Business Process Improvement

3.0 Streetlight Electrical Permit Revision Date: 04/03/10

# 3.1 ELECTRICAL PERMIT APPLICATION

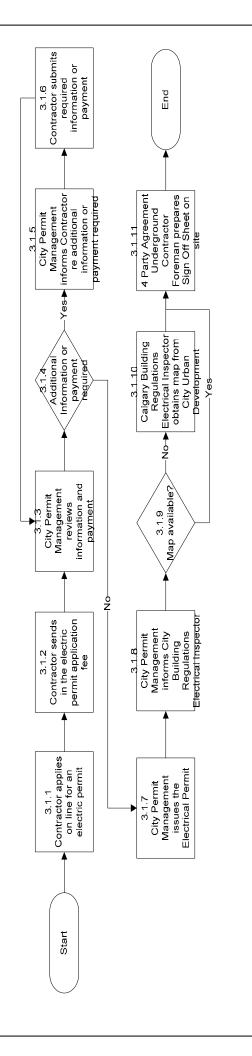


The City of Calgary Roads Business Unit Asset Management Project Business Process Improvement

3.1 Electrical Permit Application Revision Date: 04/03/10



## 3.2 1<sup>ST</sup> STAGE INSPECTION

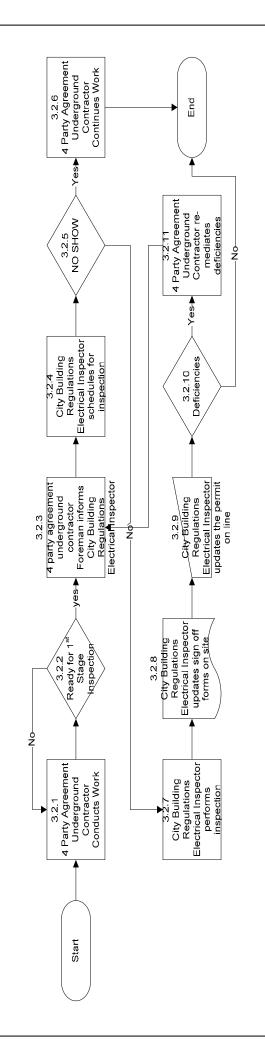


The City of Calgary Roads Business Unit Asset Management Project Business Process Improvement

3.2 1<sup>st</sup> Stage Inspection Revision Date: 04/03/10



# 3.3 ELECTRICAL FINAL INSPECTION

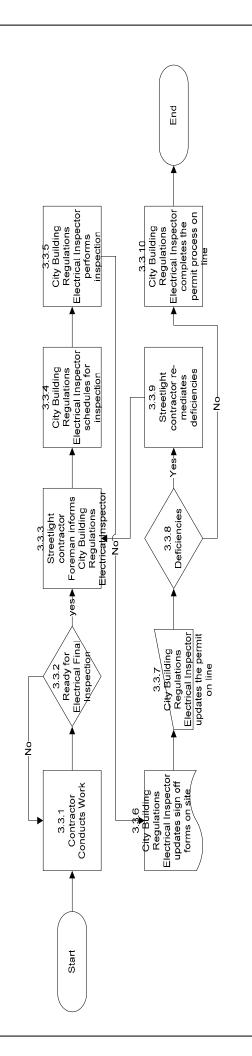


The City of Calgary Roads Business Unit Asset Management Project Business Process Improvement

3.3 Electrical Final Inspection Revision Date: 04/03/10



## 3.4 ENERGIZE INSPECTION

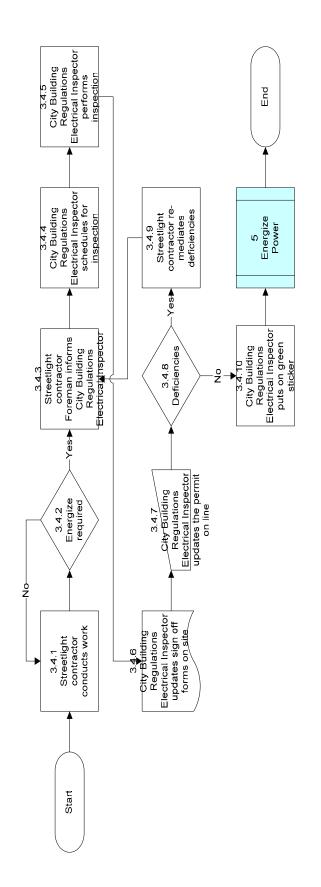


The City of Calgary Roads Business Unit Asset Management Project Business Process Improvement

3.4 Energize Inspection Revision Date: 04/03/10





# 4.0 ELECTRICAL SPOT INSPECTION

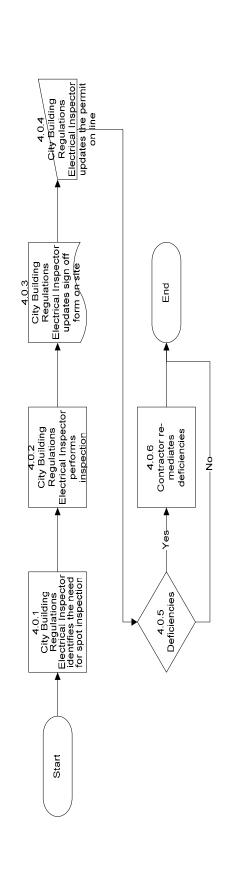


**Business Process Improvement** The City of Calgary Roads Business Unit Asset Management Project

4.0 Electrical Spot Inspection Revision Date: 04/03/10

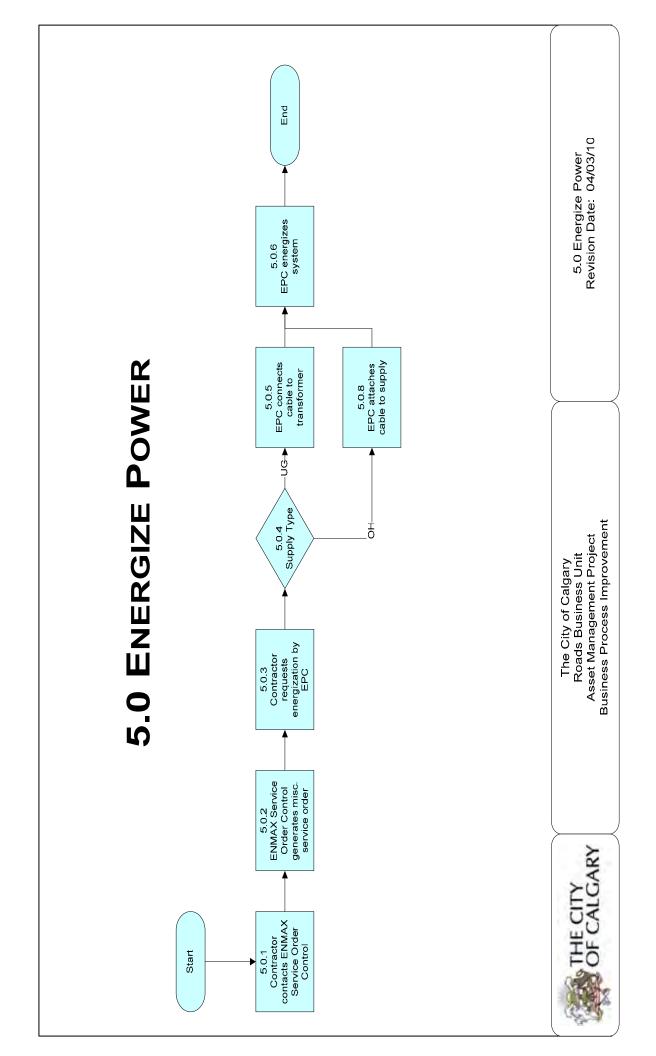

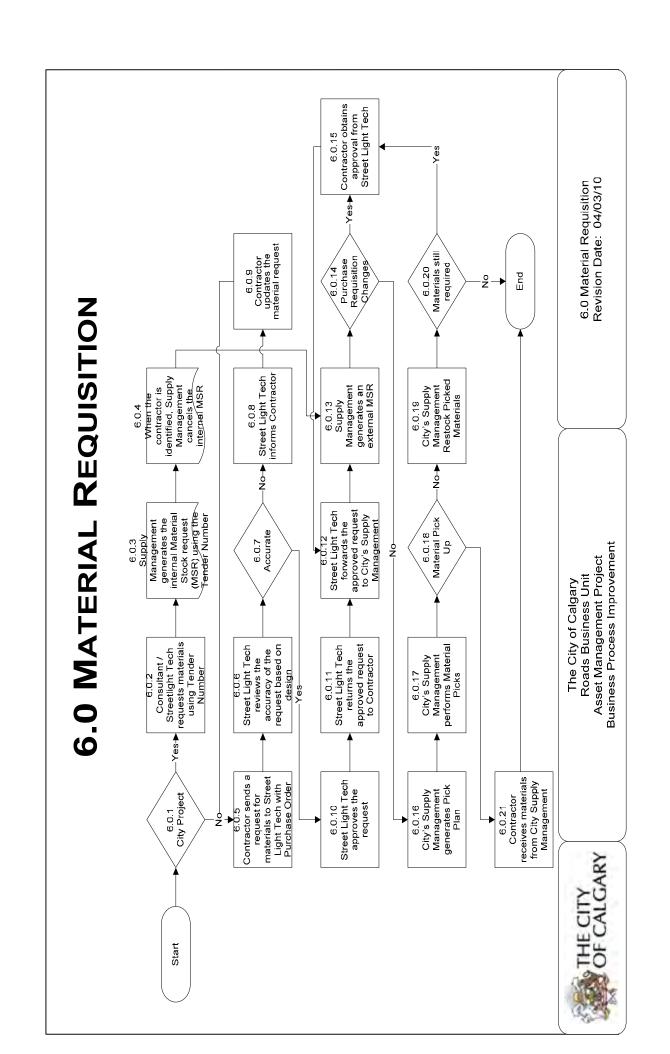

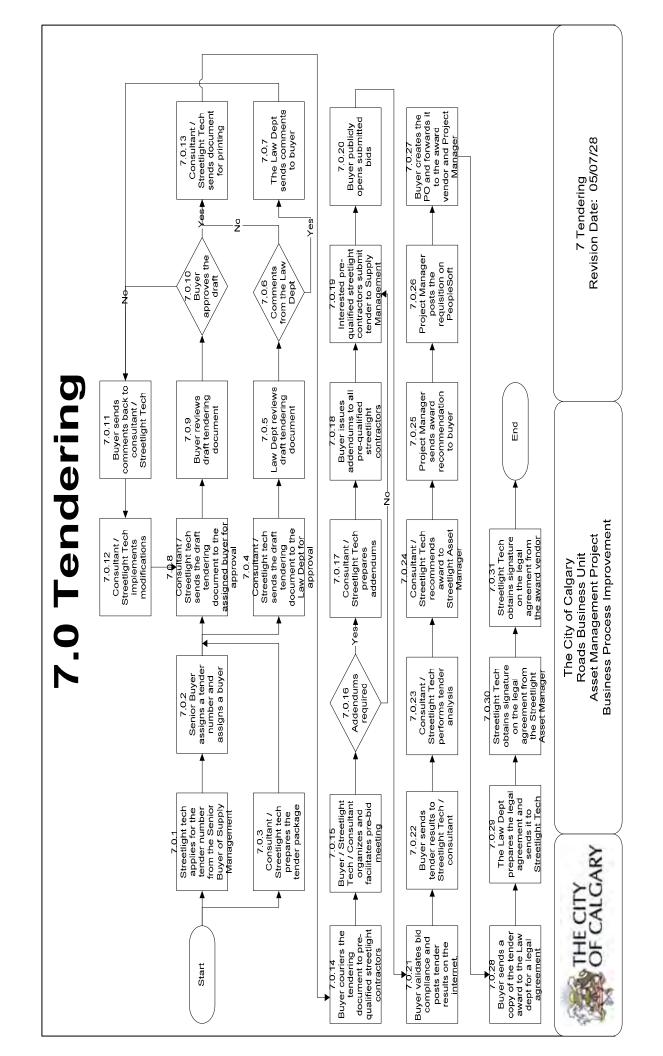

## **APPENDIX H**

## LIST OF PRE-QUALIFIED STREETLIGHTING CONTRACTORS

## VALID AT TIME OF PRINTING FOR UPDATES PLEASE CONTACT SUPPLY AT 268-1843

## List of Pre-qualified Streetlighting Contractors . (Street Lighting Installation Pre-Qualification 04-009)

NAME OF FIRM	ADDRESS	PHONE NUMBER	FAX NUMBER	E-MAIL
ACE CONSTRUCTION COMPANY INC.	5720 – 4 St SE P.O. Box 5220, Stn. A Calgary, AB T2H 1X5	(403) 253-0002	(403) 253-8861	www.aceconstruction.ca
ALLIED PROJECTS LTD.	7017 Farrell Rd SE Calgary, AB T2H OT3	(403) 543-4530	(403) 543-4540	www.alliedprojects.com
DOBBYN ELECTRICAL SERVICES LTD.	9243 – 44 St SE Calgary, AB T2C 2P7	(403) 236-8877	(403) 720-2773	www.dobbynelectric.com
ENMAX POWER SERVICES CORPORATION	Enmax Place 141 – 50 Ave SE Calgary, AB T2G 4S7	(403) 514-3956	(403) 514-2049	jcyr@enmax.com
EPCOR TECHNOLOGIES INC.	13410 St Albert Trail Edmonton, AB T5L 4P2	(780) 412-7697	(780) 412-3888	mfahner@epcor.ca
MCGREGOR CONSTRUCTION 2000 LTD.	9925 – 62 Ave Edmonton, AB T6E OE7	(780) 437-1340	(780) 435-1493	wwalker@mcgregor2000.
CAN-TRAFFIC SERVICES LTD.	RR2 Site 17 Box 19 Cochrane, AB T4C 1A2	(403) 851-4972	(403) 851-4904	jade@can-traffic.ca
ACUTECH ELECTRIC LTD. (See Note 1 below)	Suite 916, 105-150 Crowfoot Cres. N.W. Calgary, AB T3G 3T2	(403) 241-5804	(403) 241-5224	autech@telusplanet.net

## NOTES:

1. Meets general prequalification but not prime contractor status.

May be approved for jobs under \$50,000. Must be under a general contractor with prime contractor status for work exceeding \$50,000.

## APPENDIX J

## STREETLIGHT CONSTRUCTION SPECIFICATIONS TOLERANCES

## **Streetlight Construction Specifications – Tolerances**

No.	WORK TO BE INSPECTED OR TESTED	REQUIREMENT/ACCEPTANCE CRITERIA	REMARKS
1.	Base location and offset	Within +/- 50mm of design location.	BW = behind walk, + 25mm to +75mm for locations with sidewalk.
		General: 150mm +/- 50mm above the final finished grade.	Measurement to be taken at the centerline of the foundation.
2.	Base elevation	Steep Slopes: Same as above, with minimum of 50mm on the high slope side of the base.	To achieve this requirement, the low slope side may be more than 200mm.
		Walkways: 150mm +/- 50mm above asphalt.	Base should be located against the edge of the lot line within the City right-of-way to maximize the clear width for pedestrians and cyclists.
3.	Base level	Base to be level after installation. No more than 2 shims (1/16" each) per bolt permitted on each pole.	The use of washers to level the pole is not acceptable.
4.	Pole plumb	Maximum ½ degree.	
5.	Base bolts	The two bolts closest to the road shall be parallel to the curb +/- 2 degrees, unless otherwise noted on the drawings. (I.e. 87mm for a 2.5m davit).	Check that banner arms are perpendicular to the road, if applicable.
6.	Base compaction	Bottom of base excavation shall be level. All disturbed soil shall be compacted to 97% maximum density.	As per the City of Calgary Roads Standard Specifications – Roads Construction 304.00.00.  Non-compactable material such as
		-	organic soil, frozen soil, and lumpy soil are not to be used.
7.	Tilting/Rotation of Luminaire	Luminaire to be level along both the short and long axis, unless otherwise noted on the drawings.	To be checked with a hand level.

## **APPENDIX K**

## BEST MANAGEMENT PRACTICE No. 1 SAW CUTTING OPERATIONS

## **Maintenance Best Practices**



THE CITY OF CALGARY
ENGINEERING & ENVIRONMENTAL SERVICES DEPARTMENT
STREETS MAINTENANCE

## STANDARD OPERATING PRACTICES

## **Saw Cutting**

Saw cutting is performed for the Street Maintenance Division to prepare job sites for excavation, resurfacing, mudjacking or repair. Due to the potential danger involved in operating this equipment, the City of Calgary requires that all personnel are fully trained for the safe operation of the saw.

Before operating the saw, the following tasks must be performed by the saw operator:

- 1. Ensure that the worksite has been set up with traffic control devices, cones and barricades as required by the Worksite Temporary Traffic Control Manual.
- 39. Inspect the job site for all Utility Locates and compare to the Locate Slip as provided by the Foreman. If the job site is missing a locate marking or the locates do not match the Locate Slip provided, do not attempt to saw cut. Contact the Crew Foreman immediately.
- 40. Perform an equipment check, including the following items:
  - Saw blade is in good condition (i.e. Wear, cracks and stability),
  - Water pump is operating properly,
  - Water hoses, valves and fittings are in good condition,
  - Water supply tanks are full (see the note below).

**NOTE:** When setting up the saw at every job site, ensure that there is enough water in the water supply tanks to complete the job. **If water is required, immediately fill the water supply tanks using the Standard Operating Practice for Hydrant Operation.** 

*To set up the saw cutting operation:* 

As required, set up all curb ramps for the saw to mount the curb.

Unload the saw from the trailer, ensuring that the blade does not rub or bump against the trailer.

Position the saw so that the blade is on the same side as the excavation.

Hook up the water supply lines from the water pump to the saw.

Start the water pump.

Ensure that water is being pumped onto the saw blade.

To safely and efficiently operate the saw, observe the following practices during operation:

- Ensure that the water supply to the blade is adequate. If the saw runs out of water, STOP IMMEDIATELY. Reference the Hydrant Operation S.O.P. for filling instructions.
- **Do not "Undercut".** When the blade starts cutting through the gravel base below the asphalt or concrete surface, water will be lost for blade lubrication, and blade damage will occur.
- **Practice the proper "Step cutting" techniques.** This practice will dramatically extend the saw blade lifespan and ensure that the job is completed quickly.
- Do not leave the saw unattended while it is unloaded.
- Do not attempt to service the saw or blade while the saw motor is operating.

## The following personal protective equipment is required for the safe operation of the saw:

- Safety boots
- Hard hat
- Safety vest
- Gloves
- Ear protection
- Eye or full face protection

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